



MAIN STREET TRIANGLE PARKING STRUCTURE

9650 143rd Street
Orland Park, Illinois

PROGRESS DWGS - 01/22/2016

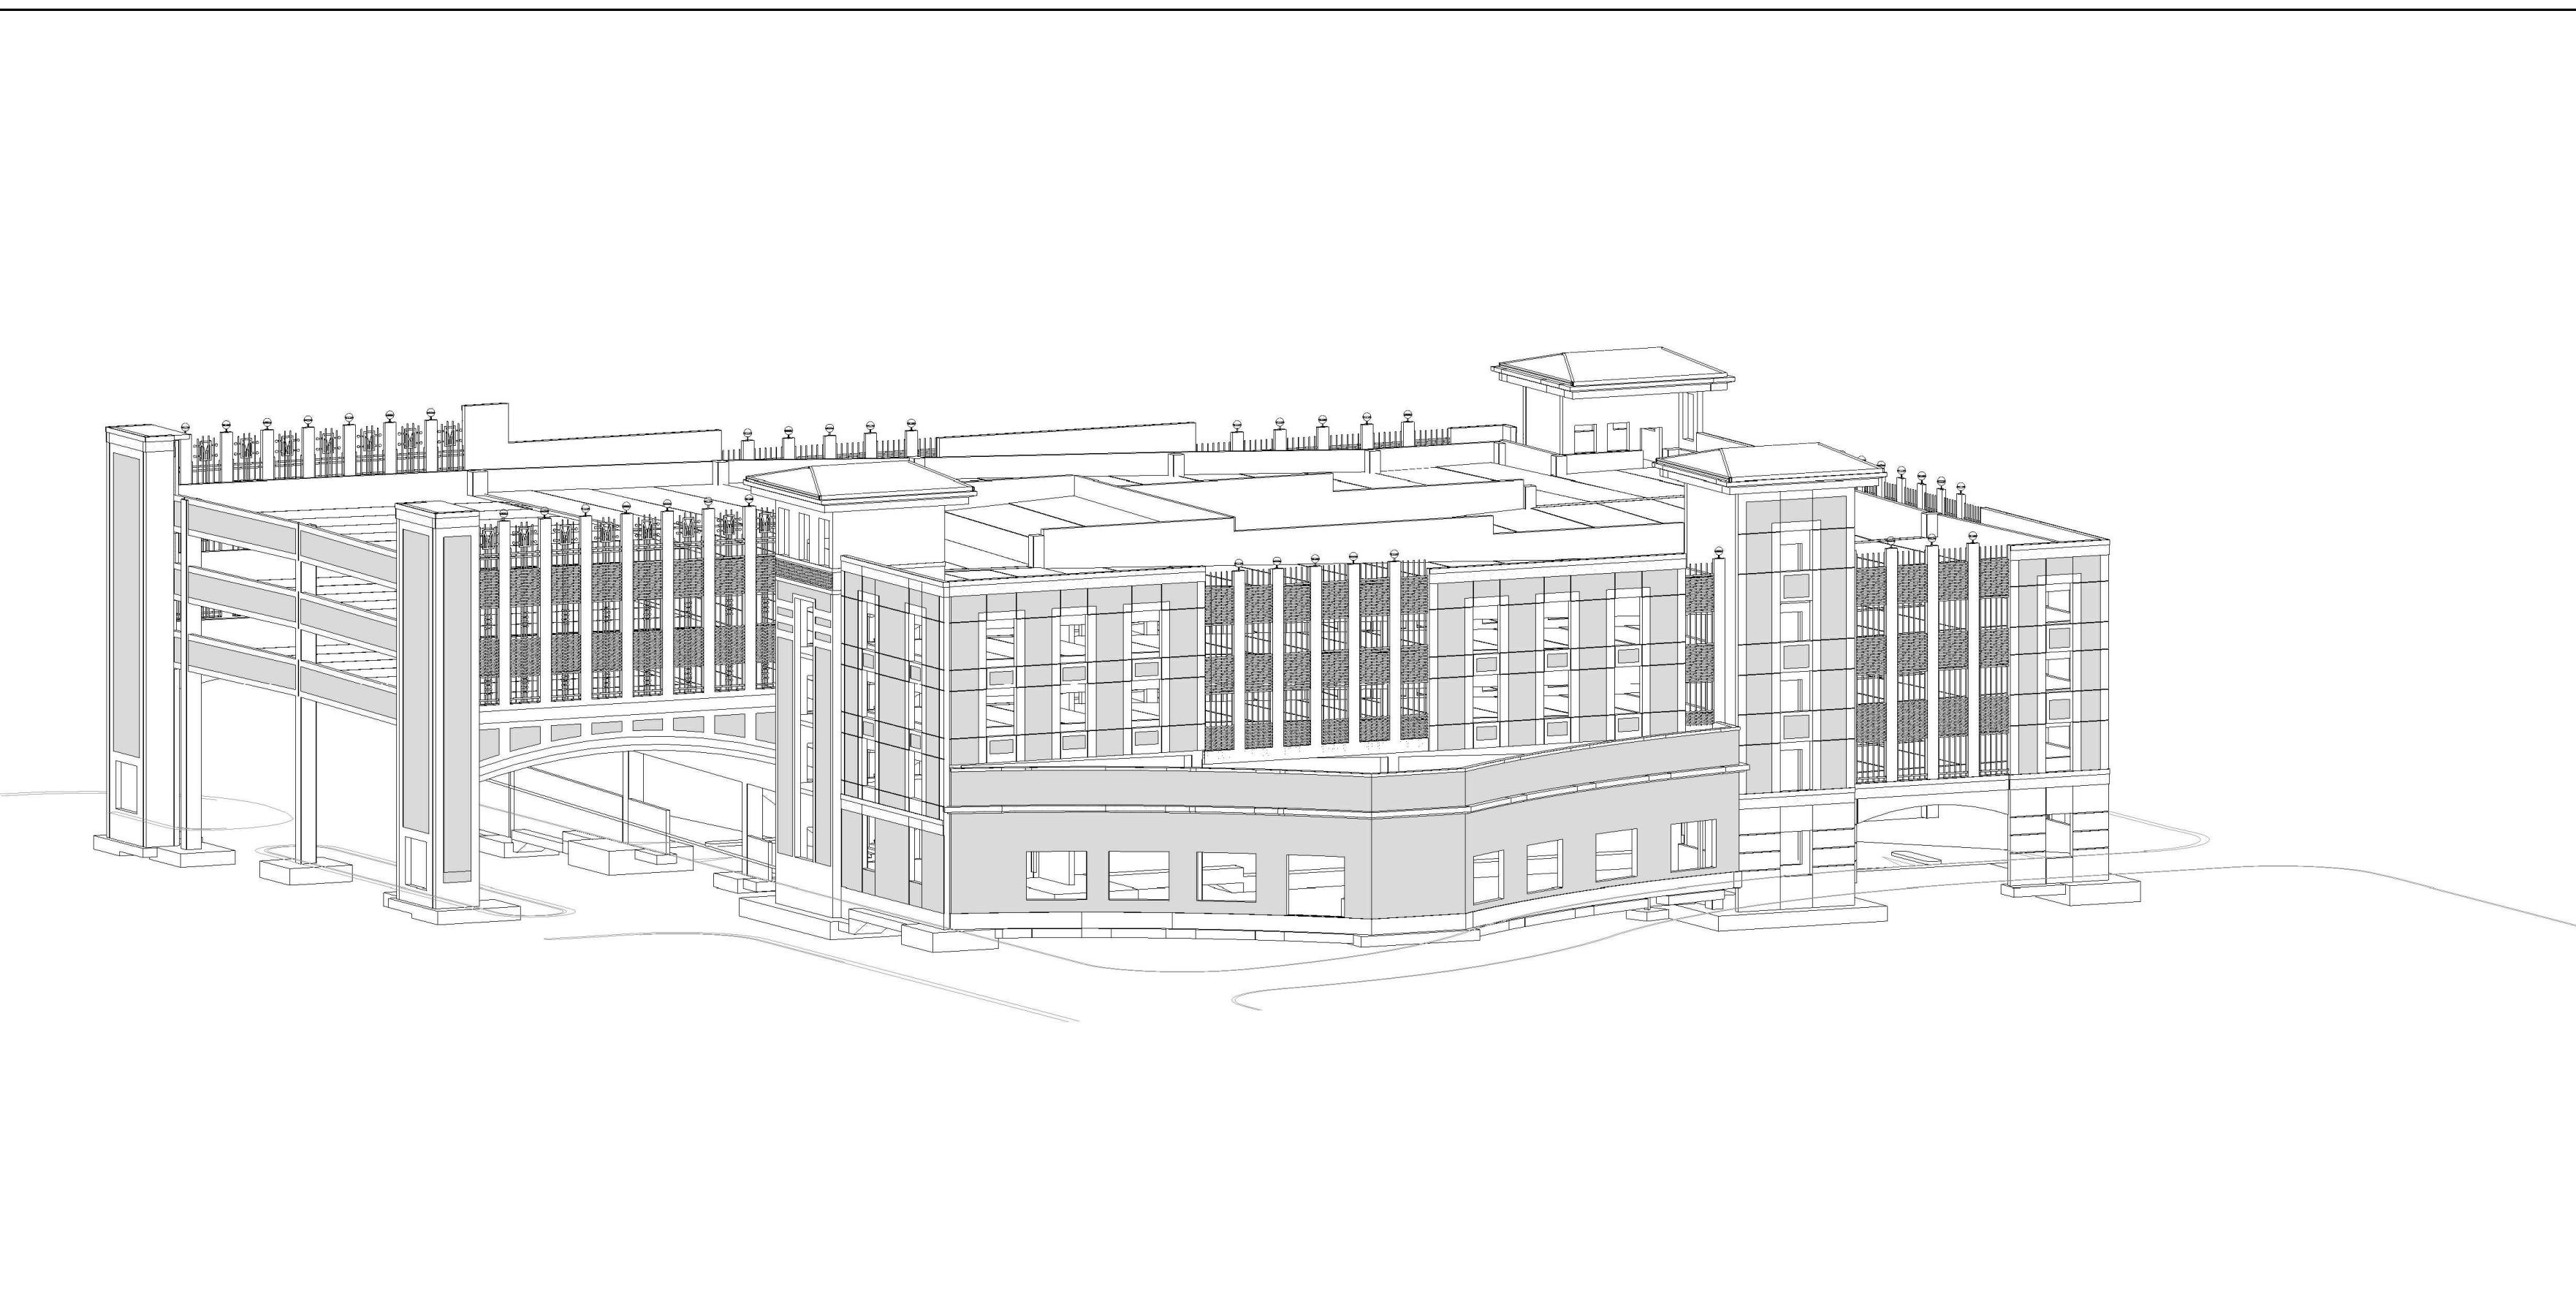

PROJECT DIRECTORY	<u>OWNER</u>	<u>PRIME CONSULTANT/STRUCTURAL PARKING</u>	<u>ARCHITECT</u>	<u>CIVIL</u>
 VILLAGE OF ORLAND PARK ILLINOIS	Village of Orland Park 14700 S. Ravina Ave. Orland Park, IL 60462 Phone 708-403-6100	Carl Walker 1920 S. Highland Ave - Suite 210 Lombard, IL 60148 Phone 630.307.3800	Carl Walker 5136 Lovers Lane - Suite 200 Kalamazoo, MI 49002 Phone 269.381.2222	 V3 Companies 7325 Janes Avenue Woodridge, IL 60517 630.724.9200 phone 630.724.9202 fax www.v3co.com

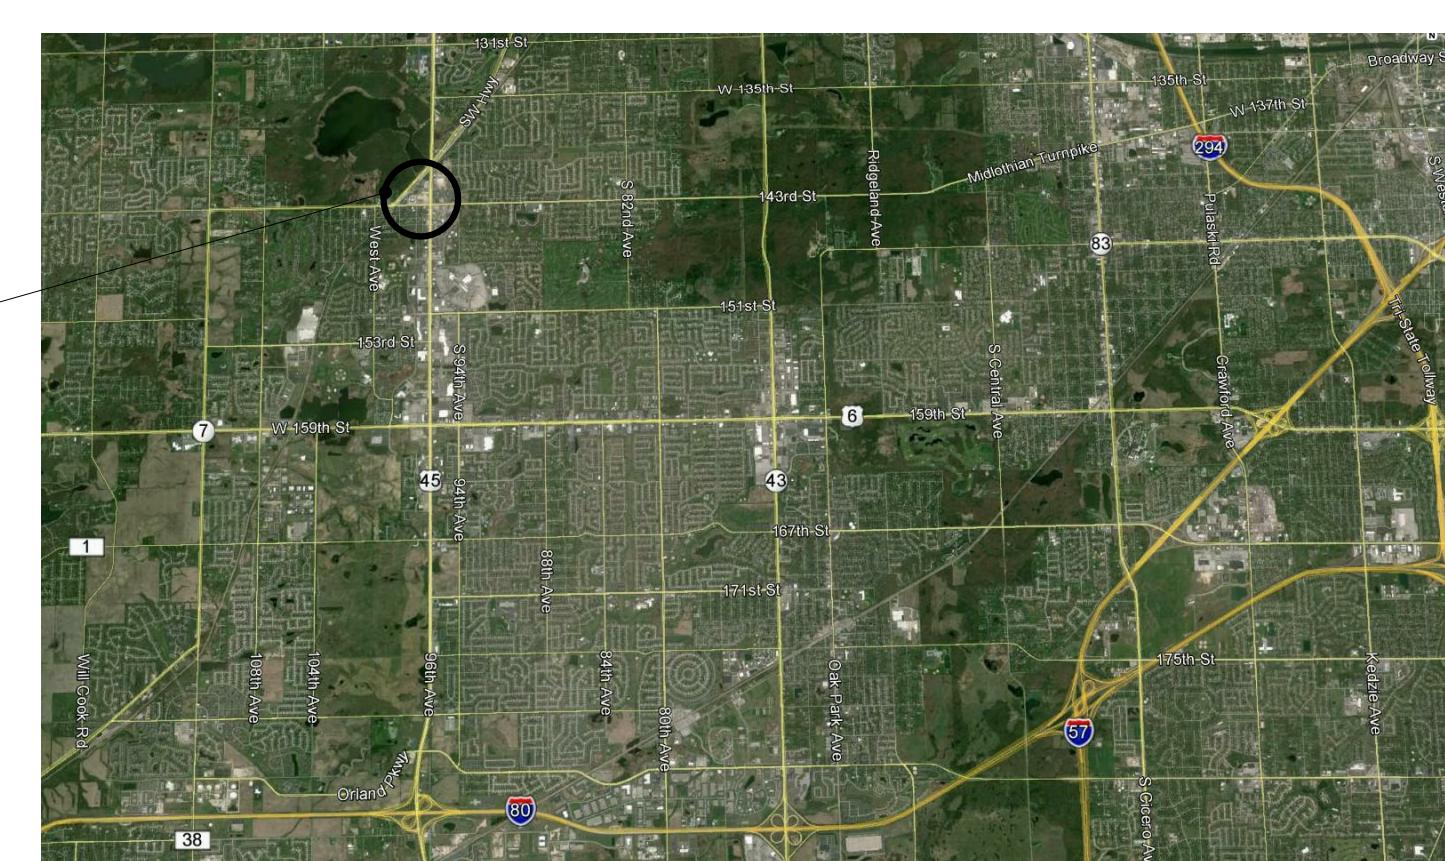

GENERAL	
SHEET #	SHEET TITLE
G-001	COVER SHEET AND DRAWING INDEX
G-002	CODE SUMMARY - GENERAL
G-003	CODE WALKING DISTANCE PLANS - GENERAL
G-004	CODE OPENNESS - GENERAL

STRUCTURAL	
SHEET #	SHEET TITLE
S-001	GENERAL NOTES - STRUCTURAL
S-002	GENERAL NOTES - STRUCTURAL
S-100	FOUNDATION PLAN - STRUCTURAL
S-101	LEVEL 1 PLAN - STRUCTURAL
S-102	LEVEL 2 PLAN - STRUCTURAL
S-103	LEVEL 3 PLAN - STRUCTURAL
S-104	LEVEL 4 PLAN - STRUCTURAL
S-105	LEVEL 5 PLAN - STRUCTURAL
S-201	BUILDING ELEVATIONS - STRUCTURAL
S-202	BUILDING ELEVATIONS - STRUCTURAL
S-211	EAST TOWER ELEVATED WALLS - STRUCTURAL
S-221	SOUTH TOWER ELEVATED WALLS - STRUCTURAL
S-301	BUILDING SECTIONS - STRUCTURAL
S-401	NORTH TOWER ENLARGED PLANS - STRUCTURAL
S-402	NORTH TOWER ENLARGED PLANS - STRUCTURAL
S-411	EAST TOWER ENLARGED PLANS - STRUCTURAL
S-412	EAST TOWER ENLARGED PLANS - STRUCTURAL
S-421	SOUTH TOWER ENLARGED PLANS - STRUCTURAL
S-422	SOUTH TOWER ENLARGED PLANS - STRUCTURAL
S-431	ENLARGED PLANS - STRUCTURAL
S-441	RESTAURANT ROOF - LEVEL 2 - STRUCTURAL
S-501	TYPICAL SLAB ON GRADE & FOUNDATION DETAILS - STRUCTURAL
S-502	FOUNDATION DETAILS - STRUCTURAL
S-503	FOUNDATION DETAILS - STRUCTURAL
S-511	PCC COLUMN DETAILS - STRUCTURAL
S-521	PCC FRAMING DETAILS - STRUCTURAL
S-525	STEEL FRAMING DETAILS - STRUCTURAL
S-531	PCC BEAM DETAILS - STRUCTURAL
S-539	PCC CONNECTION DETAILS - STRUCTURAL
S-541	WATERPROOFING DETAILS - STRUCTURAL
S-542	WATERPROOFING DETAILS - STRUCTURAL
S-551	STANDARD & MISCELLANEOUS DETAILS - STRUCTURAL
S-601	FOUNDATION SCHEDULE & DETAILS - STRUCTURAL
S-611	PCC COLUMN SCHEDULE - STRUCTURAL
S-621	LOADING DIAGRAMS - STRUCTURAL
S-622	LOADING DIAGRAMS - STRUCTURAL

ARCHITECTURAL	
SHEET #	SHEET TITLE
A-101	LEVEL 1 PLAN - ARCHITECTURAL
A-102	LEVEL 2 PLAN - ARCHITECTURAL
A-103	LEVEL 3 PLAN - ARCHITECTURAL
A-104	LEVEL 4 PLAN - ARCHITECTURAL
A-105	LEVEL 5 PLAN - ARCHITECTURAL
A-201	BUILDING ELEVATIONS - ARCHITECTURAL
A-202	BUILDING ELEVATIONS - ARCHITECTURAL
A-301	WALL SECTIONS - ARCHITECTURAL
A-302	WALL SECTIONS - ARCHITECTURAL
A-511	STRIPING DETAILS - ARCHITECTURAL
A-521	SIGN DETAILS - ARCHITECTURAL
A-522	SIGN DETAILS - ARCHITECTURAL
A-531	SIGN MOUNTING DETAILS - ARCHITECTURAL
A-611	SIGN SCHEDULE & SIGN COMPONENTS - ARCHITECTURAL

MAIN STREET TRIANGLE PARKING STRUCTURE

9650 143rd Street
Orland Park, Illinois

NOT FOR CONSTRUCTION

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SHEET TITLE
COVER SHEET AND
DRAWING INDEX


G-001



Walsh Construction Company
929 West Adams
Chicago, Illinois 60607
Phone: (312) 563-5400


**MAIN STREET
TRIANGLE
PARKING
STRUCTURE**

ORLAND PARK,
ILLINOIS

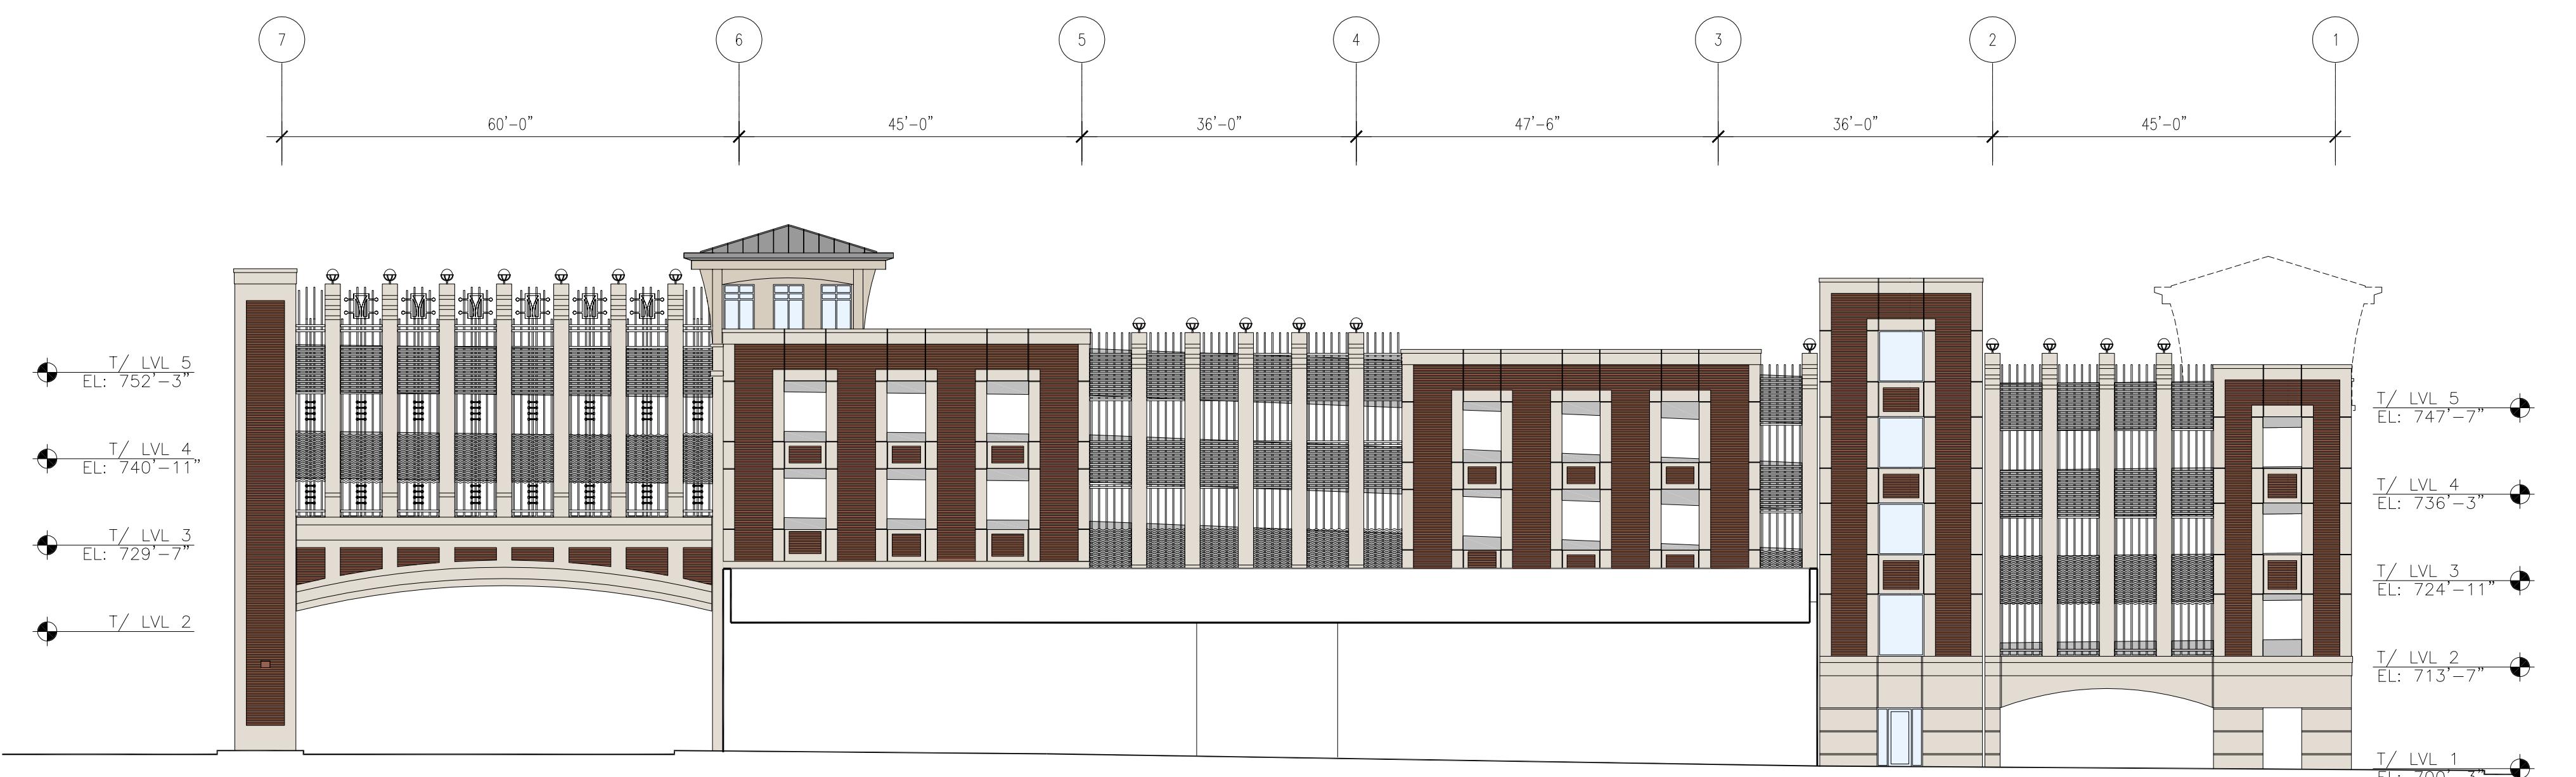

1 NORTH ELEVATION - ARCHITECTURAL

1/16" = 1'-0"

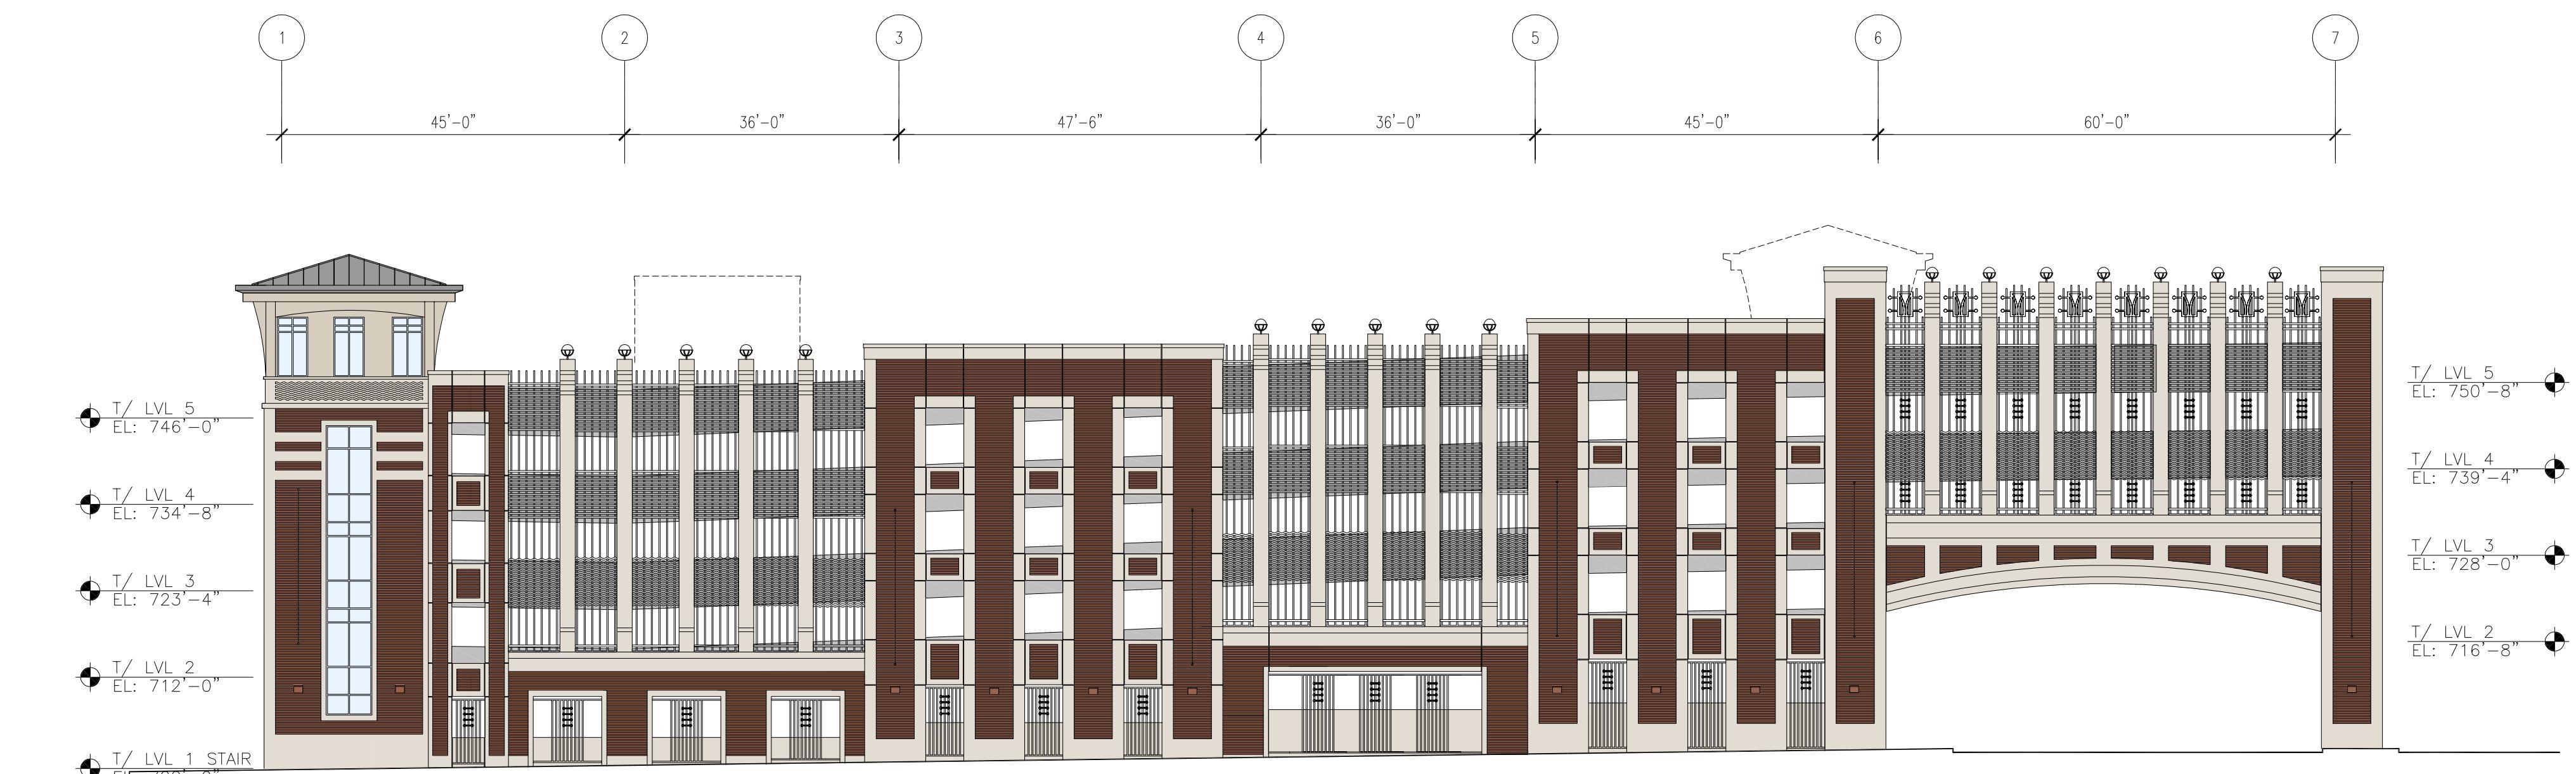

2 SOUTH ELEVATION - ARCHITECTURAL

1/16" = 1'-0"

**NOT FOR
CONSTRUCTION**

ISSUE FOR	Plan Review
ISSUED FOR DATE	1/14/2016
ISSUE REV. NO.	DATE

PROJECT NO. N1-2015-196
DRAWN BY Ray Mulvane
CHECKED BY Russ Randall



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SHEET TITLE
**ELEVATIONS -
ARCHITECTURAL**



**MAIN STREET
TRIANGLE
PARKING
STRUCTURE**

ORLAND PARK,
ILLINOIS

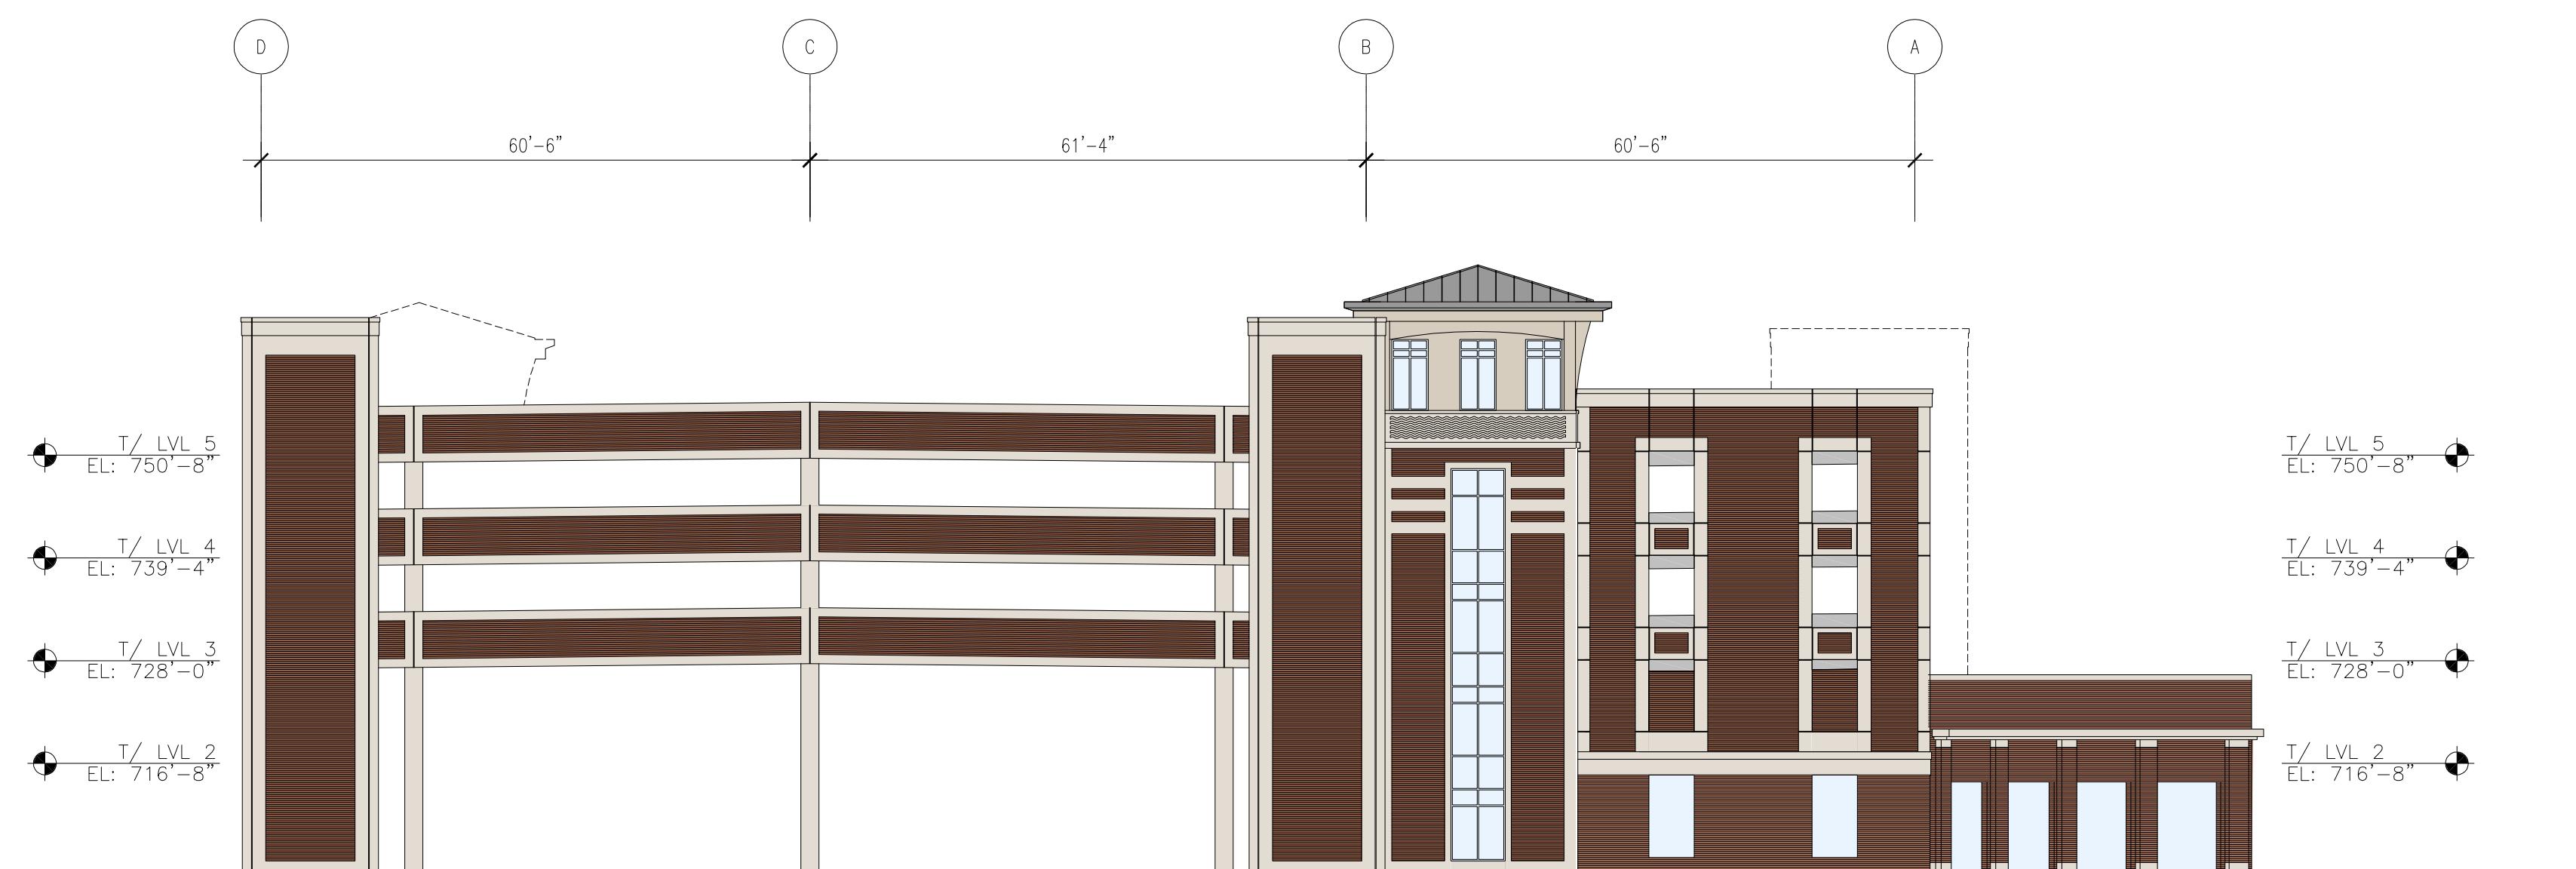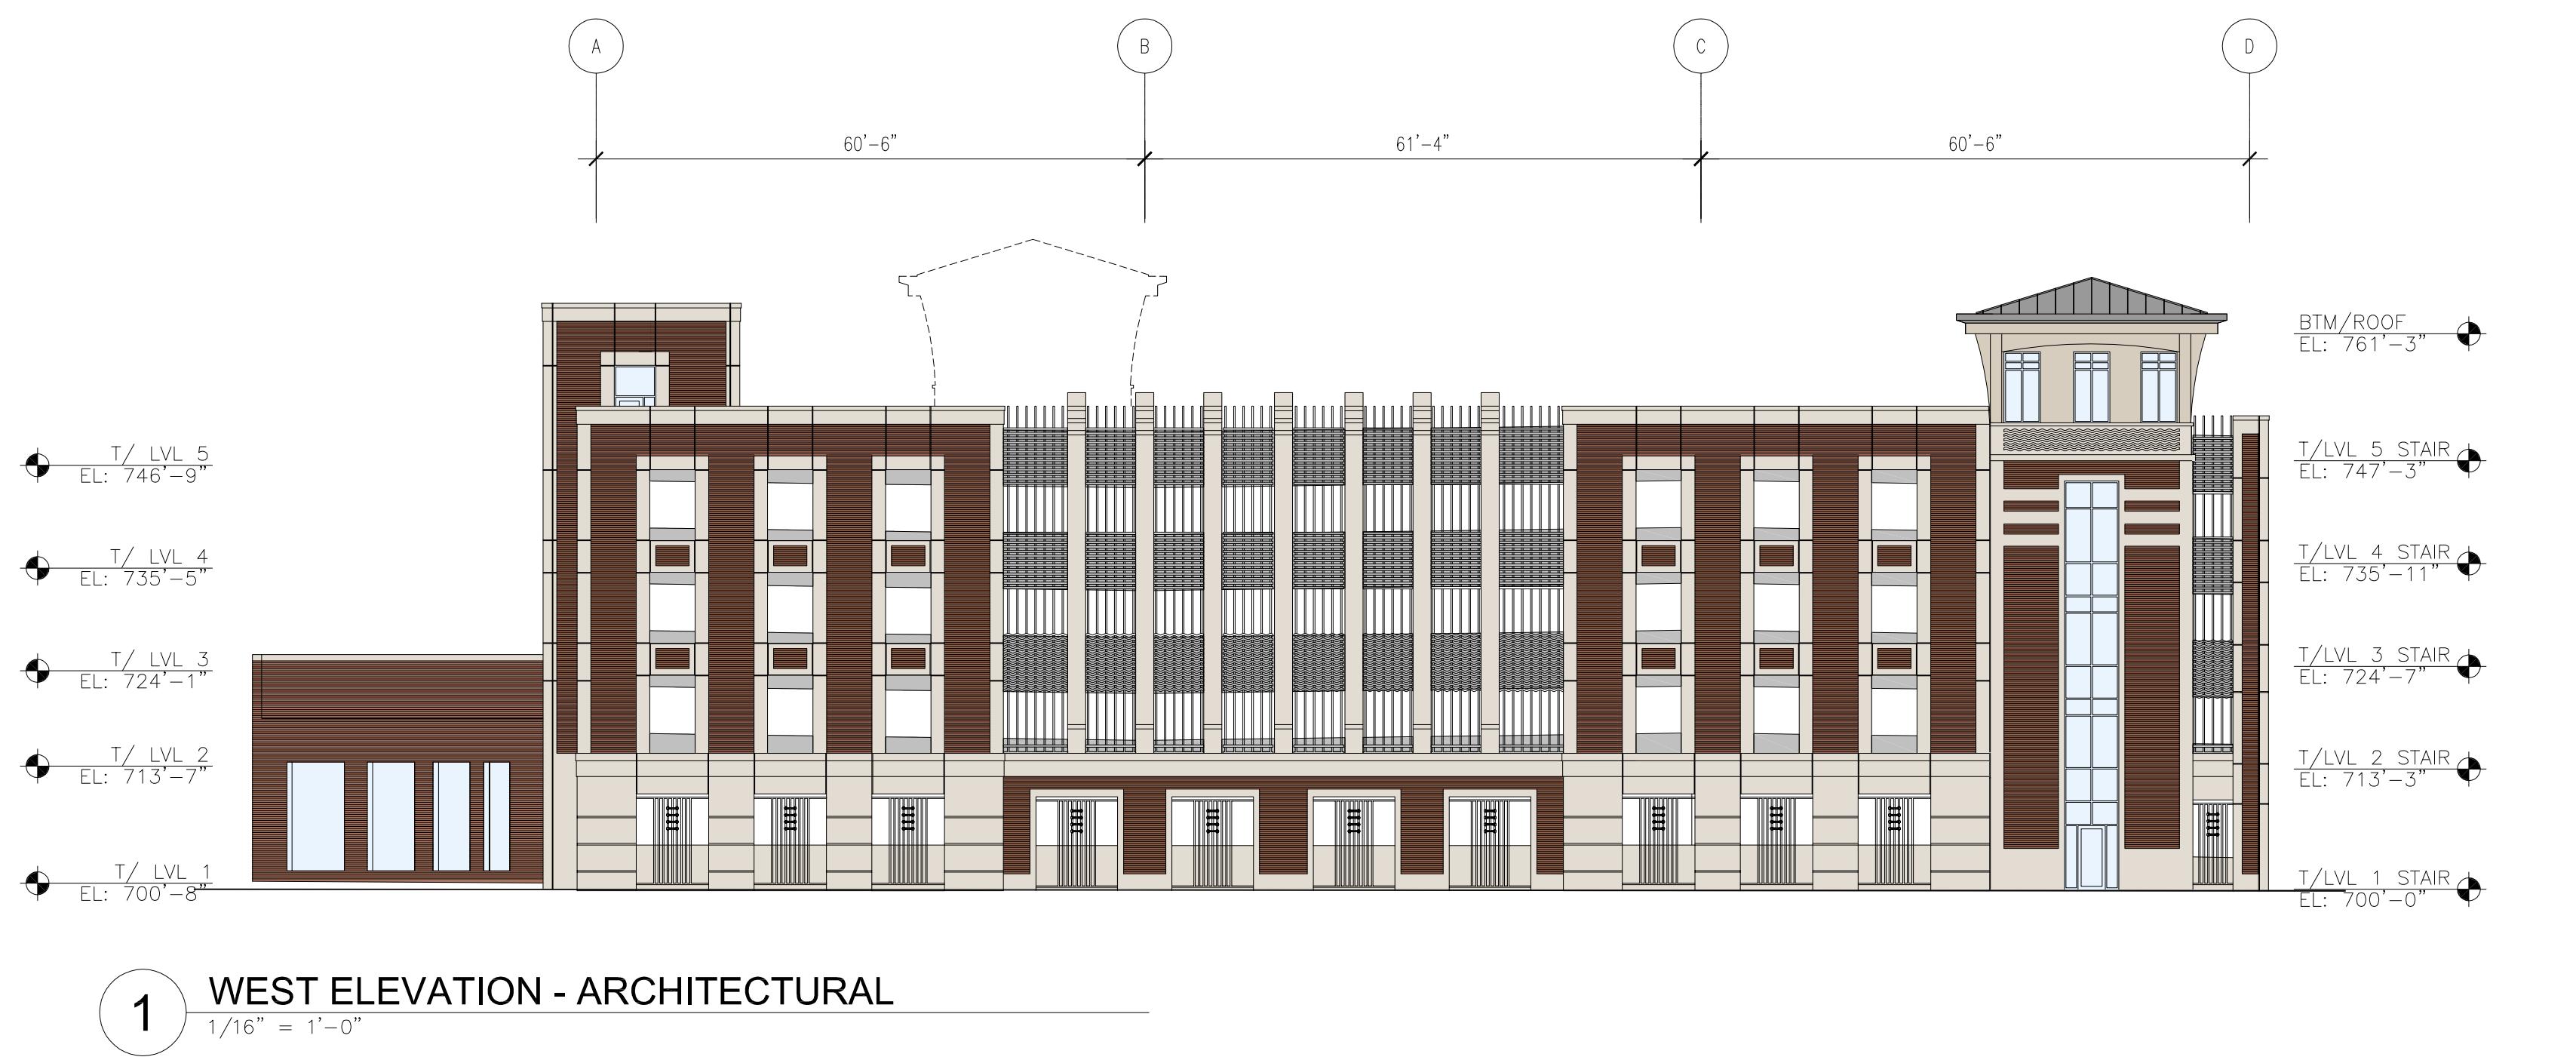

2 EAST ELEVATION - ARCHITECTURAL
1/16" = 1'-0"



B VIEW FROM SOUTH WEST
SCALE: NTS



A VIEW FROM NORTH EAST
SCALE: NTS



PHOTOGRAPH OF ACTUAL BRICK & PRECAST MOCK-UP



Walsh Construction Company
 929 West Adams
 Chicago, Illinois 60607
 Phone: (312) 563-5400

SHEET NOTES:

1. REPRESENTS PLAN MATCH
2. FOR GENERAL NOTES, REFER TO DRAWINGS S-001.
3. FOR EXPLANATION OF NOTATIONS AND ABBREVIATIONS, REFER TO GENERAL NOTES, DRAWING S-001.
4. PARKING SPACE STRIPING TO BE 4" WIDE TRAFFIC YELLOW STRIPING - SINGLE LINE CONFIGURATION. ALSO REFER TO SHEET A-511 FOR ADDITIONAL STRIPING INFORMATION.
5. CROSS HATCH STRIPING TO BE 4" WIDE TRAFFIC YELLOW STRIPING AT 24" OC AS SHOWN IN PLANS, REFER TO SHEET A-511 FOR ADDITIONAL INFORMATION.
6. DIRECTIONAL ARROWS TO BE PAINTED IN TRAFFIC YELLOW AS SHOWN ON PLANS. REFER TO SHEET A-511 FOR ADDITIONAL INFORMATION.
7. PAVEMENT GRAPHICS TO BE PAINTED IN TRAFFIC YELLOW AS SHOWN ON PLANS. REFER TO SHEET A-511 FOR ADDITIONAL INFORMATION.
8. XOC (X-O-C) REPRESENTS SIGN MOUNT AS DEFINED ON SIGN SCHEDULE. THE LETTER IN PARENTHESIS REPRESENTS THE MOUNTING DETAIL. REFER TO SIGN MOUNTING SCHEDULE ON SHEET A-611. MOUNTING SIGN TO BE PLACED AS SHOWN ON PLANS.
9. ALL SIGNS LOCATED AT ENTRY/EXIT SHALL BE CENTERED IN LANES, TYPICAL.
10. + REPRESENTS A 6" O.D. STEEL BOLLARD. REFER TO DRAWING S-001 FOR ADDITIONAL INFORMATION.
11. # REPRESENTS A PRECAST BOLLARD. REFER TO DETAIL X-551 FOR ADDITIONAL INFORMATION.
12. ULTRASONIC DIRECTIONAL SENSOR OR APPROVED EQUAL. REFER TO Specs. SENSORS TO BE PLACED IN APPROXIMATE LOCATIONS, CENTERED IN DRIVE LANES AS SHOWN IN PLAN.
13. EMBED PLATE FOR ELECTRICAL CHARGING STATION. (1) PLATE & BOLTS. REFER TO DETAIL 18S-551 FOR ADDITIONAL INFORMATION.
14. UNDERSIDE OF ALL CONCRETE FLOOR SHALL RECEIVE WHITE CONCRETE STAIN. AREA TO INCLUDE ALL BEAM & GIRDERS SIDES & BOTTOM AS WELL AS COLUMN SURFACE DOWN TO THE LOWEST BEAM OR GIRDERS DEPTH. REFER TO SPEC SECTION 09 91 00 FOR ADDITIONAL INFORMATION.


**MAIN STREET
TRIANGLE
PARKING
STRUCTURE**

9650 143rd Street
 Orland Park, Illinois

**NOT FOR
CONSTRUCTION**

SPACE TABULATION				
	STANDARD	SMALL CAR ONLY	ADA	ADA VAN
LEVEL 5	125	---	---	---
LEVEL 4	129	---	3	---
LEVEL 3	127	---	4	---
LEVEL 2	79	2	2	83
LEVEL 1	76	---	---	76
TOTAL	536	9	2	547

ISSUE FOR	PROGRESS DWGS
ISSUED FOR DATE	01/22/2016
ISSUED REV. NO.	
DATE	
DESCRIPTION	
PROJECT NO.	N1-2015-196
DRAWN BY	Ray Mulvane
CHECKED BY	Russ Randall
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SHEET TITLE	LEVEL 1 PLAN - ARCHITECTURAL
	A-101

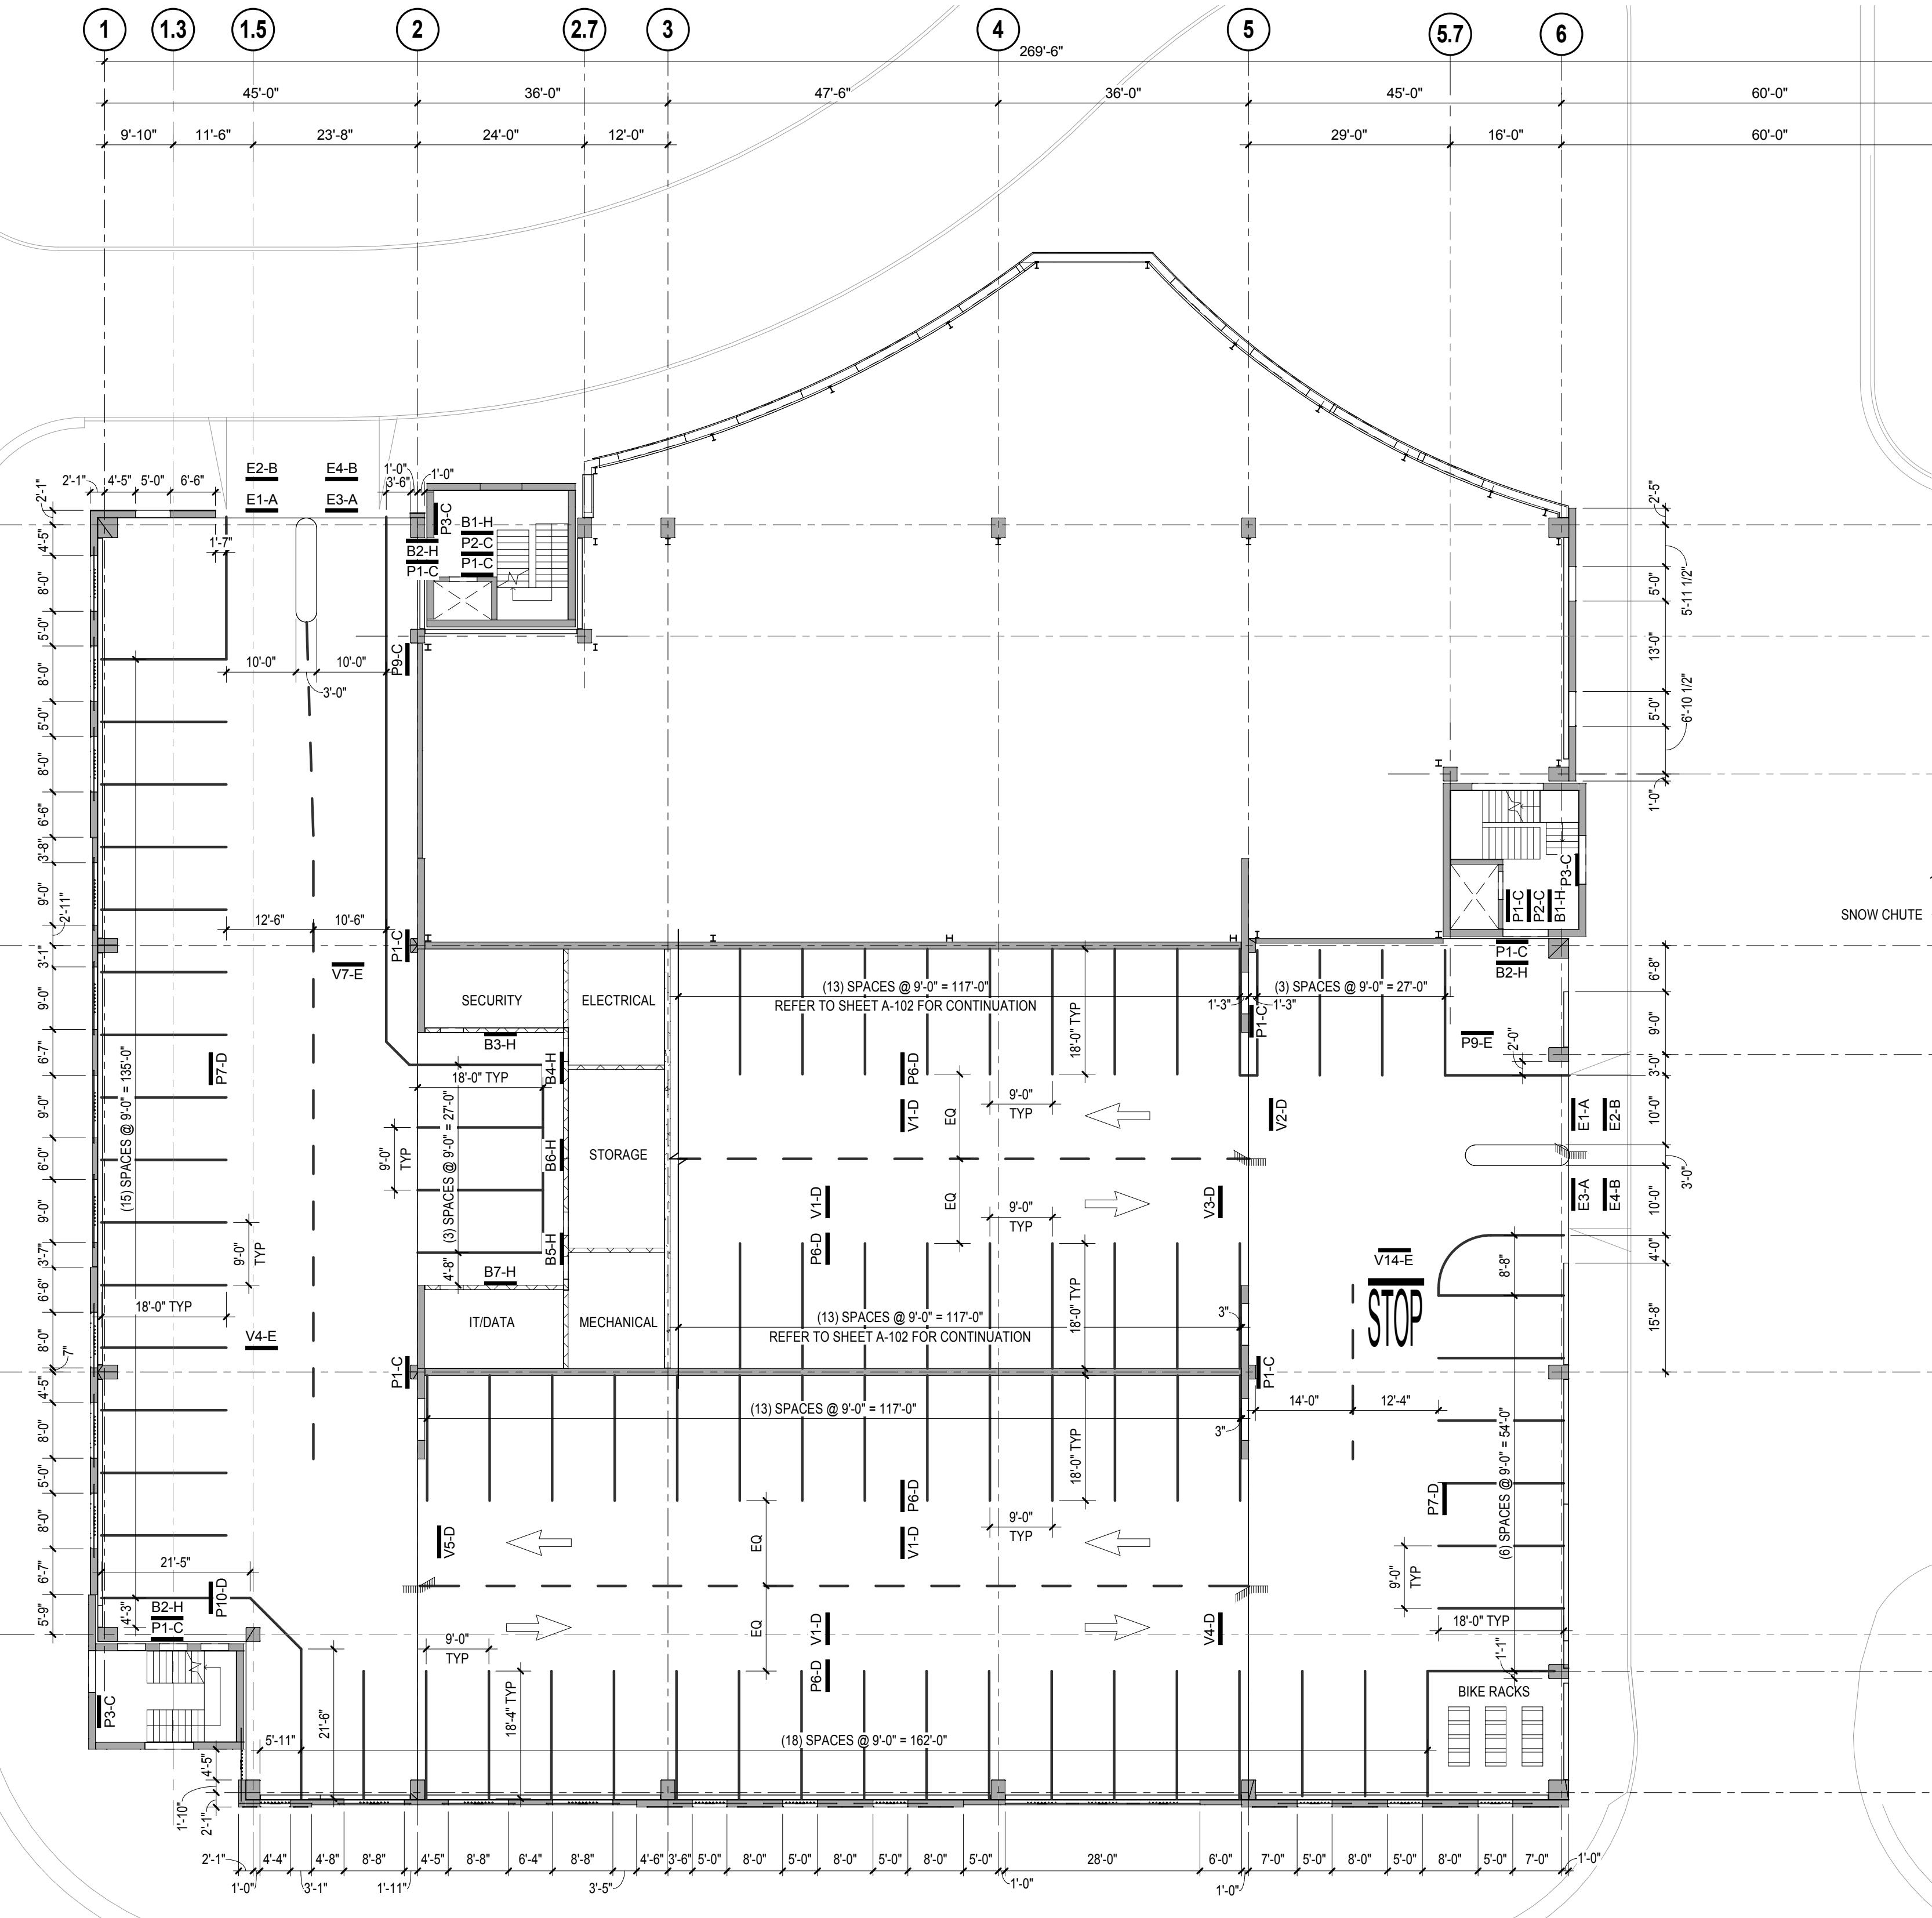

HEET NOTES:

— REPRESENTS PLAN MATCH LINE.
FOR GENERAL NOTES, REFER TO DRAWINGS S-001.
FOR EXPLANATION OF NOTATIONS AND ABBREVIATIONS, REFER TO GENERAL NOTES, DRAWINGS S-001.
PARKING SPACE STRIPING TO BE 4" WIDE TRAFFIC YELLOW STRIPING - SINGLE LINE CONFIGURATION. ALSO REFER TO SHEET A-511 FOR ADDITIONAL STRIPING INFORMATION.
CROSS HATCH STRIPING TO BE 4" WIDE TRAFFIC YELLOW STRIPING AT 24" OC AS SHOWN IN PLANS, REFER TO SHEET A-511 FOR ADDITIONAL INFORMATION.
DIRECTIONAL ARROWS TO BE PAINTED IN TRAFFIC YELLOW AS SHOWN ON PLANS, REFER TO SHEET A-511 FOR ADDITIONAL INFORMATION.
PAVEMENT GRAPHICS TO BE PAINTED IN TRAFFIC YELLOW AS SHOWN ON PLANS, REFER TO SHEET A-511 FOR ADDITIONAL INFORMATION.
XXX(X) REPRESENTS SIGN MARK AS DEFINED ON SIGN SCHEDULE ON SHEET A-611. THE LETTER IN PARENTHESIS REPRESENTS THE MOUNTING DETAIL, REFER TO SIGN MOUNTING SCHEDULE ON SHEET A-611. MOUNTING SIGN TO BE PLACED AS SHOWN ON PLANS.
ALL SIGNS LOCATED AT ENTRY/EXIT SHALL BE CENTERED IN LANES, TYPICAL.
■ REPRESENTS A 6"Ø STEEL BOLLARD, REFER TO DETAIL XXX/S-551 FOR ADDITIONAL INFORMATION.
□ REPRESENTS A PRECAST BOLLARD. REFER TO DETAIL X/S-551 FOR ADDITIONAL INFORMATION.
ULTRASONIC DIRECTIONAL SENSOR OR APPROVED EQUAL, REFER TO SPECS. SENSORS TO BE PLACED IN APPROXIMATE LOCATIONS, CENTERED IN DRIVE LANES AS SHOWN IN PLAN.
■ EMBED PLATE FOR ELECTRICAL CHARGING STATIONS W/ (1) 6"Ø STEEL BOLLARDS. REFER TO DETAIL 18/S-551 FOR ADDITIONAL INFORMATION.
UNDERSIDE OF ALL CONCRETE FLOOR SHALL RECIEVE WHITE CONCRETE STAIN. AREA TO INCLUDE ALL BEAM & GIRDER SIDES & BOTTOM AS WELL AS COLUMN SURFACE DOWN TO THE LOWEST BEAM OR GIRDER DEPTH. REFER TO SPEC SECTION 09 91 00 FOR ADDITIONAL INFORMATION.


MAIN STREET TRIANGLE PARKING STRUCTURE

9650 143rd Street
Orland Park, Illinois

NOT FOR CONSTRUCTION

PROJECT NO. _____ N1-2015-196
DRAWN BY _____ Ray Mulvaney
CHECKED BY _____ Russ Randall

SHEET TITLE
LEVEL 2 PLAN -
ARCHITECTURAL

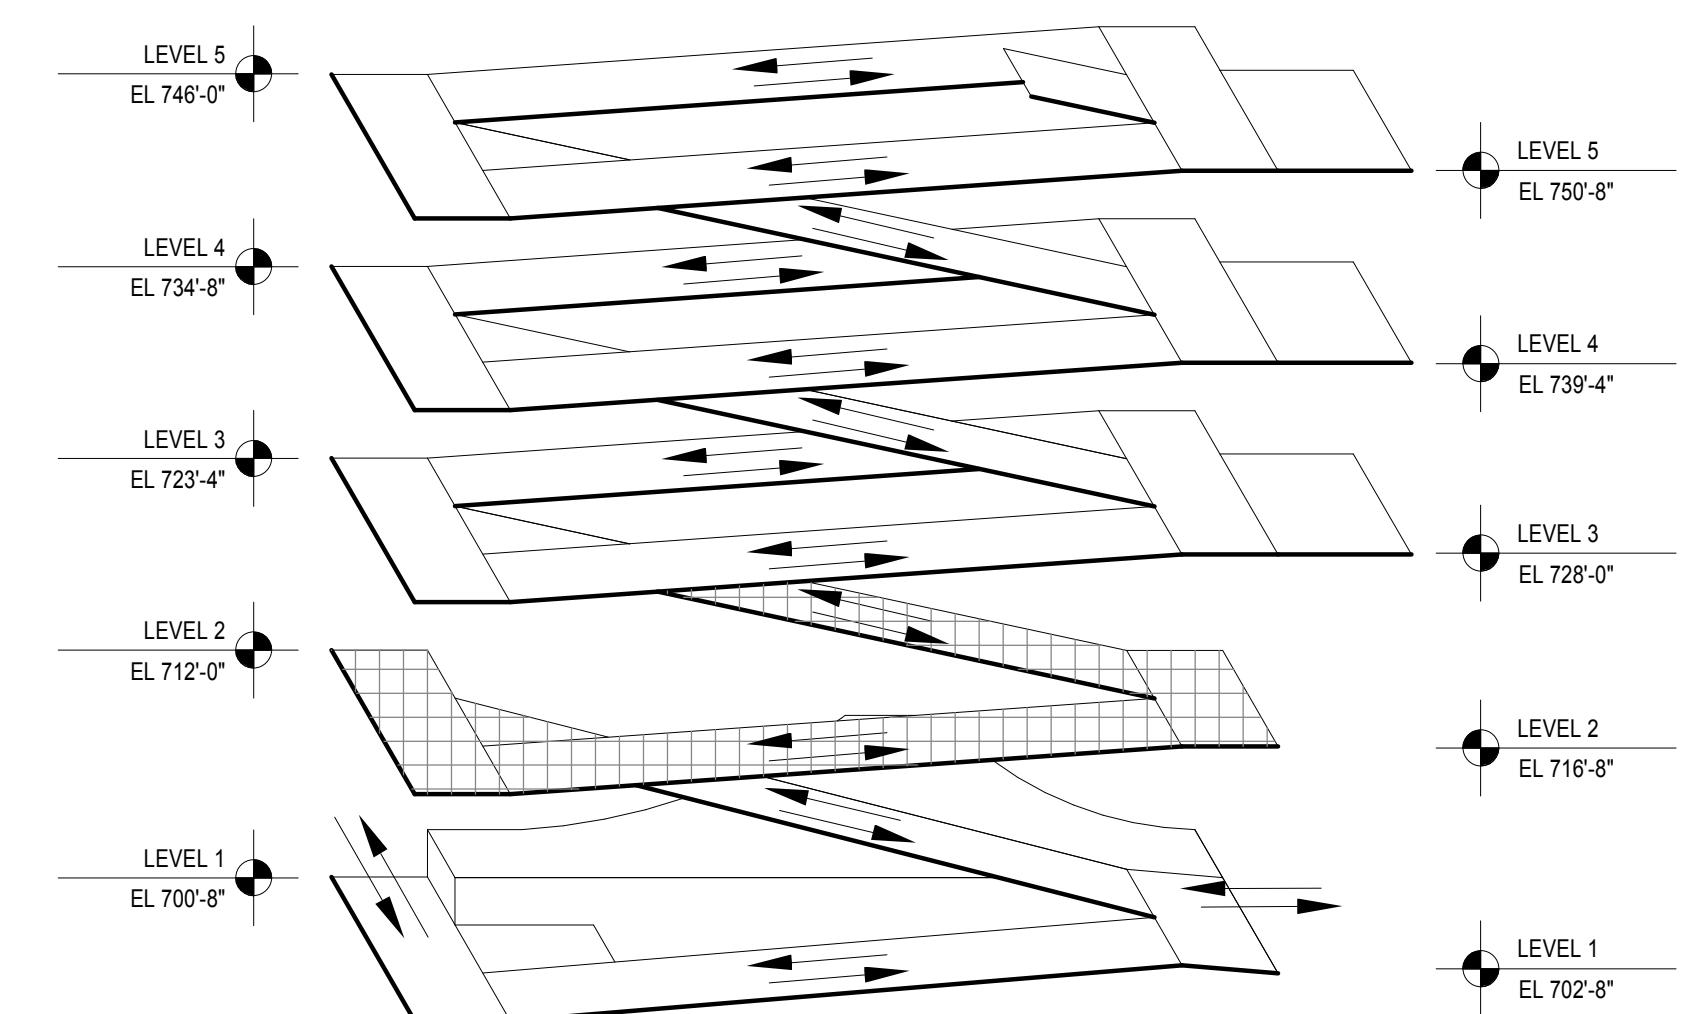

STEREOGRAPHIC VIEW

1 LEVEL 2 PLAN - ARCHITECTURAL

A compass rose icon with the word "NORTH" below it.



Walsh
 Construction Company
 929 West Adams
 Chicago, Illinois 60607
 Phone: (312) 563-5400

SHEET NOTES:



1. REPRESENTS PLAN MATCH LINE
2. FOR GENERAL NOTES, REFER TO DRAWINGS S-001.
3. FOR EXPLANATION OF NOTATIONS AND ABBREVIATIONS, REFER TO GENERAL NOTES, DRAWINGS S-001.
4. PARKING SPACE STRIPING TO BE 4" WIDE TRAFFIC YELLOW STRIPING AT 24 OC AS SHOWN IN PLANS. REFER TO SHEET A-511 FOR ADDITIONAL STRIPING INFORMATION.
5. CROSS HATCH STRIPING TO BE 4" WIDE TRAFFIC YELLOW STRIPING AT 24 OC AS SHOWN IN PLANS. REFER TO SHEET A-511 FOR ADDITIONAL INFORMATION.
6. DIRECTIONAL ARROWS TO BE PAINTED IN TRAFFIC YELLOW AS SHOWN ON PLANS. REFER TO SHEET A-511 FOR ADDITIONAL INFORMATION.
7. PAVEMENT GRAPHICS TO BE PAINTED IN TRAFFIC YELLOW AS SHOWN ON PLANS. REFER TO SHEET A-511 FOR ADDITIONAL INFORMATION.
8. REPRESENTS SIGN MARK AS DEFINED ON SIGN SCHEDULE ON SHEET A-611. THE LETTER IN PARENTHESIS REPRESENTS THE MOUNTING DETAIL. REFER TO SIGN MOUNTING SCHEDULE ON SHEET A-611. MOUNTING SIGN TO BE PLACED AS SHOWN ON PLANS.
9. ALL SIGNS LOCATED AT ENTRY/EXIT SHALL BE CENTERED IN LANES, TYPICAL.
10. REPRESENTS A 6" Ø STEEL BOLLARD. REFER TO DETAIL 18S-551 FOR ADDITIONAL INFORMATION.
11. REPRESENTS A PRECAST BOLLARD. REFER TO DETAIL 18S-551 FOR ADDITIONAL INFORMATION.
12. ULTRASONIC SECTIONAL SENSOR OR REMOVED EQUAL. REFER TO SPECS. SENSORS TO BE PLACED IN APPROXIMATE LOCATIONS, CENTERED IN DRIVE LANES AS SHOWN IN PLAN.
13. EMBED PLATE FOR ELECTRICAL CHARGING STATIONS W/ (1) 6" Ø STEEL BOLLARD. REFER TO DETAIL 18S-551 FOR ADDITIONAL INFORMATION.
14. UNLESS OTHERWISE SPECIFIED, ALL CONCRETE STAIN AREA TO INCLUDE ALL BEAM & GIRDERS SIDES & BOTTOM AS WELL AS COLUMN SURFACE DOWN TO THE LOWEST BEAM OR GIRDERS DEPTH. REFER TO SPEC SECTION 09.91.00 FOR ADDITIONAL INFORMATION.

**MAIN STREET
TRIANGLE
PARKING
STRUCTURE**

9650 143rd Street
 Orland Park, Illinois

**NOT FOR
CONSTRUCTION**

ISSUE FOR	PROGRESS DWGS
ISSUED FOR DATE	01/22/2016
ISSUED REV. NO.	
DATE	
DESCRIPTION	
PROJECT NO.	N1-2015-196
DRAWN BY	Ray Mulvane
CHECKED BY	Russ Randall
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SHEET TITLE	LEVEL 3 PLAN - ARCHITECTURAL
	A-103

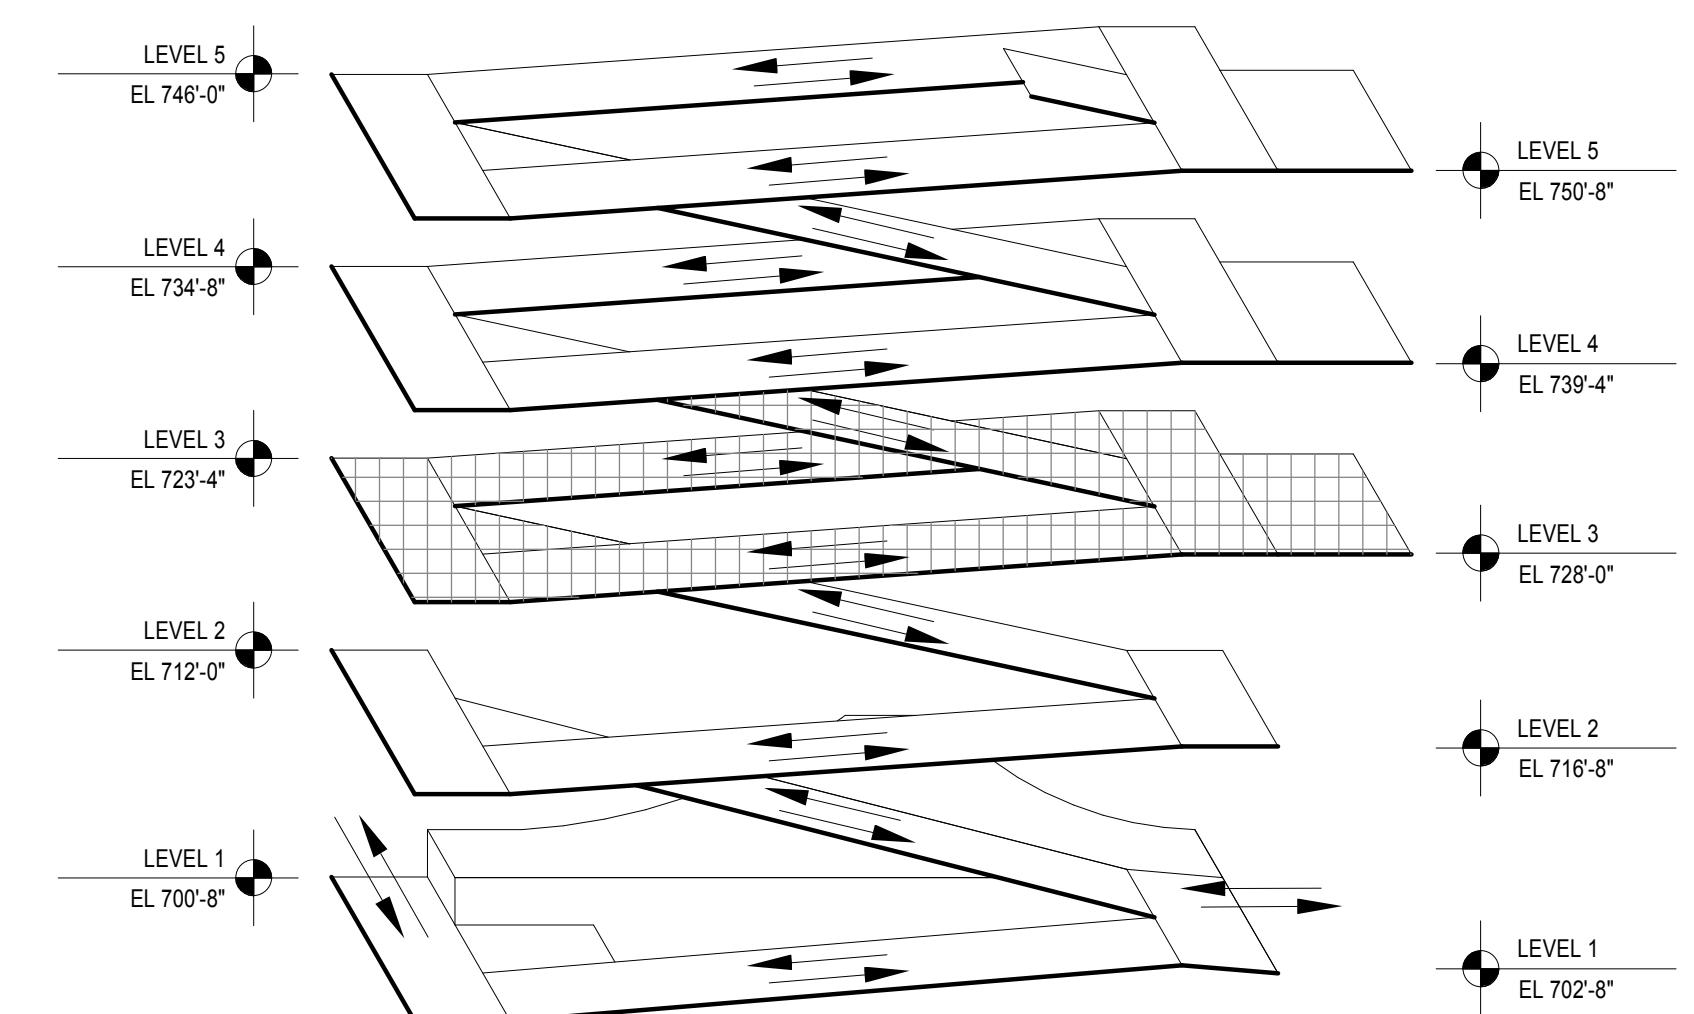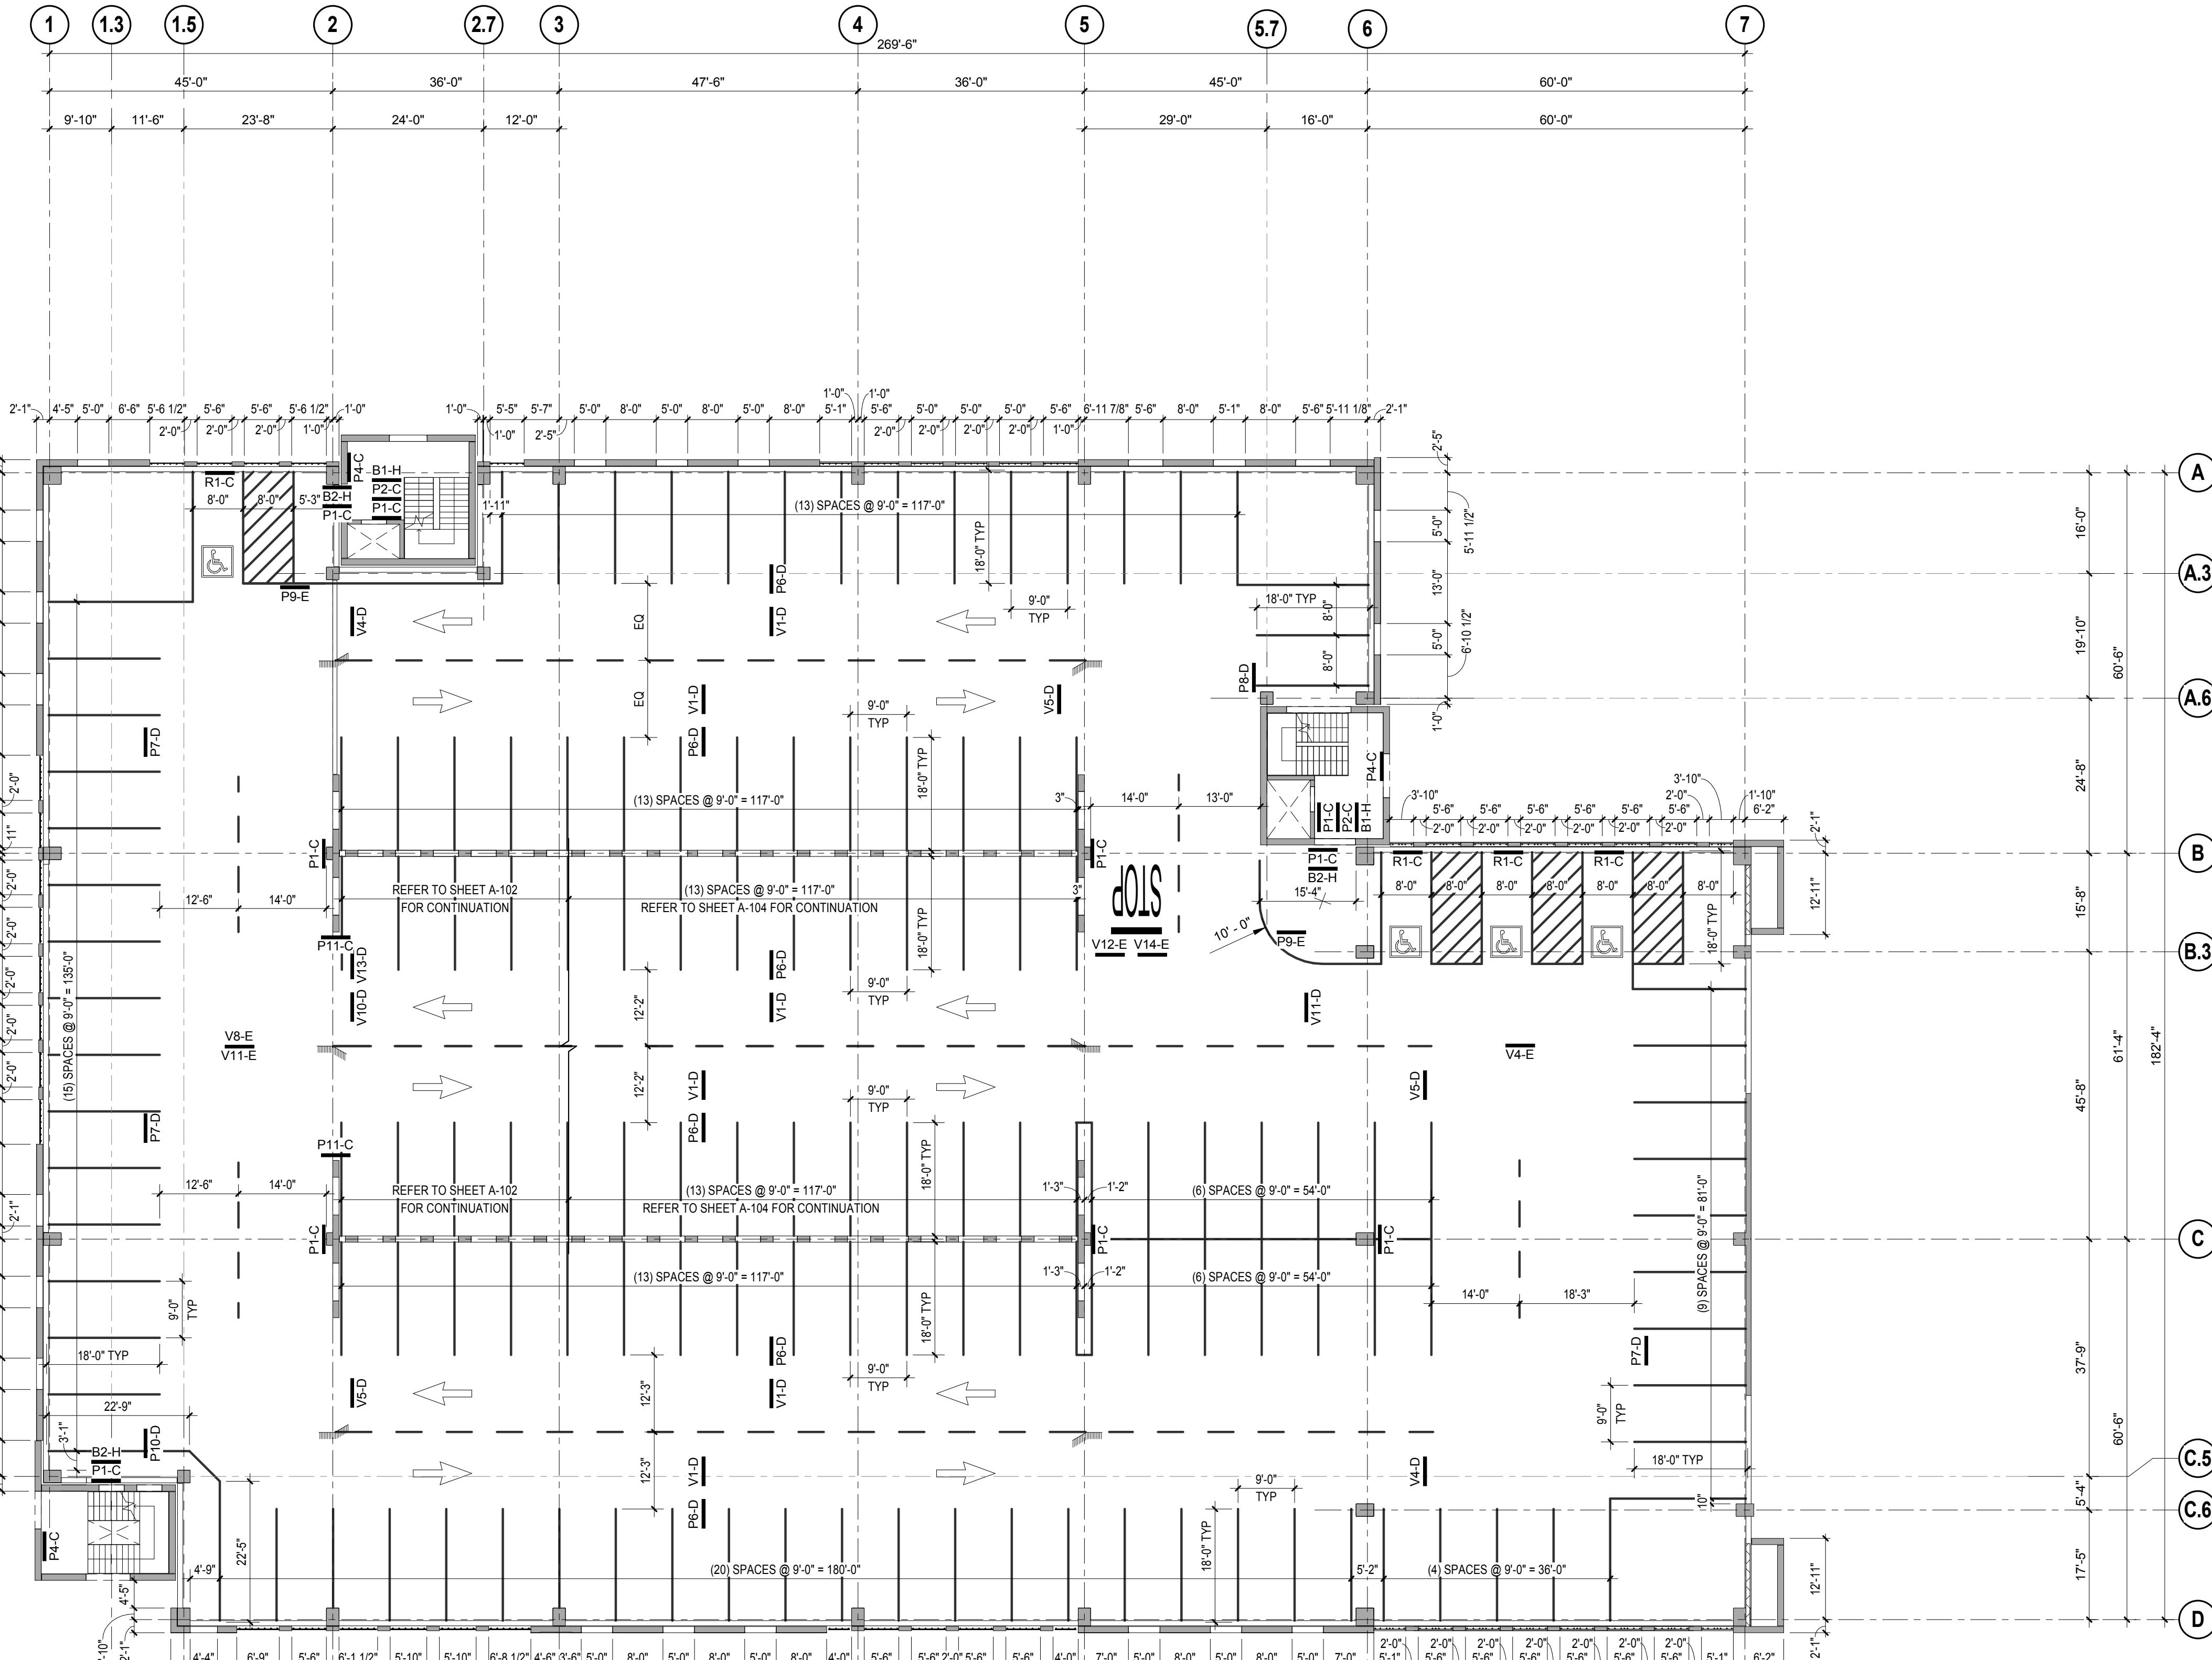

ISOMETRIC VIEW



MAIN STREET TRIANGLE PARKING STRUCTURE

9650 143rd Street
Orland Park, Illinois

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CONSTRUCTION**

ISSUE FOR	PROGRESS DWGS
ISSUED FOR DATE	01/22/2016

ISSUED REV. NO.	DATE	DESCRIPTION

PROJECT NO. N1-2015-196
DRAWN BY Ray Mulvane
CHECKED BY Russ Randall


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SHEET TITLE
**LEVEL 4 PLAN -
ARCHITECTURAL**

A-104

SHEET NOTES:

1. LINE REPRESENTS PLAN MATCH
2. FOR GENERAL NOTES, REFER TO DRAWINGS S-001.
3. FOR EXPLANATION OF NOTATIONS AND ABBREVIATIONS, REFER TO GENERAL NOTES DRAWINGS S-001.
4. PARKING SPACE STRIPING TO BE 4" WIDE TRAFFIC YELLOW STRIPING - SINGLE LINE CONFIGURATION. ALSO REFER TO SHEET A-511 FOR ADDITIONAL STRIPING INFORMATION.
5. CROSS-HATCH STRIPING TO BE 4" WIDE TRAFFIC YELLOW STRIPING AT 24° OC AS SHOWN IN PLANS. REFER TO SHEET A-511 FOR ADDITIONAL INFORMATION.
6. DIRECTIONAL ARROWS TO BE PAINTED IN TRAFFIC YELLOW AS SHOWN ON PLANS. REFER TO SHEET A-511 FOR ADDITIONAL INFORMATION.
7. PAVEMENT GRAPHICS TO BE PAINTED IN TRAFFIC YELLOW AS SHOWN ON PLANS. REFER TO SHEET A-511 FOR ADDITIONAL INFORMATION.
8. XXXXL REPRESENTS SIGN MARK AS DEFINED ON SIGN SCHEDULE ON SHEET A-611. THE LETTER IN PARENTHESIS REPRESENTS THE MOUNTING DETAIL. REFER TO SIGN MOUNTING SCHEDULE ON SHEET A-611. MOUNTING SIGN TO BE PLACED AS SHOWN ON PLANS.
9. ALL SIGNS LOCATED AT ENTR/EXIT SHALL BE CENTERED ON THE DRIVE LANE.
10. + REPRESENTS A 6" STEEL BOLLARD. REFER TO DETAIL XXXS-551 FOR ADDITIONAL INFORMATION.
11. □ REPRESENTS A PRECAST BOLLARD. REFER TO DETAIL XIS-551 FOR ADDITIONAL INFORMATION.
12. ULTRASONIC DIRECTIONAL SENSOR OR APPROVED EQUAL. REFER TO SPECS. SENSORS TO BE PLACED IN APPROXIMATE LOCATIONS, CENTERED IN DRIVE LANE AS SHOWN ON PLANS.
13. EMBED PLATE FOR ELECTRICAL CHARGING STATIONS W/ (1) 6" STEEL BOLLARD. REFER TO DETAIL 18S-551 FOR ADDITIONAL INFORMATION.
14. UNDERSIDE OF ALL CONCRETE FLOOR SHALL RECEIVE WHITE CONCRETE STAIN. AREA TO INCLUDE ALL BEAM & GIRDERS SIDES & BOTTOM AS WELL AS COLUMN SURFACE DOWN TO THE LOWEST BEAM OR GIRDERS DEPTH. REFER TO SPEC SECTION 09 91 00 FOR ADDITIONAL INFORMATION.



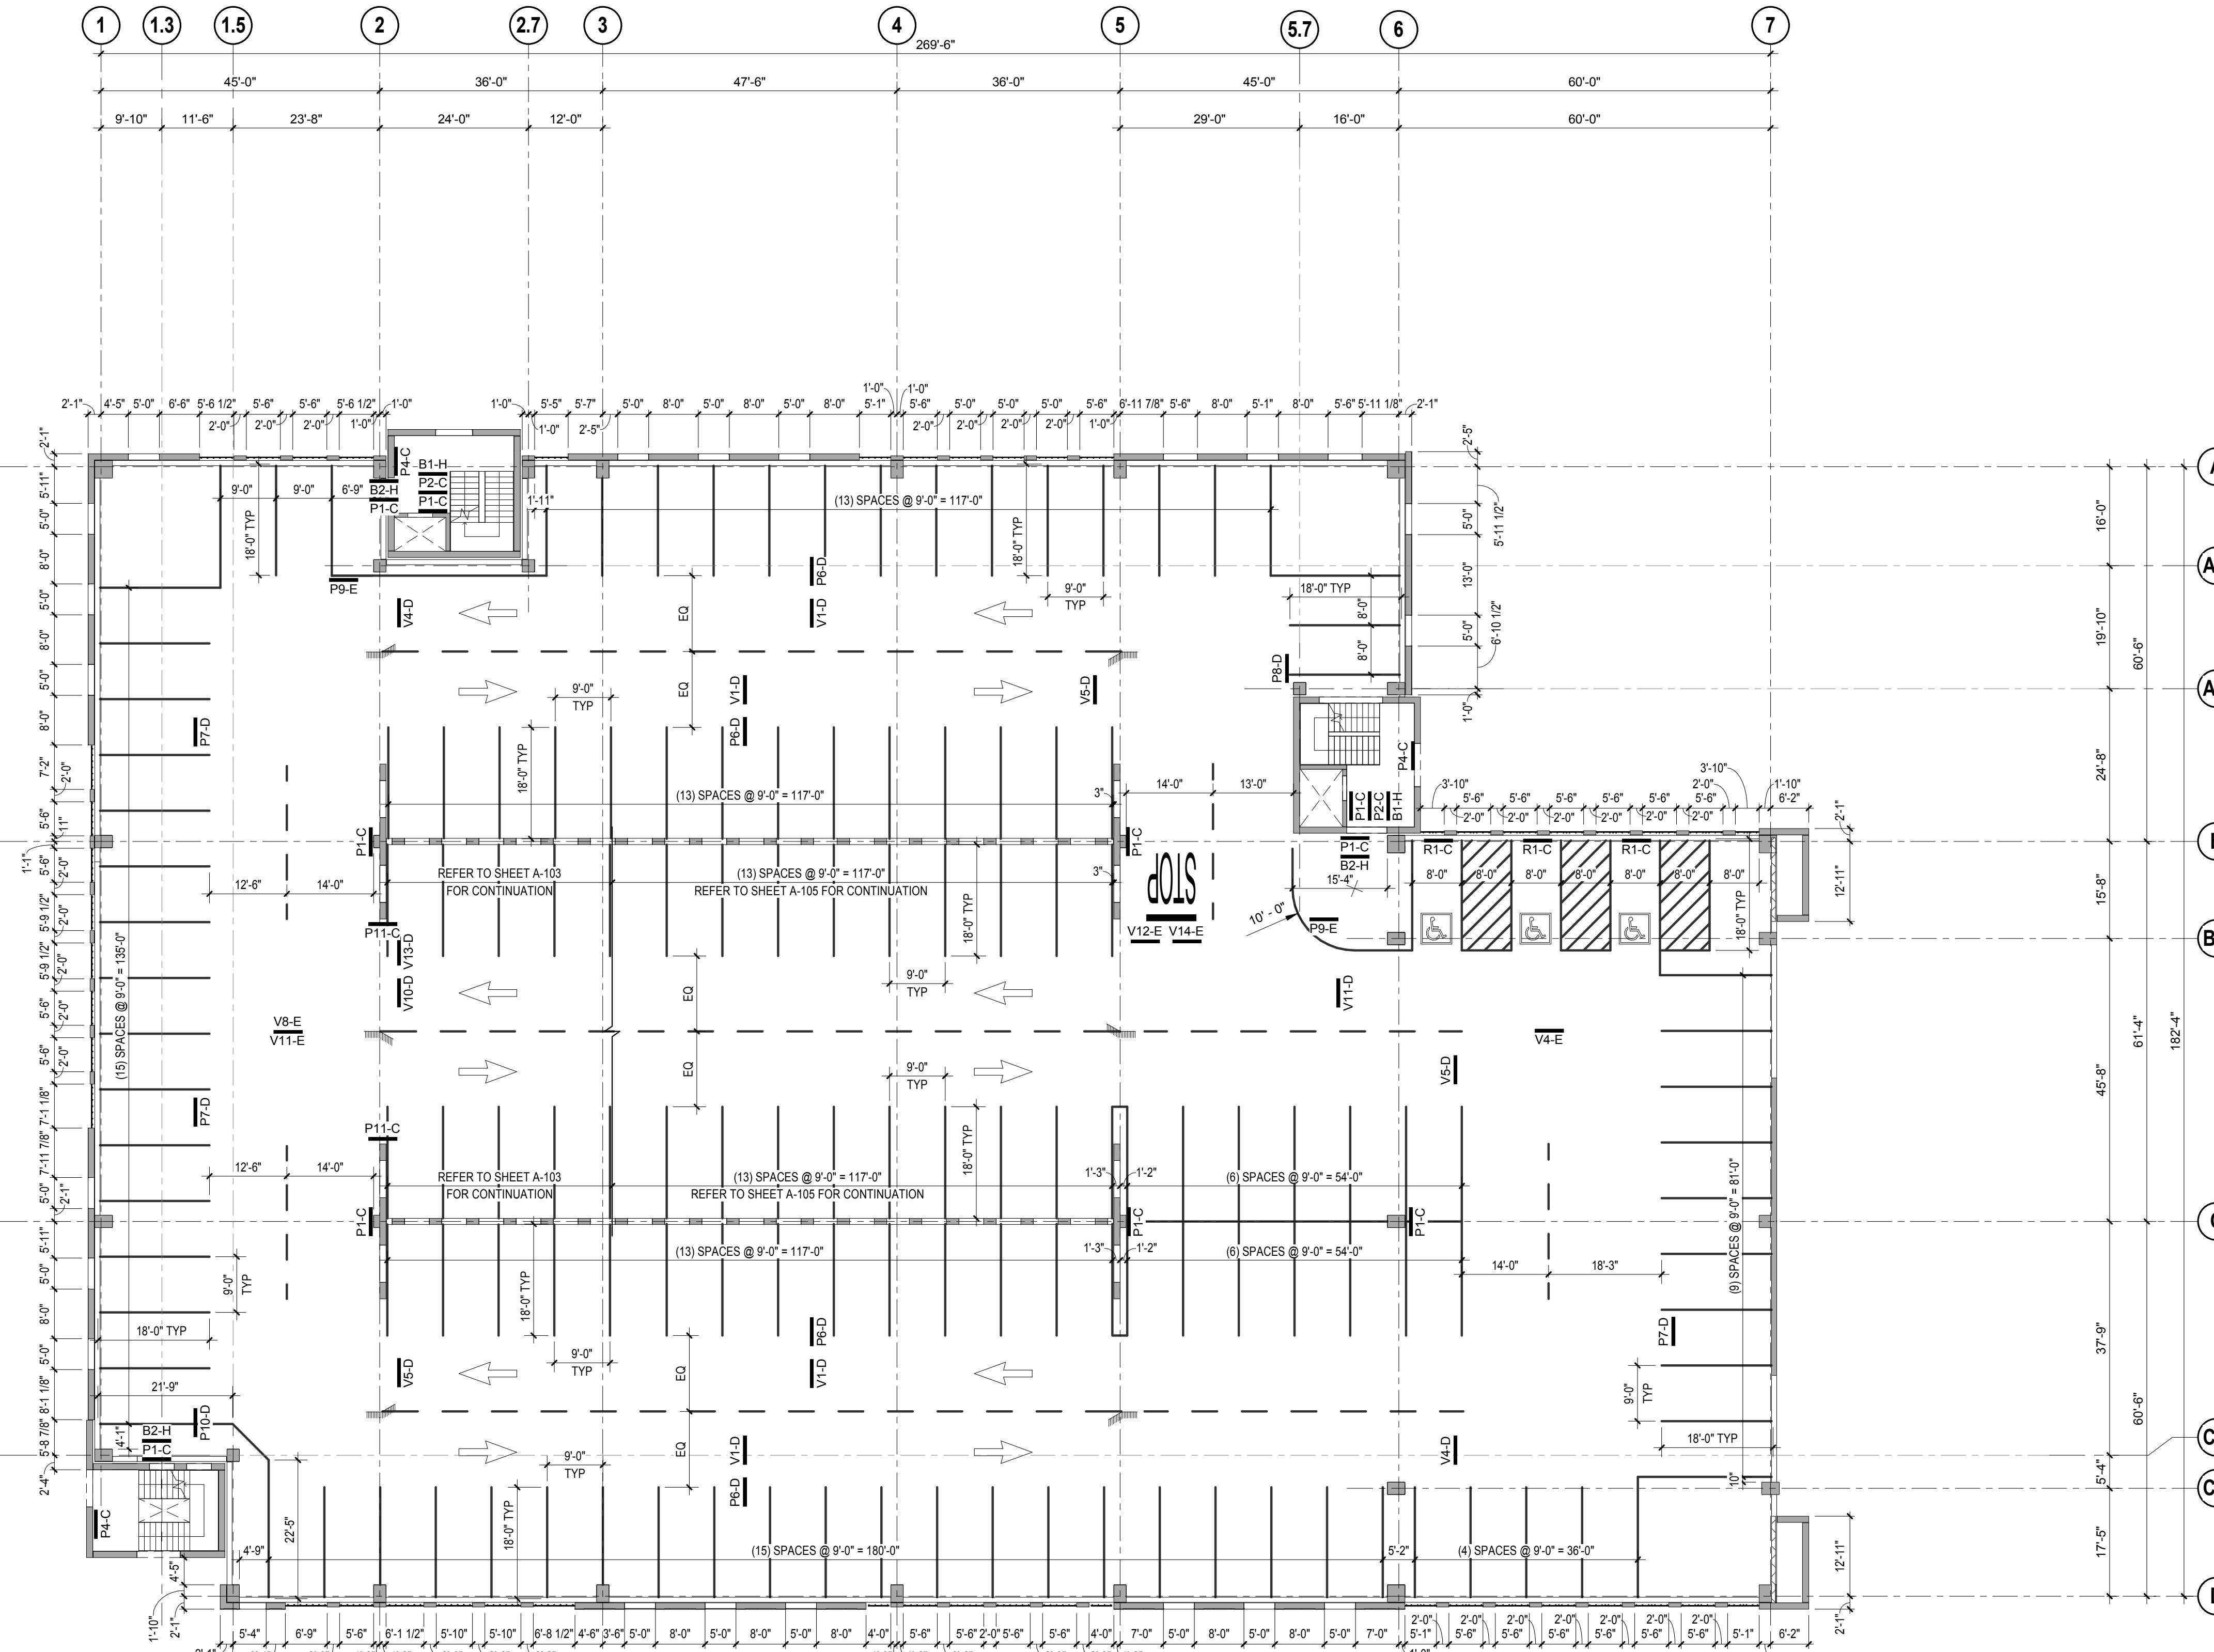


Walsh Construction Company
929 West Adams
Chicago, Illinois 60607
Phone: (312) 563-5400

MAIN STREET TRIANGLE PARKING STRUCTURE

9650 143rd Street
Orland Park, Illinois

**NOT FOR
CONSTRUCTION**


ISSUE FOR	PROGRESS DWGS
ISSUED FOR DATE	01/22/2016
ISSUED REV. NO.	
DATE	
DESCRIPTION	
PROJECT NO.	N1-2015-196
DRAWN BY	Ray Mulvane
CHECKED BY	Russ Randall
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SHEET TITLE	LEVEL 5 PLAN - ARCHITECTURAL
	A-105

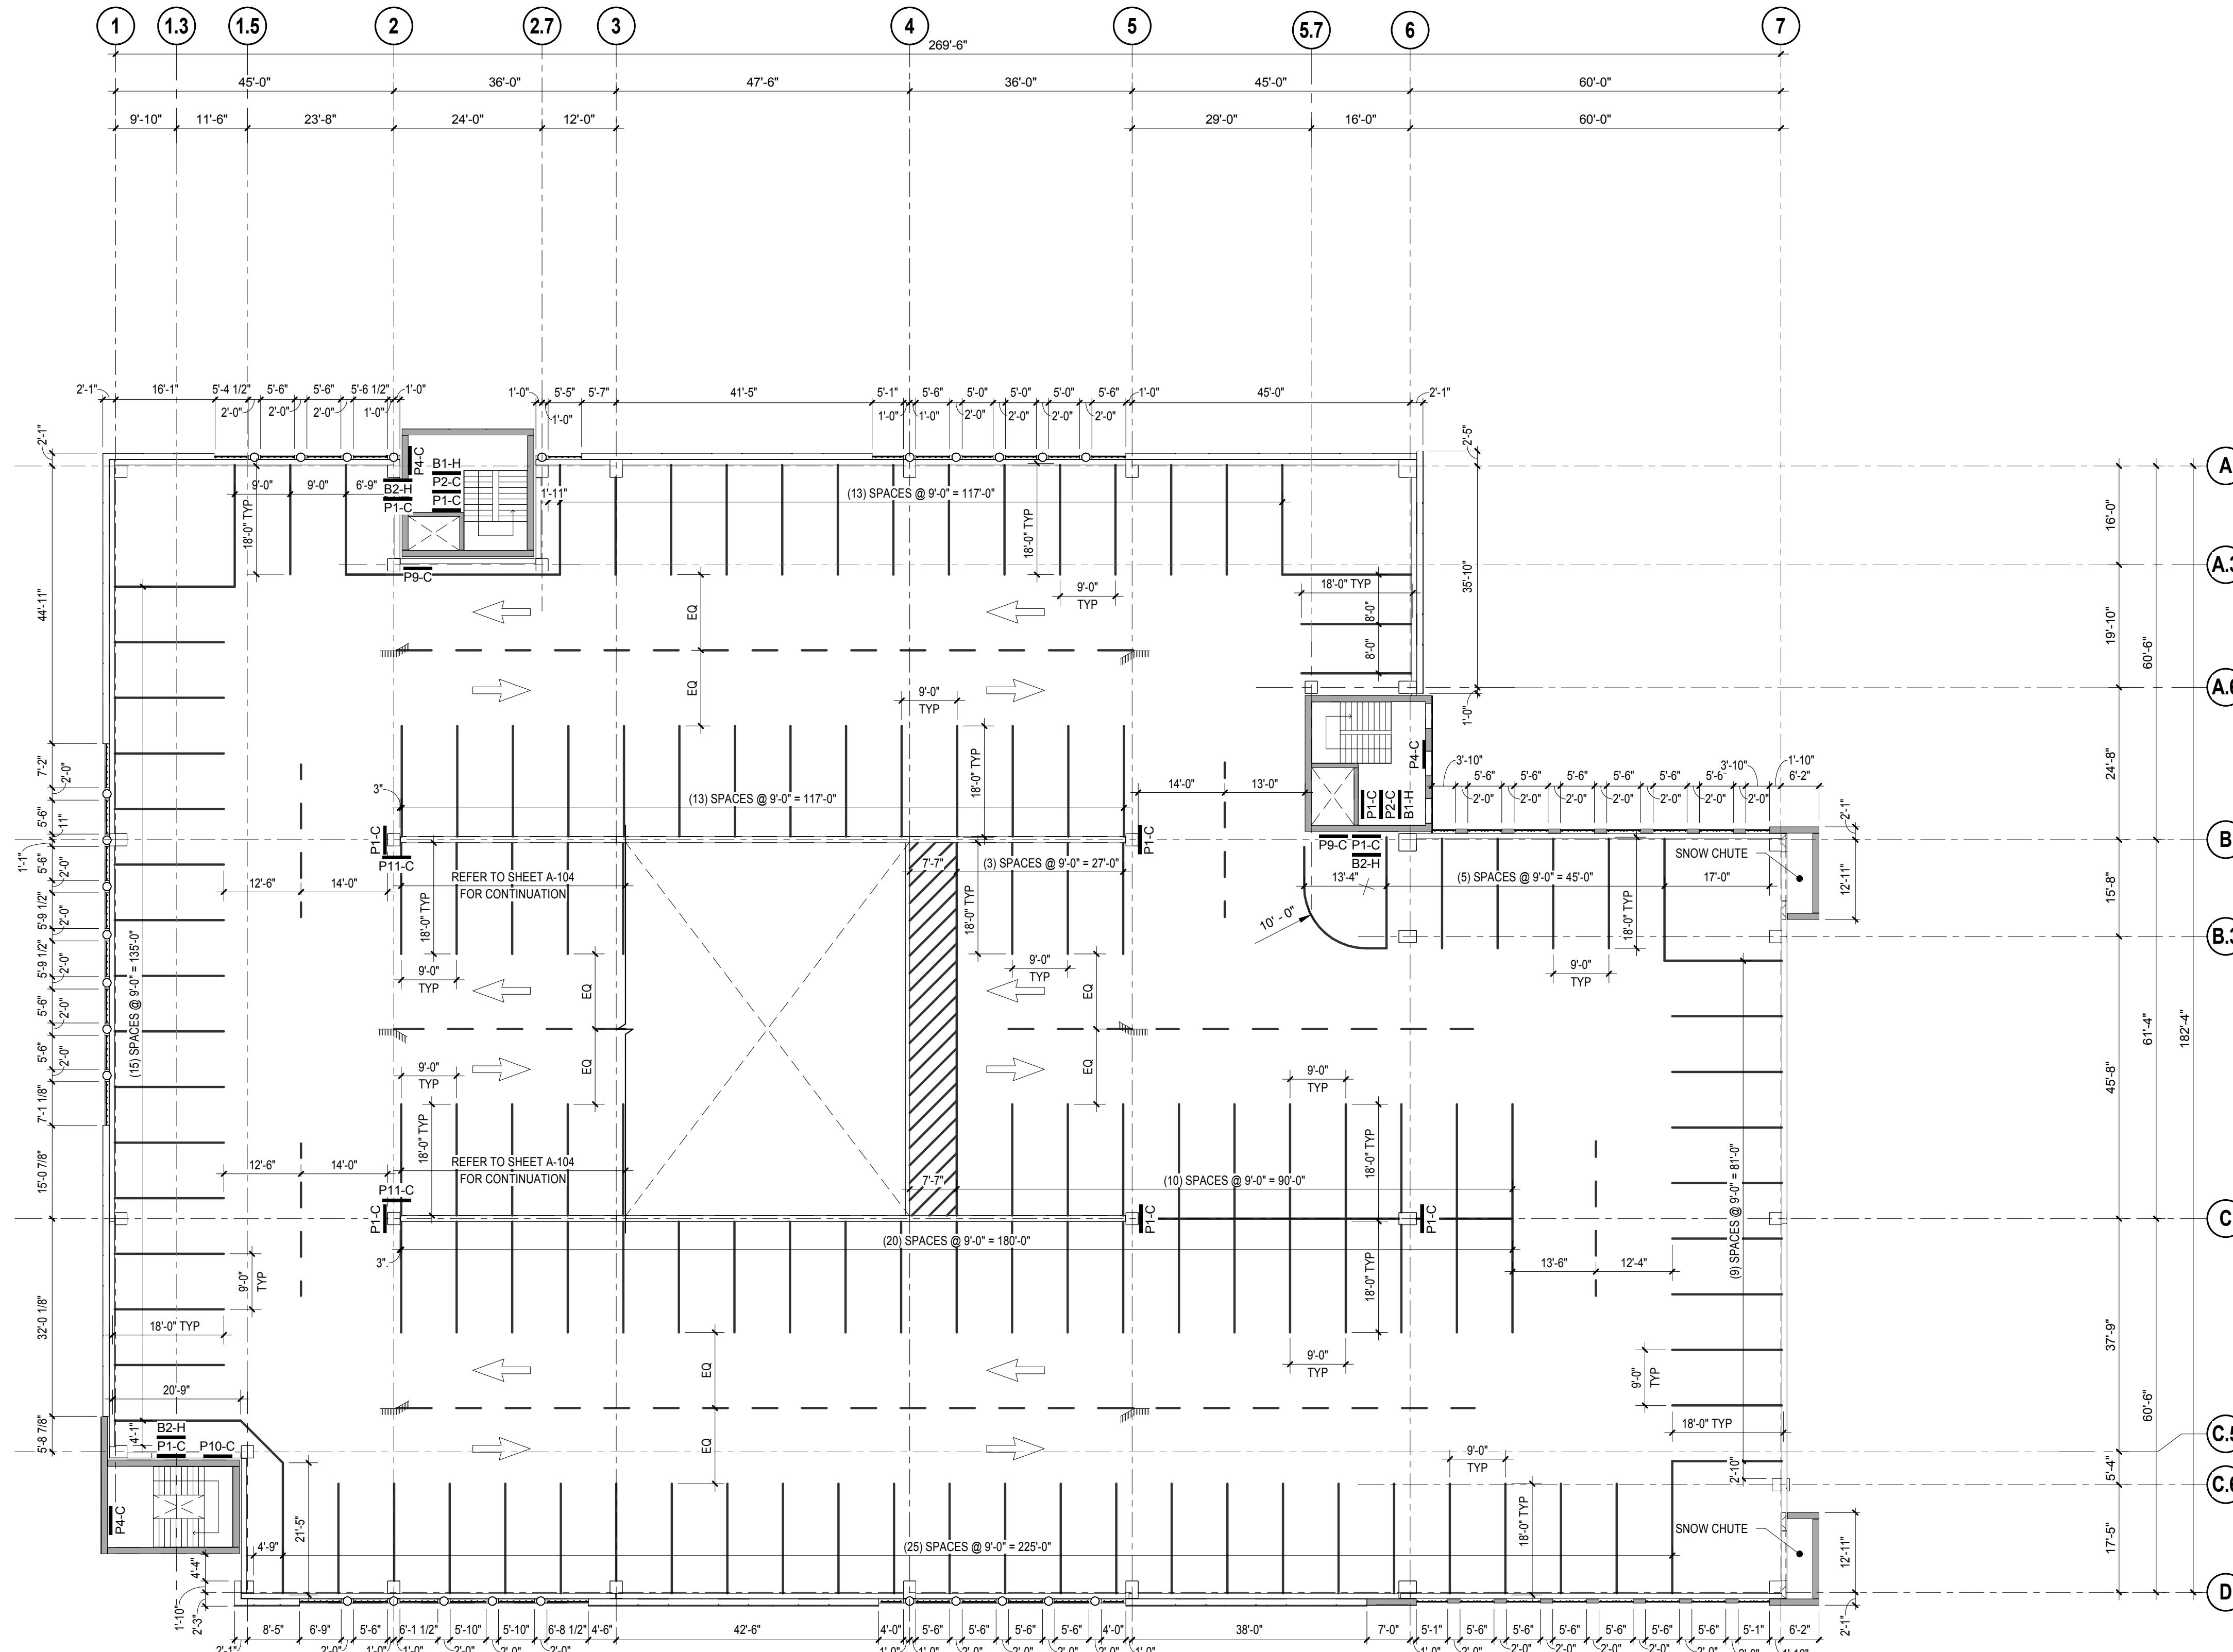

1 LEVEL 5 PLAN - ARCHITECTURAL

1/16" = 1'-0"


NORTH

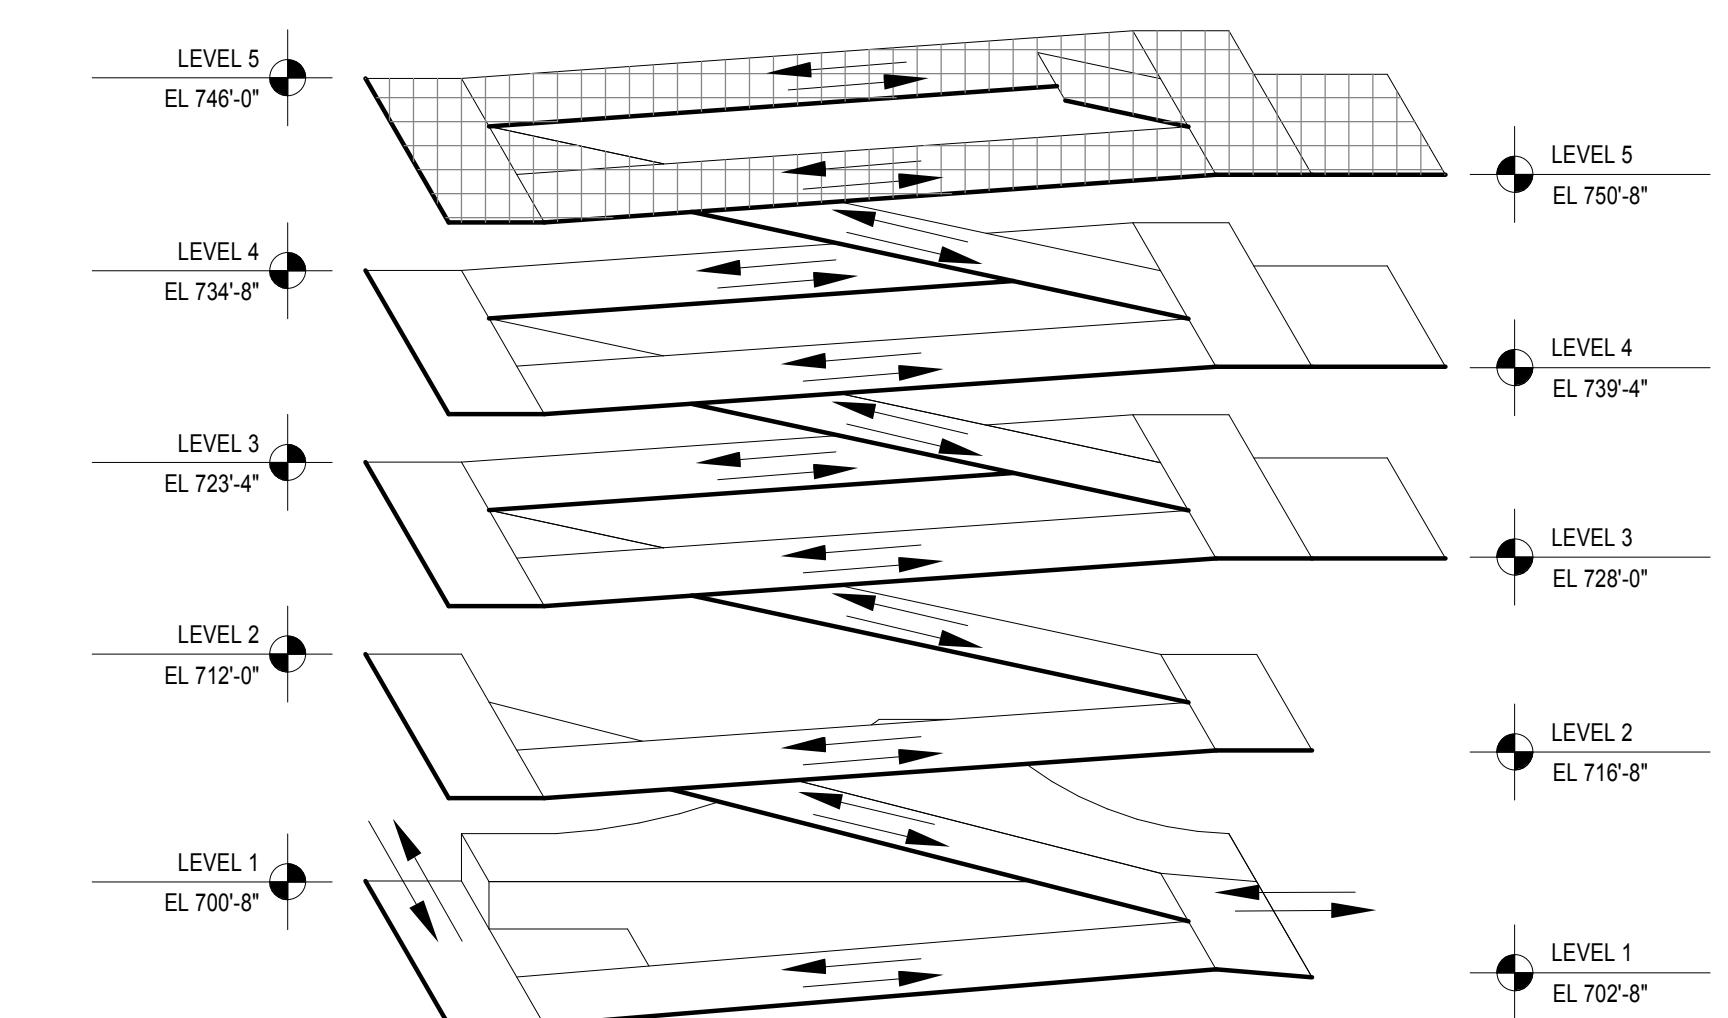

ISOMETRIC VIEW


SHEET NOTES:

1. LINE — REPRESENTS PLAN MATCH
2. FOR GENERAL NOTES, REFER TO DRAWINGS S-001.
3. FOR EXPLANATION OF NOTATIONS AND ABBREVIATIONS, REFER TO GENERAL NOTES, DRAWINGS S-001.
4. PARKING SPACE STRIPING TO BE 4" WIDE TRAFFIC YELLOW STRIPING - SINGLE LINE CONFIGURATION. ALSO REFER TO SHEET A-511 FOR ADDITIONAL STRIPING INFORMATION.
5. CROSSWALK STRIPING TO BE 4" WIDE TRAFFIC YELLOW STRIPING AT 24' OC AS SHOWN IN PLANS. REFER TO SHEET A-511 FOR ADDITIONAL INFORMATION.
6. DIRECTIONAL ARROWS TO BE PAINTED IN TRAFFIC YELLOW AS SHOWN ON PLANS. REFER TO SHEET A-511 FOR ADDITIONAL INFORMATION.
7. PAVEMENT GRAPHICS TO BE PAINTED IN TRAFFIC YELLOW AS SHOWN ON PLANS. REFER TO SHEET A-511 FOR ADDITIONAL INFORMATION.
8. XXX () REPRESENTS SIGN MARK AS DEFINED ON SIGN SCHEDULE ON SHEET A-611. THE LETTER IN PARENTHESIS REPRESENTS THE MOUNTING DETAIL. REFER TO SIGN MOUNTING SCHEDULE ON SHEET A-611. MOUNTING SIGN TO BE PLACED AS SHOWN ON PLANS.
9. ALL SIGNS LOCATED IN ENTRY/EXIT SHALL BE CENTERED AND LAND TOWARD THE CENTER.
10. + REPRESENTS A 6" STEEL BOLLARD. REFER TO DETAIL XXXS-551 FOR ADDITIONAL INFORMATION.
11. □ REPRESENTS A PRECAST BOLLARD. REFER TO DETAIL XS-551 FOR ADDITIONAL INFORMATION.
12. ULTRASONIC DIRECTIONAL SENSOR OR APPROVED EQUAL. REFER TO SPECS. SENSORS TO BE PLACED IN APPROXIMATE LOCATIONS, CENTERED IN DRIVE LANE.
13. □ EMBED PLATE FOR ELECTRICAL CHARGING STATIONS (W/I) 6" STEEL BOLLARDS. REFER TO DETAIL 18S-551 FOR ADDITIONAL INFORMATION.
14. UNDERSIDE OF ALL CONCRETE FLOOR SHALL RECEIVE WHITE CONCRETE STAIN AREA TO INCLUDE ALL BEAM/GIRDER SIDES & BOTTOM AS WELL AS COLUMN SURFACE DOWN TO THE LOWEST BEAM OR GIRDERS. REFER TO SPEC SECTION 09 91 00 FOR ADDITIONAL INFORMATION.

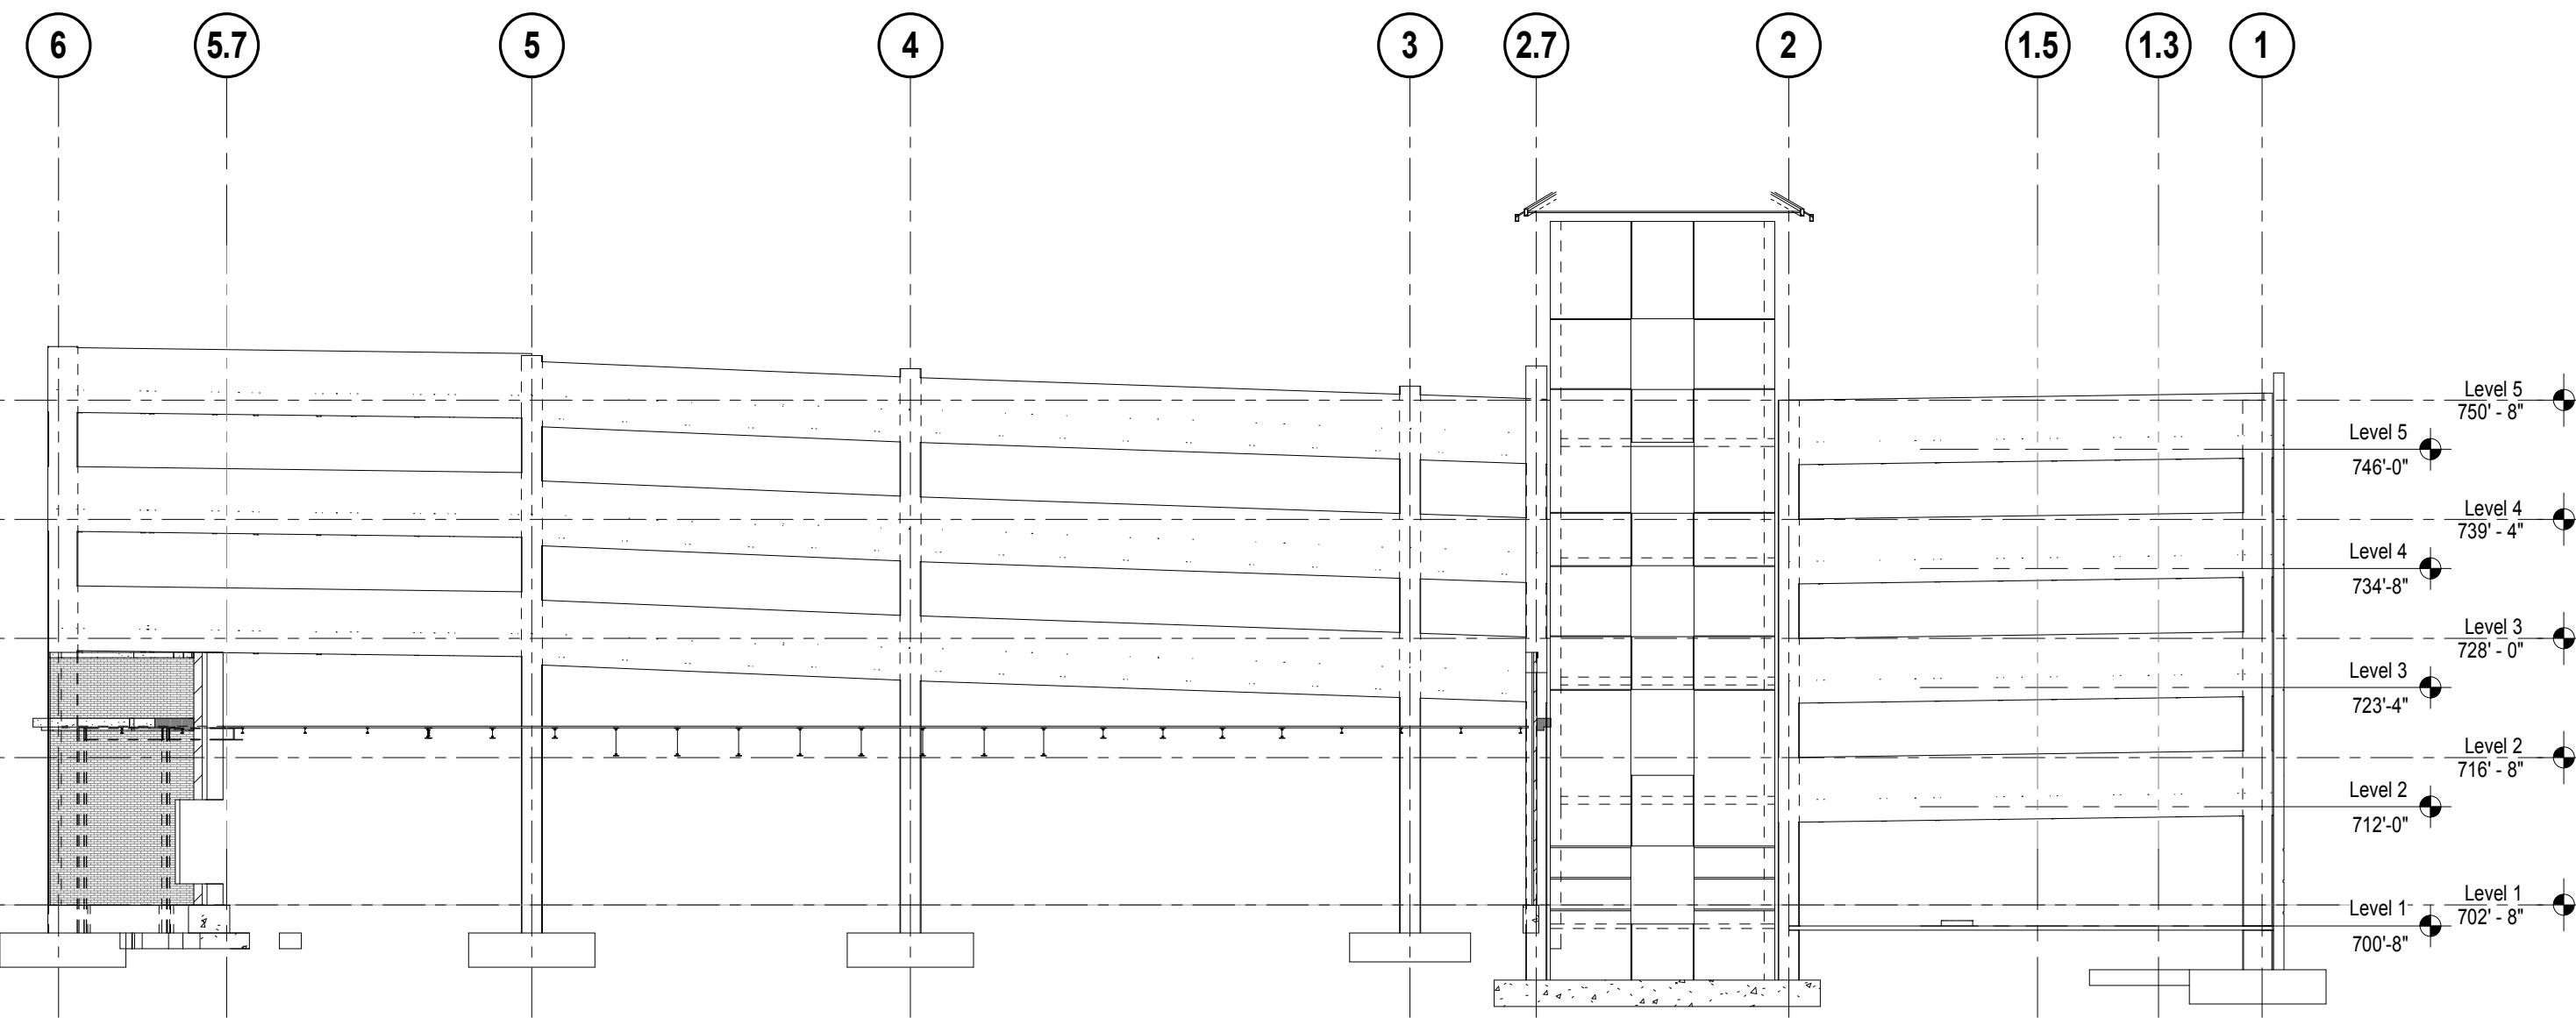

1 BUILDING ELEVATION - GRID LINE A - STRUCTURAL
1/16" = 1'-0"

1/16" = 1'-0"

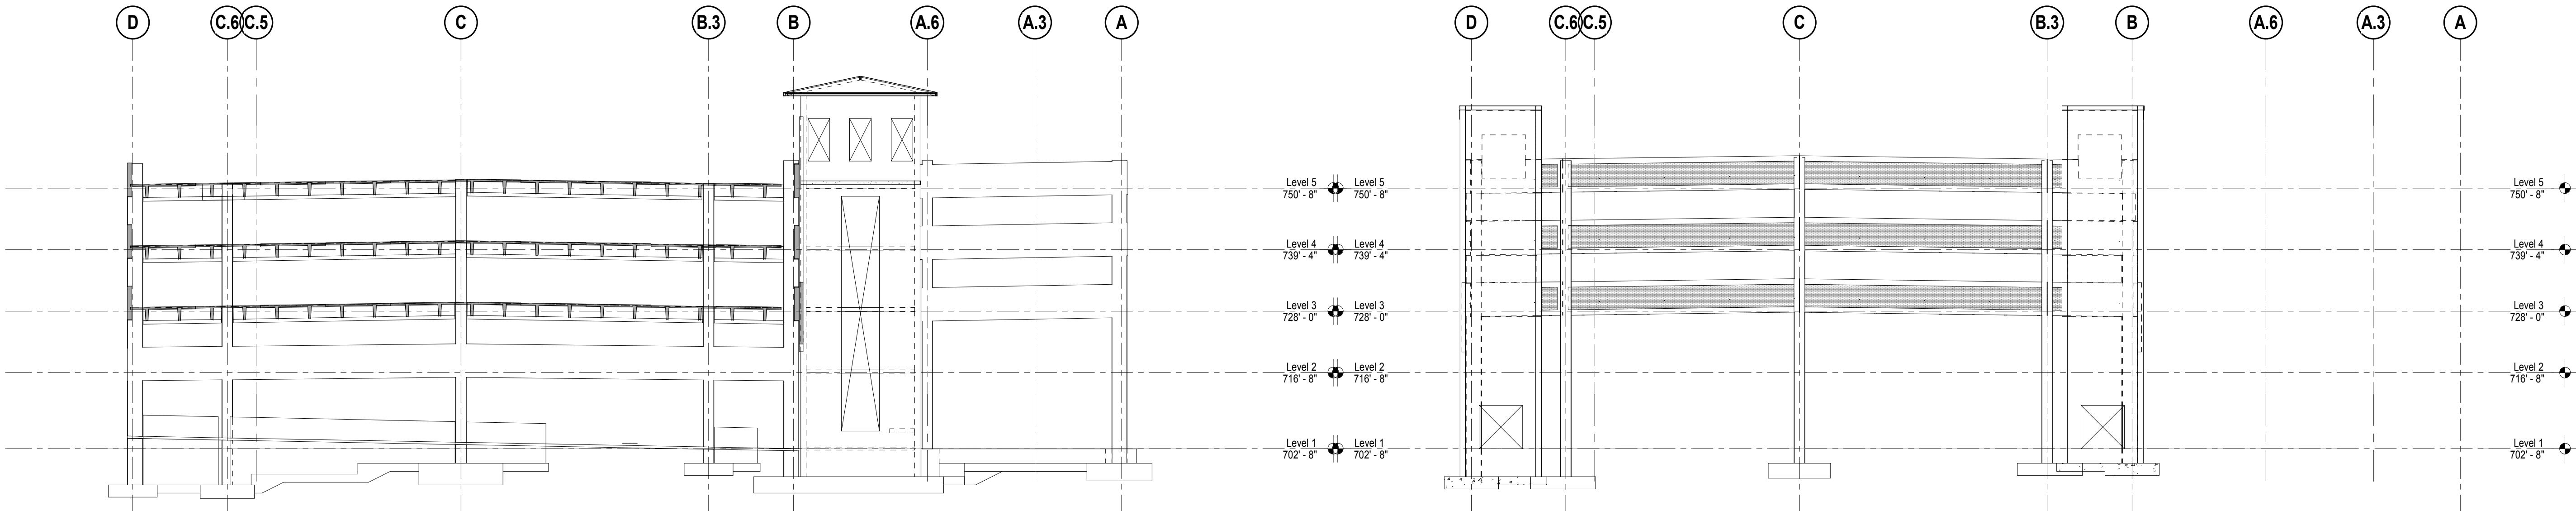

2 BUILDING ELEVATION - GRID LINE 5 - STRUCTURAL

2 BUILDING ELEVATION - GRID LINE 5 - STRUCTURAL
1/16" = 1'-0"

3 BUILDING ELEVATION - GRID LINE 7 - STRUCTURAL


3) BUILDING ELEVATION
1/16" = 1'-0"

MAIN STREET TRIANGLE PARKING STRUCTURE

9650 143rd Street
Orland Park, Illinois


SHEETS INCLUDED FOR REFERENCE ONLY

NOT FOR CONSTRUCTION

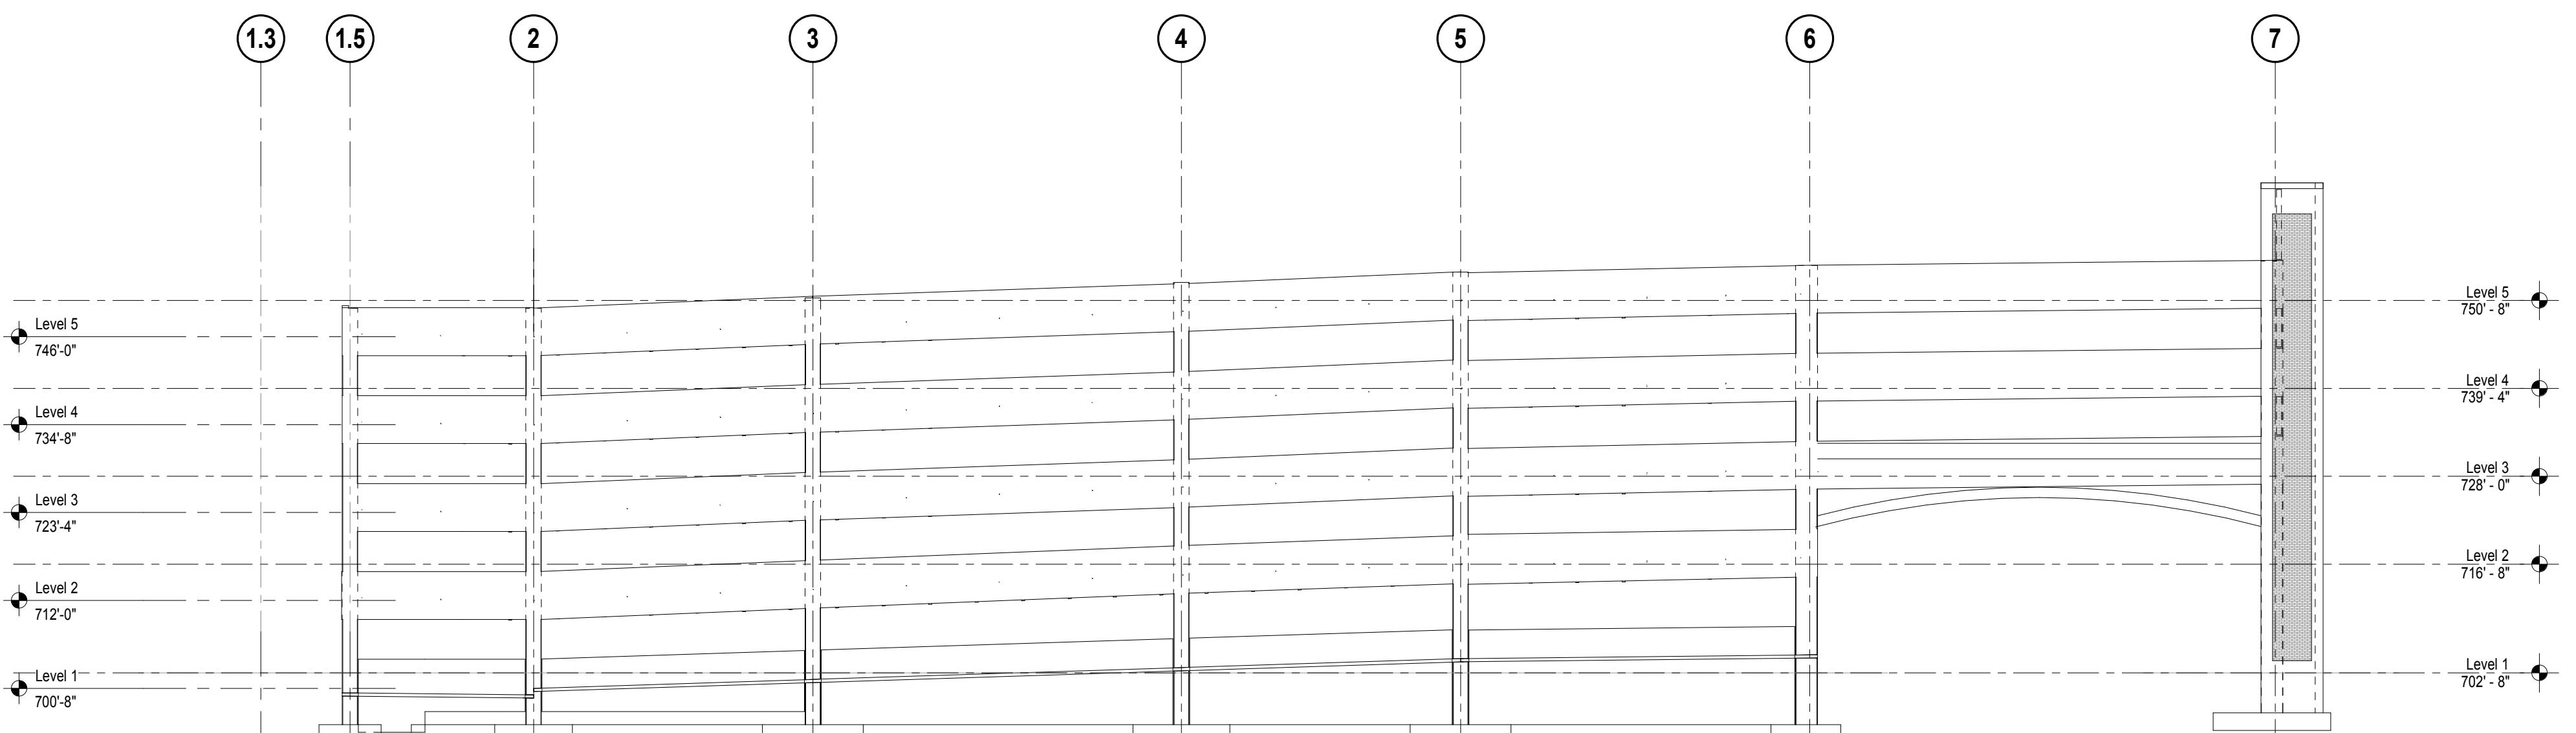

4 BUILDING ELEVATION - GRID LINE E - STRUCTURAL

4) BUILDING ELEVATION - GRID LINE E - STRUCTURAL
1/16" = 1'-0"

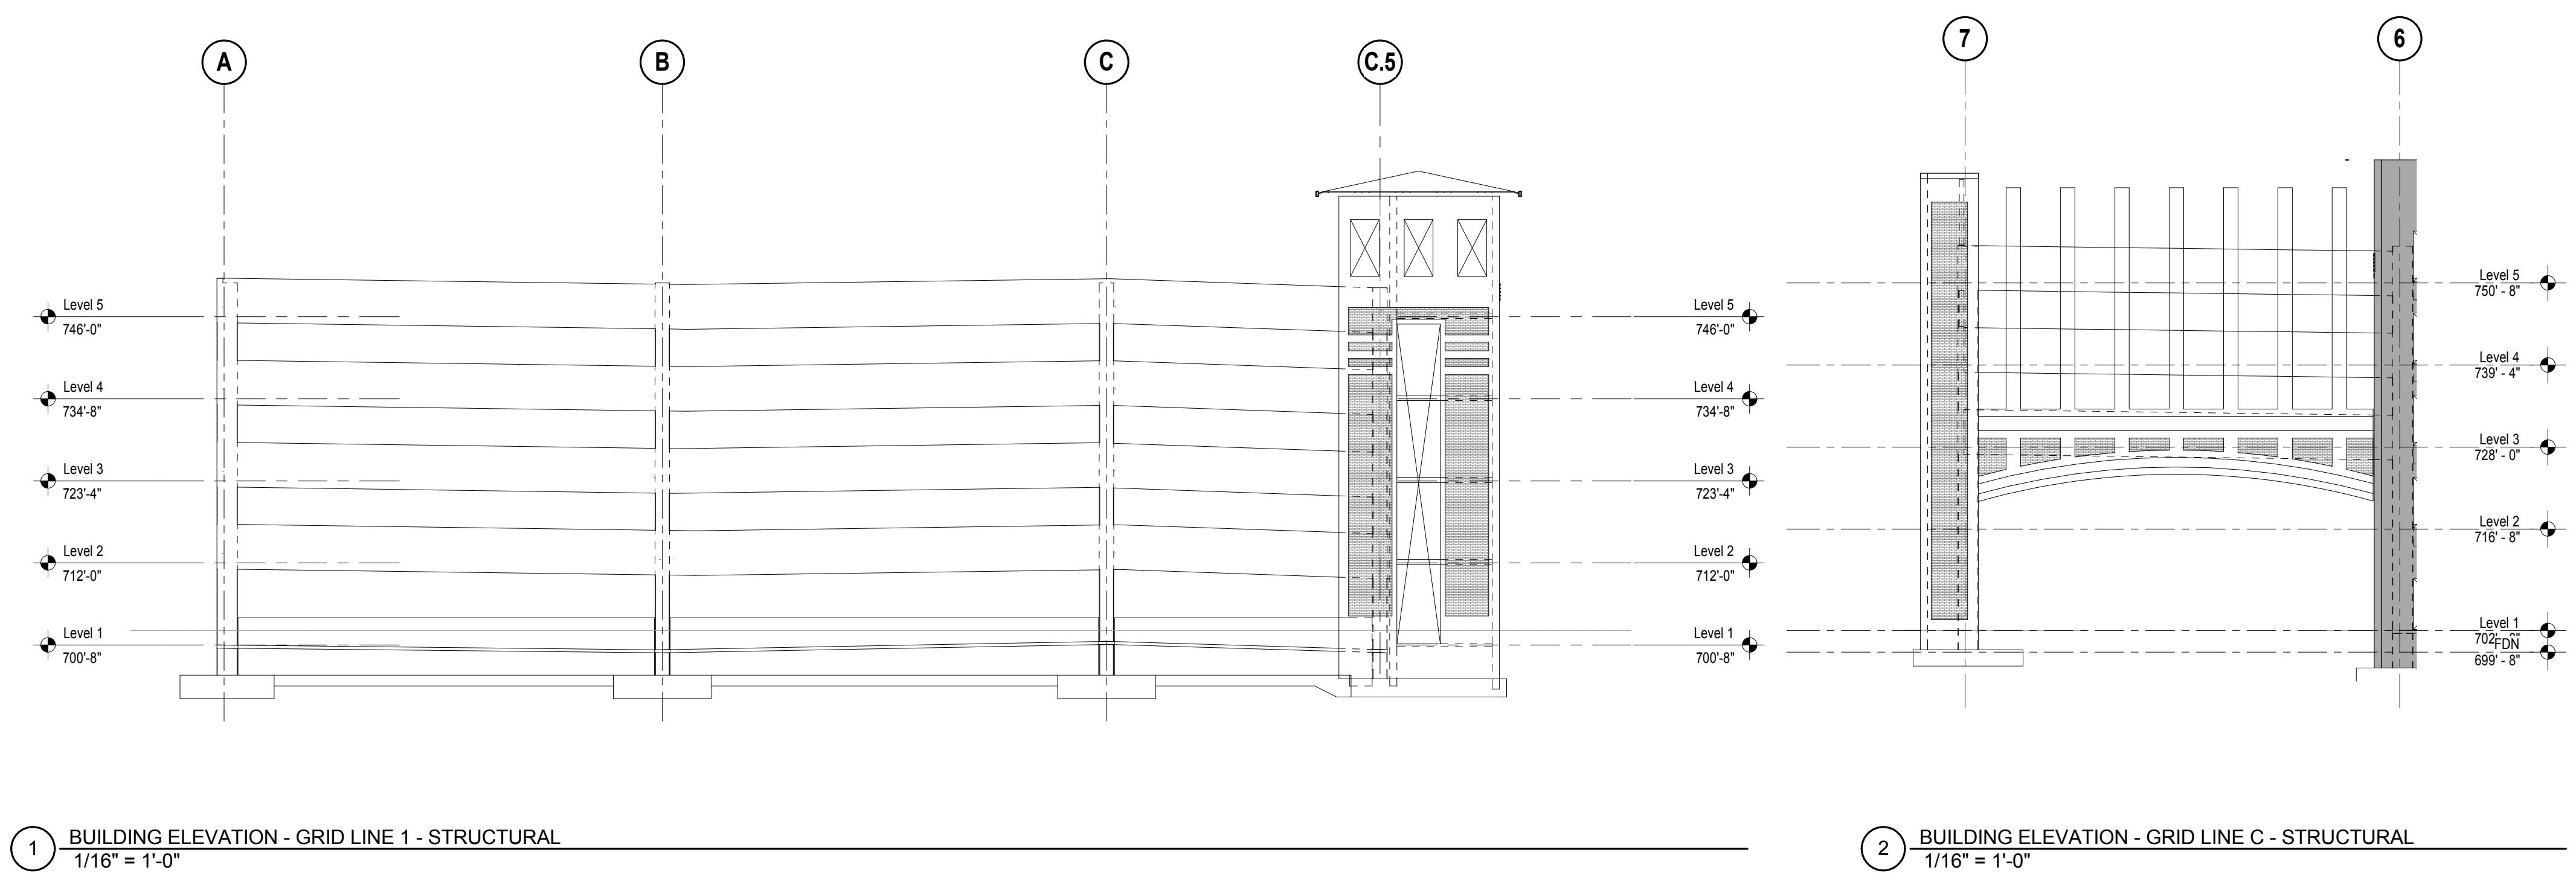

**Carl
Walker**
920 S. Highland Ave.
Suite 210
Lombard, IL 60148
Phone (630) 307-3800
Fax (630) 307-7030
www.carlwalker.com

The logo for Walsh Construction, featuring the word "WALSH" in a bold, sans-serif font. The letter "W" is stylized with a vertical line through the middle and a horizontal line at the bottom, while the other letters are simple blocks.

Walsh Construction Company
929 West Adams
Chicago, Illinois 60607
Phone: (312) 563-5400

MAIN STREET TRIANGLE PARKING STRUCTURE

9650 143rd Street
Orland Park, Illinois

SHEETS INCLUDED FOR REFERENCE ONLY

NOT FOR CONSTRUCTION

PROJECT NO.	N1-2015-196
RAWN BY	Ray Mulvaney
HECKED BY	Russ Randall

SHEET TITLE
BUILDING ELEVATIONS -
STRUCTURAL

