
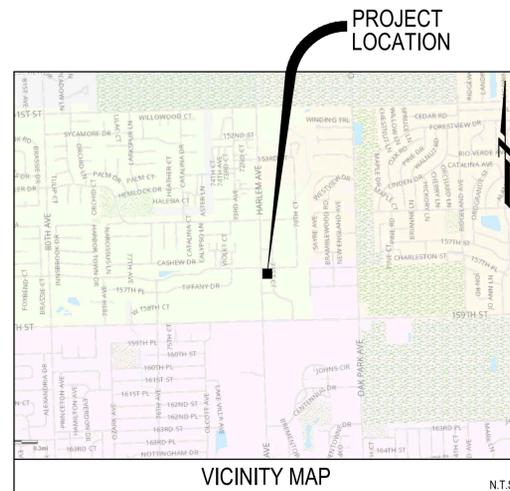


RAINBOW CONE

15711 S. HARLEM AVE., ORLAND PARK

FINAL ENGINEERING PLANS

| LEGEND | | |
|----------|----------|--------------------------------------|
| EXISTING | PROPOSED | DESCRIPTION |
| | | LIGHT STANDARD/DOUBLE LIGHT STANDARD |
| | | WATER VALVE VAULT |
| | | WATER VALVE BOX |
| | | FIRE HYDRANT |
| | | BUFFALO BOX |
| | | SANITARY MANHOLE |
| | | FLARED END SECTION |
| | | STORM INLET |
| | | STORM CATCH BASIN |
| | | STORM MANHOLE |
| | | CLEANOUT |
| | | STORM SEWER PIPE |
| | | SANITARY SEWER PIPE |
| | | WATER MAIN PIPE |
| | | FORCE MAIN PIPE |
| | | STORM SEWER SERVICE |
| | | SANITARY SEWER SERVICE |
| | | WATER MAIN SERVICE |
| | | SANITARY RIM ELEVATION |
| | | SANITARY INVERT ELEVATION |
| | | WATER GRADE RING ELEVATION |
| | | WATER STATION LOCATION |
| | | STORM RIM ELEVATION |
| | | STORM INVERT ELEVATION |
| | | PROPOSED SANITARY STRUCTURE LABEL |
| | | PROPOSED WATER STRUCTURE LABEL |
| | | PROPOSED STORM STRUCTURE LABEL |
| | | PROPOSED RETAINING WALL |
| | | CURB AND GUTTER |
| | | DEPRESSED CURB AND GUTTER |
| | | REVERSE CURB AND GUTTER |
| | | SIDEWALK |
| | | SWALE FLOW ARROW |
| | | DRAINAGE ARROW |
| | | OVERLAND FLOW |
| | | 1 FOOT CONTOURS |
| | | ACCESSIBLE CURB RAMP |

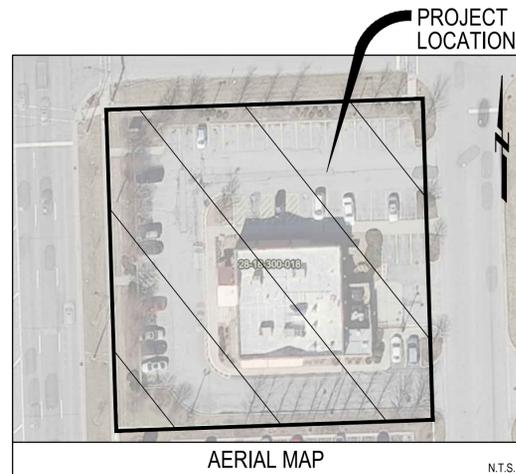


| INDEX OF DRAWINGS | |
|-------------------|--|
| SHEET NO. | DRAWING TITLE |
| C1.0 | COVER SHEET |
| C2.0 | EXISTING CONDITIONS AND SOIL EROSION & SEDIMENT CONTROL PLAN |
| C2.1 | SITE DEMO PLAN |
| C3.0 | SITE DIMENSIONAL PLAN |
| C4.0 | SITE UTILITY & GRADING PLAN |
| C5.0 | CONSTRUCTION DETAILS |
| C6.0 | GENERAL NOTES & SPECIFICATIONS |
| L1.0 | EXISTING LANDSCAPE AND TREE MITIGATION |
| L2.0 | LANDSCAPE PLAN AND TABLE |

| ABBREVIATIONS | | | |
|---------------|--------------------------------|--------|----------------------------|
| ADJ | ADJUST | E | ELECTRIC |
| AGG | AGGREGATE GRAVEL | E-E | EDGE TO EDGE |
| B.A.M. | BIT. AGG. MIXTURE | ELEV. | ELEVATION |
| B-B | BACK TO BACK | EP | EDGE OF PAVEMENT |
| B/P | BOTTOM OF PIPE | EX | EXISTING |
| BWALL | GROUND AT BOTTOM OF WALL | F.E. | FIELD ENTRANCE |
| B.B. | BUFFALO BOX | FF | FACE TO FACE |
| BIT. | BITUMINOUS CONCRETE | FF | FINISHED FLOOR |
| BM | BENCHMARK | FES | FLARED END SECTION |
| B.O. | BY OTHERS | FH | FIRE HYDRANT |
| C.E. | COMMERCIAL ENTRANCE | FL | FLOW LINE |
| CB | CATCH BASIN | FM | FORCE MAIN |
| CL | CENTERLINE | G | GROUND |
| CLID | CLOSED LID | GAS | GAS |
| CMP | CORRUGATED METAL PIPE | GU | GUTTER ELEVATION |
| CNTRL | CONTROL | GW | GUY WIRE |
| C.O. | CLEAN OUT | H.C. | HANDICAP |
| CONC. | CONCRETE | HDWL | HEADWALL |
| CY | CUBIC YARD | HH | HANDHOLE |
| D | DITCH | HWL | HIGH WATER LEVEL |
| DIA. | DIAMETER | INL | INLET |
| DIP | DUCTILE IRON PIPE | INV. | INVERT |
| DWM | DUCTILE IRON WATER MAIN | IP | IRON PIPE |
| DT | DRAIN TILE | MAX. | MAXIMUM |
| D.S. | DOWN SPOUT | MB | MAILBOX |
| MH | STORM MANHOLE | MIN. | MINIMUM |
| NWL | NORMAL WATER LEVEL | OLID | OPEN LID |
| P.E. | PRIVATE ENTRANCE | P.E. | PERFORATED |
| P.C. | POINT OF CURVE | P.C.C. | PORTLAND CEMENT CONCRETE |
| P.C.C. | PORTLAND CEMENT CONCRETE | P.C.C. | POINT OF COMPOUND CURVE |
| PGL | PROFILE GRADE LINE | PI | POINT OF INTERSECTION |
| PL | PROPERTY LINE | PL | POWER POLE |
| PP | POWER POLE | PROP. | PROPOSED |
| PT | POINT OF TANGENCY | PVC | POLYVINYL CHLORIDE PIPE |
| P.V.C. | POINT OF VERTICAL CURVE | P.V.C. | POINT OF VERTICAL CURVE |
| PVI | POINT OF VERTICAL INTERSECTION | PVT | POINT OF VERTICAL TANGENCY |
| P | PAVEMENT | R | RADIUS |
| R | RADIUS | R.O.W. | RIGHT-OF-WAY |
| R.C.P. | REINFORCED CONCRETE PIPE | REM | REMOVAL |
| RT | RIGHT | RR | RAILROAD |
| SAN | SANITARY SEWER | RT | RIGHT |
| SF | SQUARE FOOT | SAN | SANITARY SEWER |
| SHLD. | SHOULDER | SF | SQUARE FOOT |
| SL | STREET LIGHT | SHLD. | SHOULDER |
| SMH | SANITARY MANHOLE | SL | STREET LIGHT |
| ST | STORM SEWER | SMH | SANITARY MANHOLE |
| STA. | STATION | ST | STORM SEWER |
| STD | STANDARD | STA. | STATION |
| SW | SIDEWALK | STD | STANDARD |
| SY | SQUARE YARDS | SW | SIDEWALK |
| TBR | TO BE REMOVED | SY | SQUARE YARDS |
| T | TELEPHONE | TBR | TO BE REMOVED |
| T.A | TYPE A | T | TELEPHONE |
| TIC | TOP OF CURB | T.A | TYPE A |
| TIF | TOP OF FOUNDATION | TIC | TOP OF CURB |
| TIP | TOP OF PIPE | TIF | TOP OF FOUNDATION |
| TW | TOP OF WALK | TIP | TOP OF PIPE |
| TWALL | TOP OF WALL | TW | TOP OF WALK |
| TEMP | TEMPORARY | TWALL | TOP OF WALL |
| TRANS | TRANSFORMER | TEMP | TEMPORARY |
| V.B. | VALVE BOX | TRANS | TRANSFORMER |
| V.V. | VALVE VAULT | V.B. | VALVE BOX |
| WL | WATER LEVEL | V.V. | VALVE VAULT |
| WM | WATER MAIN | WL | WATER LEVEL |

NOTE:
THE LOCATION, ELEVATION, SIZE, AND TYPES OF ALL EXISTING UNDERGROUND UTILITIES ARE SHOWN IN AN APPROXIMATE WAY ONLY AND HAVE NOT BEEN INDEPENDENTLY VERIFIED BY THE OWNER OR ITS REPRESENTATIVE. THE CONTRACTOR SHALL BE RESPONSIBLE FOR DETERMINING THE EXACT LOCATION, ELEVATION, SIZE AND TYPES OF ALL EXISTING UTILITIES PRIOR TO COMMENCING WORK AND AGREES TO BE FULLY RESPONSIBLE FOR ANY AND ALL DAMAGES WHICH MIGHT BE OCCASIONED BY THE CONTRACTOR'S FAILURE TO EXACTLY LOCATE AND PRESERVE ANY AND ALL UNDERGROUND UTILITIES.

REVISIONS

SUSTAINABLE DESIGN | SUSTAINABLE LIVING
Wolf Pack CONSULTING, LLC
 Civil Engineering
 Land Planning
 Land Surveying
 Project Entitlements
 Stormwater Management
 418 South Cass Avenue, Westmont, IL 60559
 Office: (630) 964-3117 • wolfpackcdg.com

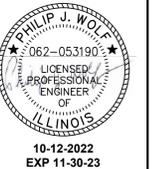

COVER SHEET
 RAINBOW CONE
 15711 S. HARLEM AVE., ORLAND PARK

PROJ. MGR.: PJW
 PROJ. ENG.: KM
 DRAWN BY: KM
 DATE: 09-16-22
 SCALE: N.T.S.

SHEET NO.
C1.0


PROJ. NUMBER:

Call Before You Dig
1-800-4-A-DIG
 CONTACT JULIE AT 811
 OR 800-892-0123
 48 HOURS (2 working days) BEFORE YOU DIG


☒ SOUTH HARLEM AVENUE

☒ WEST 157TH STREET

☒ SOUTH 71ST COURT

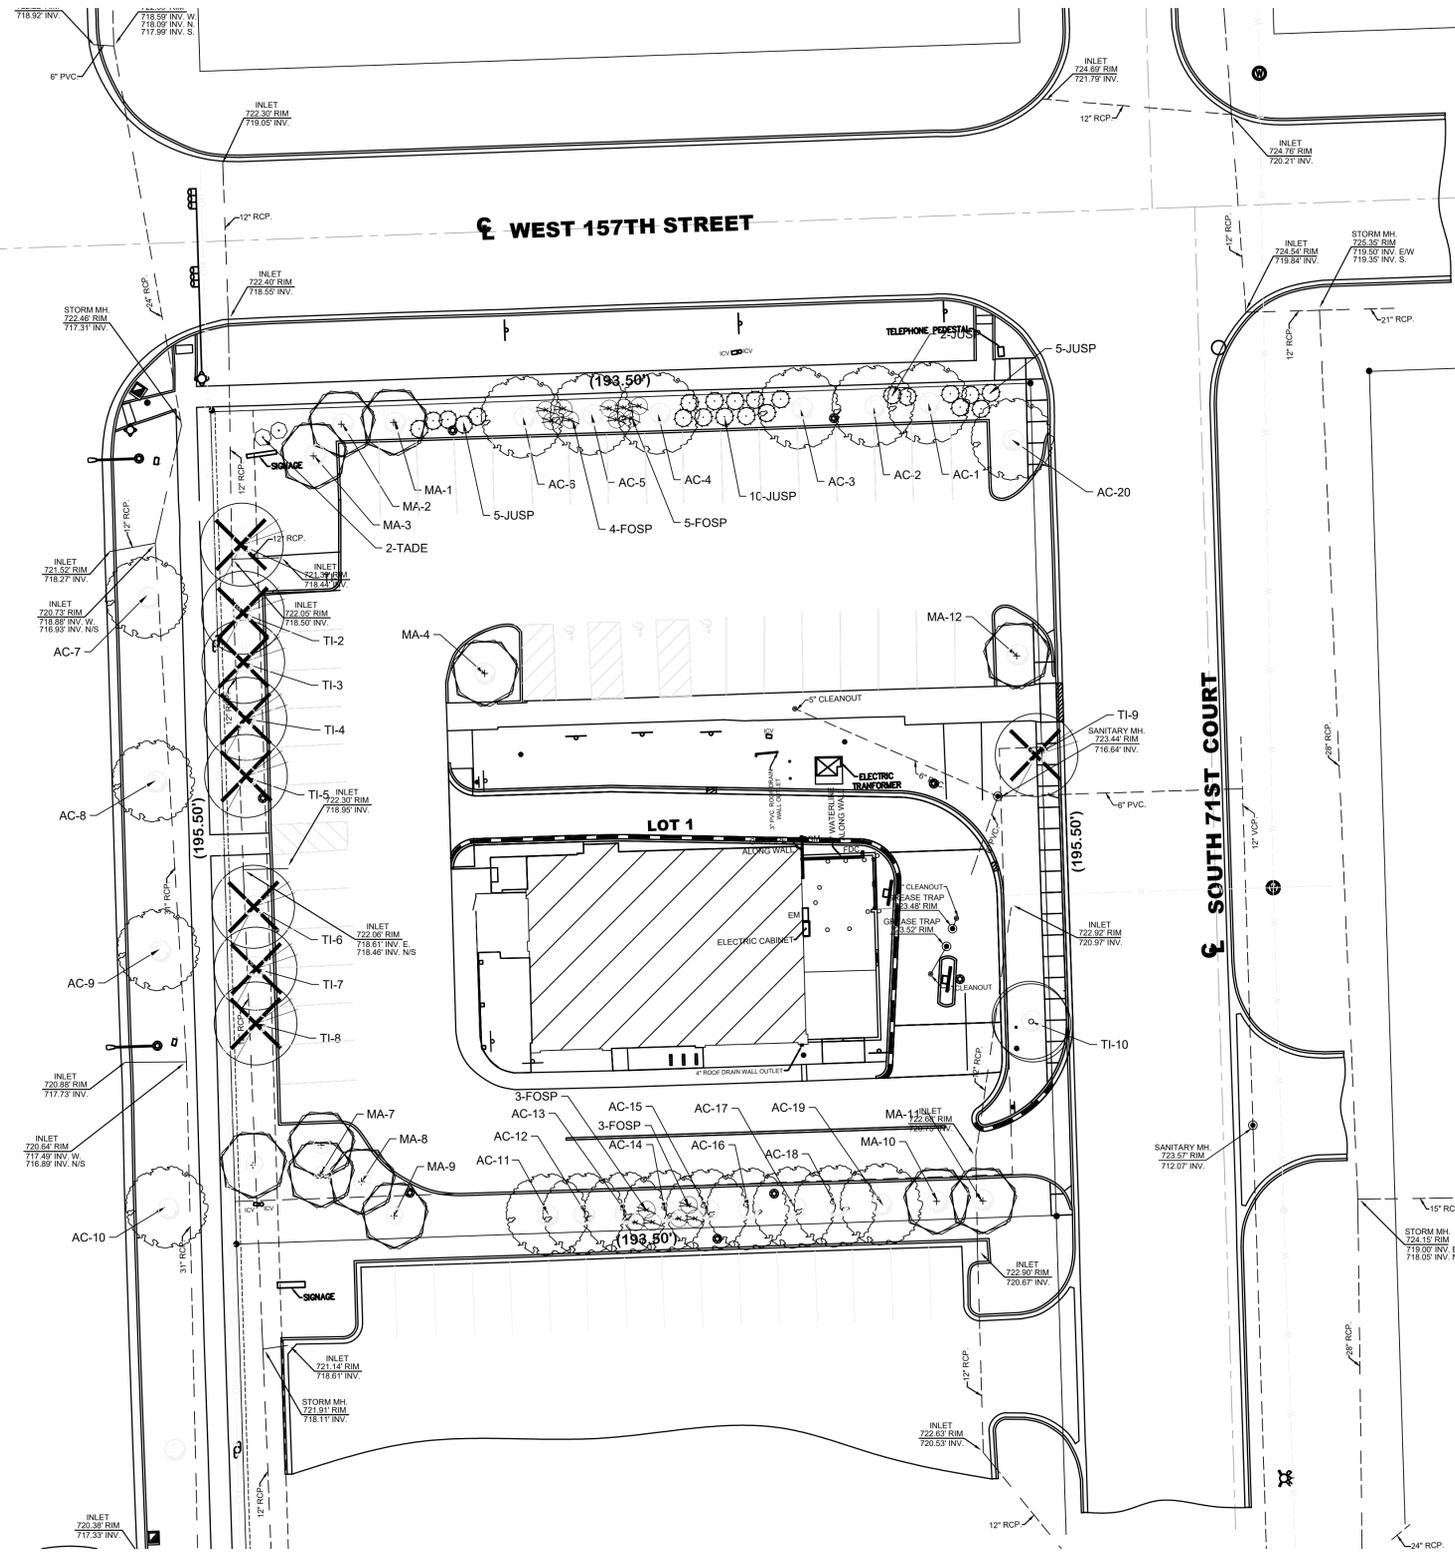

X = TREE TO BE REMOVED

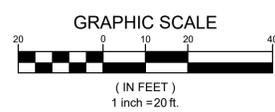

EXISTING PLANT SCHEDULE (TO REMAIN)

| SHADE TREES | | | | | | |
|-------------|-----|------|-------------------------|-------------------|------------|-------|
| KEY | QTY | SIZE | SPECIES | COMMON | CONDITION* | NOTES |
| AC-1 | 1 | 8" | <i>Acer x freemanii</i> | Freeman Maple | 5 | |
| AC-2 | 1 | 8" | <i>Acer x freemanii</i> | Freeman Maple | 5 | |
| AC-3 | 1 | 9" | <i>Acer x freemanii</i> | Freeman Maple | 4 | |
| AC-4 | 1 | 8" | <i>Acer x freemanii</i> | Freeman Maple | 5 | |
| AC-5 | 1 | 8" | <i>Acer x freemanii</i> | Freeman Maple | 4 | |
| AC-6 | 1 | 8" | <i>Acer x freemanii</i> | Freeman Maple | 4 | |
| AC-7 | 1 | 3" | <i>Acer x freemanii</i> | Freeman Maple | 5 | |
| AC-8 | 1 | 3" | <i>Acer x freemanii</i> | Freeman Maple | 5 | |
| AC-9 | 1 | 3" | <i>Acer x freemanii</i> | Freeman Maple | 5 | |
| AC-10 | 1 | 3" | <i>Acer x freemanii</i> | Freeman Maple | 5 | |
| AC-11 | 1 | 8" | <i>Acer x freemanii</i> | Freeman Maple | 4 | |
| AC-12 | 1 | 6" | <i>Acer x freemanii</i> | Freeman Maple | 5 | |
| AC-13 | 1 | 6" | <i>Acer x freemanii</i> | Freeman Maple | 5 | |
| AC-14 | 1 | 7" | <i>Acer x freemanii</i> | Freeman Maple | 5 | |
| AC-15 | 1 | 7" | <i>Acer x freemanii</i> | Freeman Maple | 5 | |
| AC-16 | 1 | 7" | <i>Acer x freemanii</i> | Freeman Maple | 5 | |
| AC-17 | 1 | 7" | <i>Acer x freemanii</i> | Freeman Maple | 5 | |
| AC-18 | 1 | 8" | <i>Acer x freemanii</i> | Freeman Maple | 5 | |
| AC-19 | 1 | 7" | <i>Acer x freemanii</i> | Freeman Maple | 5 | |
| AC-20 | 1 | 9" | <i>Acer x freemanii</i> | Freeman Maple | 5 | |
| TI-10 | 1 | 10" | <i>Tilia cordata</i> | Littleleaf Linden | 4 | |

| ORNAMENTAL TREES | | | | | | |
|------------------|-----|------|-------------------|-----------|------------|----------------|
| KEY | QTY | SIZE | SPECIES | COMMON | CONDITION* | NOTES |
| MA-1 | 1 | 12" | <i>Malus spp.</i> | Crabapple | 5 | |
| MA-2 | 1 | 9" | <i>Malus spp.</i> | Crabapple | 5 | |
| MA-3 | 1 | 9" | <i>Malus spp.</i> | Crabapple | 4 | |
| MA-4 | 1 | 7" | <i>Malus spp.</i> | Crabapple | 4 | |
| MA-5 | 1 | 3" | <i>Malus spp.</i> | Crabapple | 4 | MULTISTEM FORM |
| MA-6 | 1 | 3" | <i>Malus spp.</i> | Crabapple | 3 | MULTISTEM FORM |
| MA-7 | 1 | 3" | <i>Malus spp.</i> | Crabapple | 4 | MULTISTEM FORM |
| MA-8 | 1 | 3" | <i>Malus spp.</i> | Crabapple | 4 | MULTISTEM FORM |
| MA-9 | 1 | 3" | <i>Malus spp.</i> | Crabapple | 4 | MULTISTEM FORM |
| MA-10 | 1 | 10" | <i>Malus spp.</i> | Crabapple | 4 | |
| MA-11 | 1 | 12" | <i>Malus spp.</i> | Crabapple | 4 | |
| MA-12 | 1 | 8" | <i>Malus spp.</i> | Crabapple | 4 | |

| DECIDUOUS SHRUBS | | | | | | |
|------------------|-----|--------|----------------------|-----------|------------|-------|
| KEY | QTY | SIZE | SPECIES | COMMON | CONDITION* | NOTES |
| FOSP | 15 | 36" HT | <i>Forsythia sp.</i> | Forsythia | 3 - 4 | |

| EVERGREEN SHRUBS | | | | | | |
|------------------|-----|-----------|--------------------------|-----------|------------|-------|
| KEY | QTY | SIZE | SPECIES | COMMON | CONDITION* | NOTES |
| JUSP | 20 | 24-30" ht | <i>Juniperus sp.</i> | Juniper | 3 - 5 | |
| TADE | 2 | 24" ht. | <i>Taxus densiformis</i> | Dense Yew | 4 | |

*CONDITION KEY
5 = EXCELLENT; 4 = GOOD; 3 = FAIR; 2 = POOR; 1 = CRITICAL

TREES TO BE REMOVED (TREE MITIGATION)

| SHADE TREES | | | | | | |
|-------------|-----|------|----------------------|-------------------|------------|------------|
| KEY | QTY | SIZE | SPECIES | COMMON | CONDITION* | MITIGATION |
| TI-1 | 1 | 10" | <i>Tilia cordata</i> | Littleleaf Linden | 3 | 1 TREE |
| TI-2 | 1 | 9" | <i>Tilia cordata</i> | Littleleaf Linden | 2 | 1 TREE |
| TI-3 | 1 | 10" | <i>Tilia cordata</i> | Littleleaf Linden | 2 | 1 TREE |
| TI-4 | 1 | 9" | <i>Tilia cordata</i> | Littleleaf Linden | 2 | 1 TREE |
| TI-5 | 1 | 10" | <i>Tilia cordata</i> | Littleleaf Linden | 3 | 1 TREE |
| TI-6 | 1 | 11" | <i>Tilia cordata</i> | Littleleaf Linden | 2 | 1 TREE |
| TI-7 | 1 | 9" | <i>Tilia cordata</i> | Littleleaf Linden | 3 | 1 TREE |
| TI-8 | 1 | 10" | <i>Tilia cordata</i> | Littleleaf Linden | 2 | 1 TREE |
| TI-9 | 1 | 7" | <i>Tilia cordata</i> | Littleleaf Linden | 3 | 1 TREE |

TOTAL MITIGATION TREES 9 TREES

| REVISIONS | |
|-----------|----------------------------|
| 6/14/22 | REVISED PER VILLAGE REVIEW |
| 7/20/22 | REVISED PER VILLAGE REVIEW |

SUSTAINABLE DESIGN | SUSTAINABLE LIVING

Wolf Pack CONSULTING, LLC

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EXISTING LANDSCAPE AND TREE MITIGATION

RAINBOW CONE


15711 S HARLEM AVE, ORLAND PARK

| | |
|-----------------------|----------|
| PROJ. MGR.: | PJW |
| PROJ. ENG.: | KM |
| DRAWN BY: | MD |
| DATE: | 04-19-22 |
| SCALE: | 1"=20' |
| SHEET NO. L1.0 | |
| PROJ. NUMBER: | |

SOUTH HARLEM AVENUE



WEST 157TH STREET

SOUTH 71ST COURT

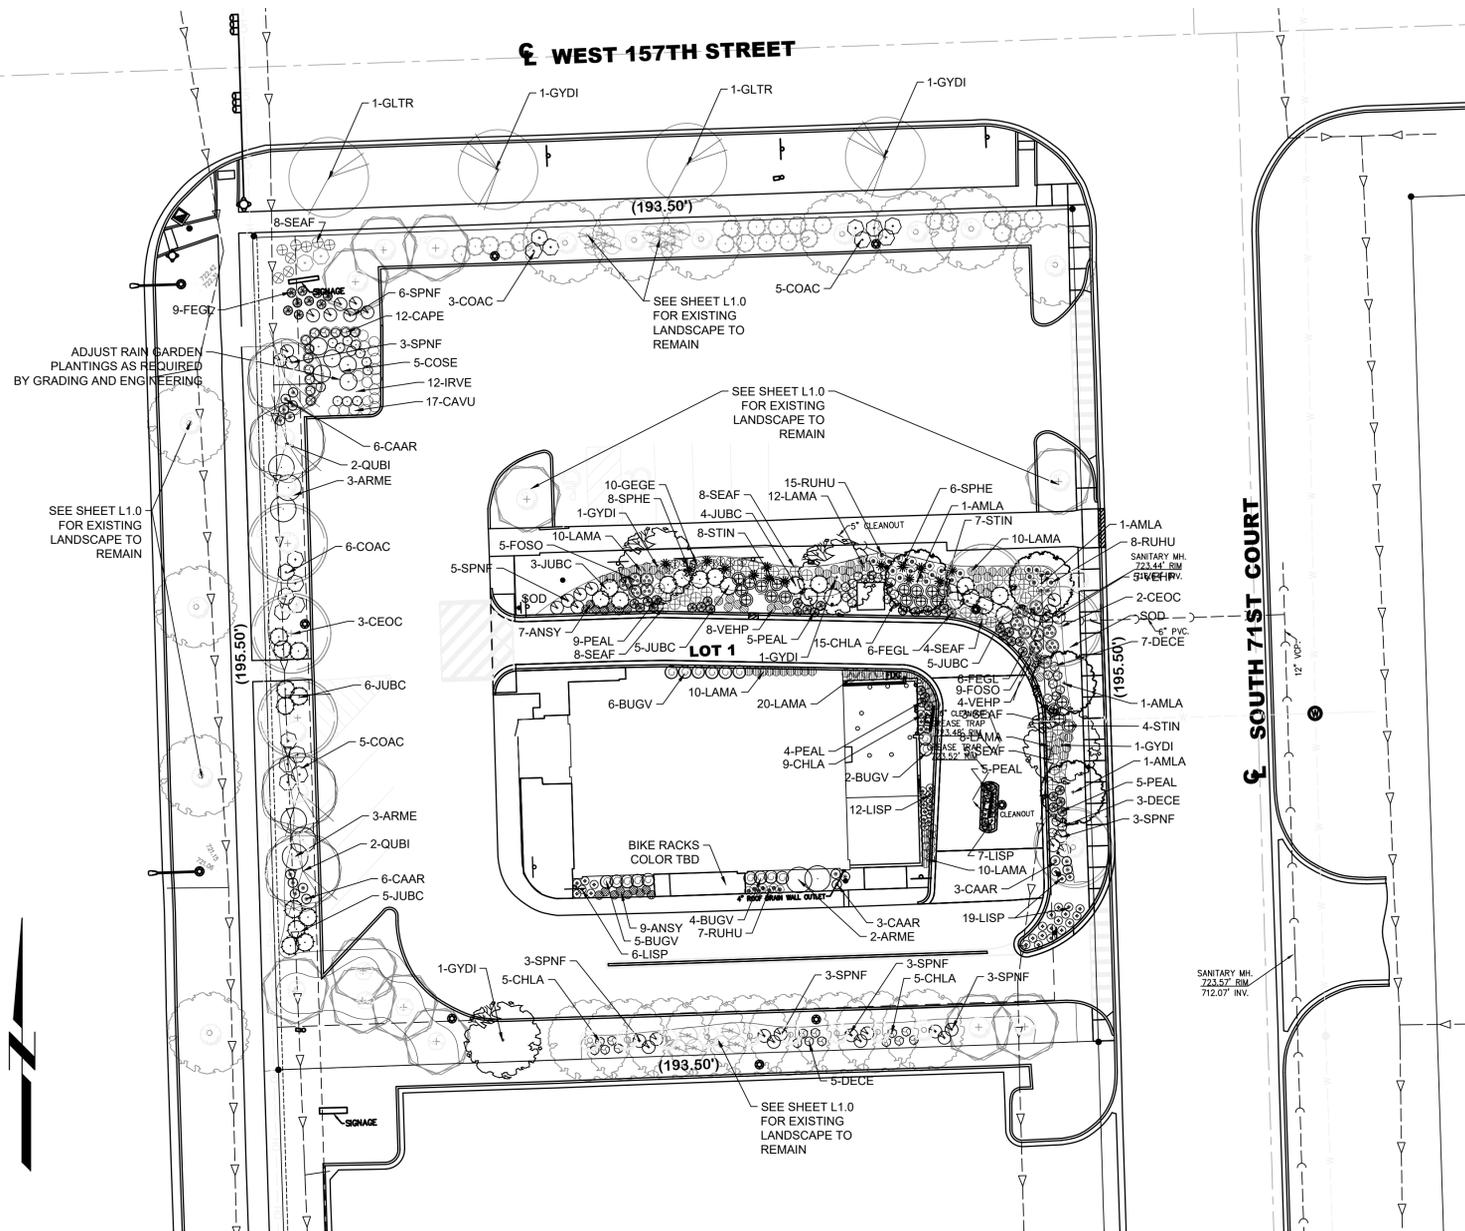


| PLANT SCHEDULE | | | | | |
|--|----------|---|------------------------------|----------|--------------|
| Key | QTY | Scientific Name | Common Name | Height | Container |
| SHADE TREES | | | | | |
| CEOC | 5 | <i>Celtis occidentalis</i> | Hackberry | 2.5" cal | B&B |
| GLTR | 2 | <i>Gleditsia triacanthos var. inermis</i> 'Skycole' | Skyline Honeylocust | 2.5" cal | B&B |
| GYDI | 2 | <i>Gymnocladus dioica</i> | Kentucky Coffeetree | 2.5" cal | B&B |
| QUBI | 4 | <i>Quercus bicolor</i> | Swamp White Oak | 2.5" cal | B&B |
| TADI | 4 | <i>Taxodium distichum</i> | Baldcypress | 2.5" cal | B&B |
| ORNAMENTAL TREES | | | | | |
| AMLA | 4 | <i>Amelanchier laevis</i> 'Cumulus' | Cumulus Serviceberry | 2.5" cal | B&B |
| DECIDUOUS SHRUBS | | | | | |
| ARME | 8 | <i>Aronia melanocarpa var. 'Eleta'</i> | Black Chokeberry | 24" ht. | #5 container |
| COSE | 5 | <i>Cornus sericea</i> 'Isanti' | Isanti Redtwig Dogwood | 24" ht. | #3 container |
| COAC | 19 | <i>Cotoneaster acutifolius</i> | Peking Cotoneaster | 24" ht. | #3 container |
| FOSO | 14 | <i>Forsythia x 'Mindor'</i> | Show Off Forsythia | 24" ht. | #3 container |
| SPNF | 24 | <i>Spiraea japonica</i> 'Neon Flash' | Neon Flash Spirea | 24" ht. | #5 container |
| STIN | 19 | <i>Stephanandra incisa</i> 'Crispa' | Cutleaf Stephanandra | 24" ht. | #5 container |
| EVERGREEN SHRUBS | | | | | |
| BUGV | 17 | <i>Buxus x 'Green Velvet'</i> | Green Velvet Boxwood | 18" w | B&B |
| JUBC | 28 | <i>Juniperus horizontalis</i> 'Blue Chip' | Blue Chip Juniper | 18" w | #5 container |
| GRASSES AND SEDGES | | | | | |
| CAAR | 18 | <i>Calamagrostis arundinacea var brachytricha</i> | Korean Feather Reed Grass | | #1 container |
| CAPE | 12 | <i>Carex pensylvanica</i> | Oak Sedge | | #1 container |
| CAVU | 17 | <i>Carex vulpinoidea</i> | Brown Fox Sedge | | #1 container |
| CHLA | 25 | <i>Chasmanthium latifolium</i> | Northern Sea Oats | | #1 container |
| DECE | 15 | <i>Deschampsia cespitosa</i> | Tufted Hair Grass | | #1 container |
| FEGL | 15 | <i>Festuca glauca</i> 'Elijah Blue' | Elijah Blue Fescue | | #1 container |
| PEAL | 28 | <i>Pennisetum alopecuroides</i> 'Hameln' | Dwarf Fountain Grass | | #1 container |
| SPHE | 14 | <i>Sporobolus heterolepis</i> | Prairie Dropseed | | #1 container |
| PERENNIALS | | | | | |
| ANSY | 16 | <i>Anemone sylvestris</i> | Snowdrop Anemone | | #1 container |
| GEGE | 10 | <i>Geranium 'Gerwat'</i> | Rozanne Geranium | | #1 container |
| IRVE | 12 | <i>Irns versicolor</i> | Harlequin Blue Flag | | #1 container |
| LAMA | 70 | <i>Lamium maculatum</i> 'White Nancy' | White Nancy Deadnettle | 3" plug | 10 tray |
| LISP | 53 | <i>Liriope spicata</i> | Creeping Lilyturf | | #1 container |
| RUHU | 30 | <i>Ruellia humilis</i> | Wild Petunia | | #1 container |
| SEAF | 36 | <i>Sedum spectabile</i> 'Autumn Fire' | Autumn Fire Stonecrop | | #1 container |
| VEHP | 12 | <i>Veronica spicata</i> 'Glory' | Glory Speedwell | | #1 container |
| TURF | | | | | |
| SOD | 3,298 SF | Black Beauty Tall Fescue Sod | Black Beauty Tall Fescue Sod | n/a | n/a |
| NOTES | | | | | |
| 1 All plant material shall comply with the American Standards for Nursery Stock, ANSI Z60.1-2014. | | | | | |
| 2 Plant material shall be guaranteed for a period of one year from the time of acceptance. Any plant material replaced as part of guarantee shall be guaranteed for a period of one year from date of replacement. Contractor shall notify Owner of any maintenance deficiencies which may impact viability of warranted plant material. | | | | | |
| 3 Contractor is responsible for staking and guying trees as necessary to maintain upright position. | | | | | |


GRAPHIC SCALE

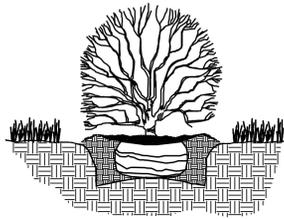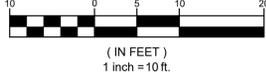


SHRUB PLANTING
NO SCALE

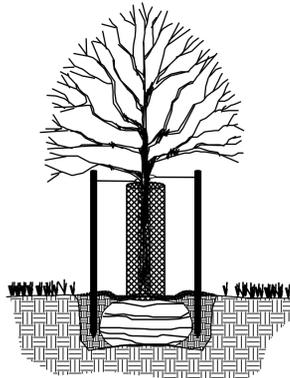

DECIDUOUS TREE PLANTING
NO SCALE

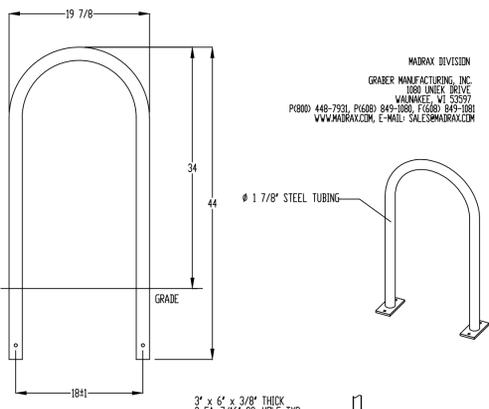

BIKE RACK
NO SCALE

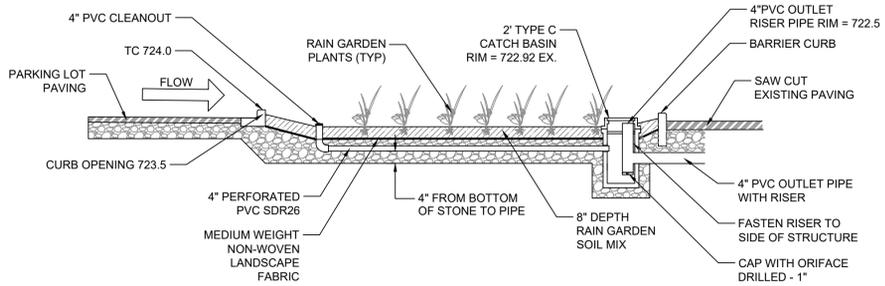

RAIN GARDEN TYPICAL SECTION
NO SCALE

LANDSCAPE CODE SUMMARY

| LOCATION | LENGTH/AREA | PLANT MATERIAL REQUIRED | PLANT MATERIAL PROVIDED |
|--|-------------|---|---|
| LANDSCAPE PARKWAYS (6-305.D.2) | | | |
| S. HARLEM AVE | 195.5 LF | 4.9 Trees | 4 Trees to Remain |
| W. 157TH ST | 193.5 LF | 4.8 Trees | 4 Shade Trees |
| S. 71ST CT | 195.5 LF | 4.9 Trees | 0 Shade Trees - site does not provide space |
| LANDSCAPE CORRIDORS (6-305.D.3) | | | |
| S. HARLEM AVE | 195.5 LF | 3.9 Shade Trees 3.9 Ornamental or Evergreen | 8 Shade Trees to Remain 1 Orn Tree to Remain |
| W. 157TH ST | 193.5 LF | 1.9 Ornamental or Evergreen | 6 Shade Trees to Remain 3 Orn Tree to Remain |
| S. 71ST CT | 195.5 LF | 1.9 Ornamental or Evergreen | 3 Orn/ Small Shade Trees Proposed |
| LANDSCAPE BUFFERYARDS (6-305.D.4) | | | |
| SOUTH | 193.5 LF | 5.8 Shade Trees 1.9 Ornamental or Evergreen 30.9 Shrubs | 9 Shade Trees to Remain 6 Orn Trees to Remain 6 Shrubs to Remain 22 New Shrubs |
| FOUNDATION AND INTERIOR LANDSCAPE (6-305.D.5) | | | |
| BUILDING FACE | 221.5 LF | 2.2 Ornamental Trees 35.4 Shrubs | see plans and summary |
| INTERIOR LOT | 37,829 SF | 3.8 Trees | see plans and summary |

| PARKING LOT ISLAND (6-305.D.6a2) | | |
|----------------------------------|----|---|
| NUMBER OF PARKING SPACES | 40 | |
| REQUIRED ISLANDS | 4 | |
| PROVIDED ISLANDS | 4 | |
| REQUIRED PARKING ISLAND TREES | 4 | |
| PROVIDED PARKING ISLAND TREES | 3 | Island at northwest corner planted as rain garden in lieu of island tree. |

| TREE MITIGATION (6-305.F.3) | |
|--|---|
| MITIGATION TREES REQUIRED (SEE SHEET L1.0) | 9 |

| SUMMARY | | | | |
|-----------------------------|----------|-----------|---------------------|----------------|
| CATEGORY | REQUIRED | TO REMAIN | ADDITIONAL PROVIDED | TOTAL PROVIDED |
| SHADE TREES | 44.9 | 21 | 17 | 38 |
| ORNAMENTAL TREES/EVERGREENS | 11.8 | 12 | 4 | 16 |
| SHRUBS/ORN. GRASSES | 66.3 | 0 | 278 | 278 |

| REVISIONS | |
|-----------|----------------------------|
| 6/14/22 | REVISED PER VILLAGE REVIEW |
| 7/20/22 | REVISED PER VILLAGE REVIEW |
| 7/29/22 | REVISED PER VILLAGE REVIEW |
| 10/12/22 | REVISED PER VILLAGE REVIEW |

SUSTAINABLE DESIGN | SUSTAINABLE LIVING

Civil Engineering
Land Planning
Land Surveying
Project Entitlements
Stormwater Management

Wolf Pack CONSULTING, LLC

418 South Cass Avenue, Westmont, IL 60559
Office: (630) 964-3117 • wolfpackdgo.com

LANDSCAPE PLAN AND TABLE

RAINBOW CONE

15711 S HARLEM AVE, ORLAND PARK

PROJ. MGR.: PJW
PROJ. ENG.: KM
DRAWN BY: MD
DATE: 04-19-22
SCALE: 1"=20'

SHEET NO. **L2.0**

PROJ. NUMBER: