

CONSULTANT TEAM

PROJECT CONSULTANT:

TERRA CONSULTING GROUP, LTD.
600 BUSSE HIGHWAY
PARK RIDGE, IL 60068
(847) 698-6400

SURVEYOR:

ASM CONSULTANTS, INC.
P.O. BOX 7
PLANO, IL 60545
(630) 273-2500

APPROVALS

REAL ESTATE:

RF:

CONSTRUCTION:

EQUIPMENT ENGINEERING:

OPERATIONS:



PROJECT TYPE

PROPOSED LESSEE ANTENNAS MOUNTED ON A NEW MONOPOLE TOWER WITH PROPOSED 9'-4" X 16'-0" EQUIPMENT PLATFORM AT BASE.

SITE COORDINATES:

LATITUDE: 41° 36' 58.54" N (1A CERTIFICATION)
LONGITUDE: 87° 48' 53.39" W (1A CERTIFICATION)
ELEVATION: ±704' (1A)
DRIVING DIRECTIONS:

FROM LESSEE OFFICE: START OUT GOING EAST ON E WOODFIELD RD TOWARD MALL DR. TURN RIGHT ONTO W FRONTAGE RD. MERGE ONTO I-290 E VIA THE RAMP ON THE LEFT. KEEP RIGHT TO TAKE I-290 E TOWARD CHICAGO. MERGE ONTO I-294 S/TRI STATE TOLLWAY S VIA EXIT 15A TOWARD INDIANA (PORTIONS TOLL). MERGE ONTO I-55 N/ADLAI E STEVENSON EXPY N TOWARD CHICAGO. MERGE ONTO US-45 S/S LA GRANGE RD VIA EXIT 279A. TURN LEFT ONTO W 151ST ST. DESTINATION WILL BE ON THE RIGHT.

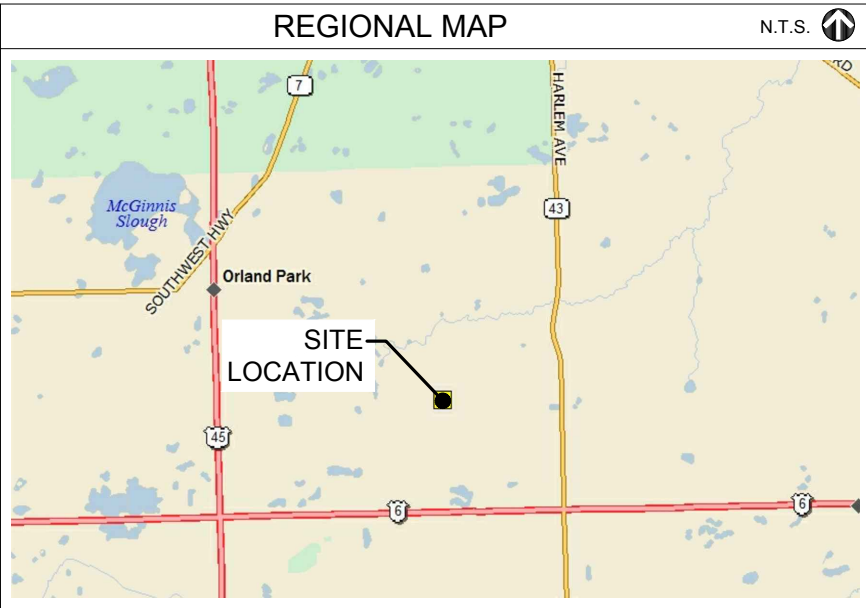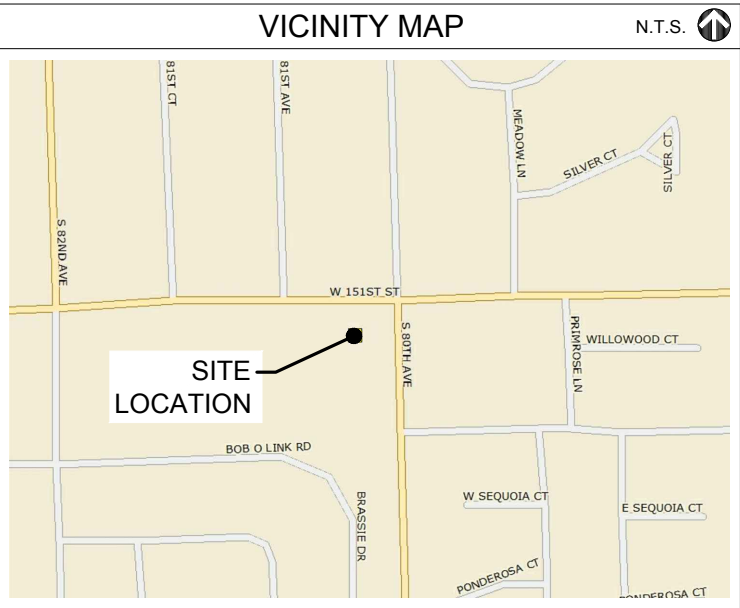

CHICAGO SMSA

limited partnership

CHICAGO SMSA LIMITED PARTNERSHIP
d/b/a VERIZON WIRELESS
1515 WOODFIELD ROAD, SUITE 1400
SCHAUMBURG, ILLINOIS 60173
PHONE: (847) 619-5397 FAX: (847) 706-7415

TOWER TO BE BUILT AND OWNED
BY DRA PROPERTIES LLC.

LOCATION NUMBER: 311466

SITE NAME: W 151ST & S 80TH

15100 S 80TH AVE
ORLAND PARK, IL 60462

GENERATOR TYPE: NATURAL GAS

MAKE: GENERAC
MODEL: SGNG-35-EV-1P 35KW NAT GAS 120/240
1-PH OUTDOOR STANDARD CONFIGURATION

OPERATES 24 HOURS
A DAY 365 DAYS A YEAR

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THOMAS A. ZIMMERMANN
062-053210
Exp 11/30/18
4/5/18

PROJECT INFORMATION

P.I.N. #:

27-14-201-010-0000

ADDRESS:

15100 S 80TH AVE
ORLAND PARK, IL 60462

UTILITIES:

POWER: COMED
LEONARD ANDERSON
(708) 235-2346

FIBER: ONE FIBER
WADE BOWERS
(512)618-3411

GAS: NICOR
KEVIN DOWNEY
(708) 441-6745

JURISDICTION:

VILLAGE OF ORLAND PARK

OCCUPANCY:

UNINHABITED
COMMERCIAL/RESIDENTIAL
RAWLAND

CONSTRUCTION TYPE:

PROPERTY OWNER:

ORLAND FIRE DISTRICT
15100 SOUTH 80TH AVE
ORLAND PARK, IL 60462

TOWER OWNER:

VILLAGE OF ORLAND PARK

CONTACT PERSON:

MARK WILLIAMS (847) 273-0488

APPLICANT:

CHICAGO SMSA
limited partnership
d/b/a Verizon Wireless
1515 WOODFIELD ROAD
SCHAUMBURG, IL 60173

CONSTRUCTION MANAGER:

RONALD PAULY (636) 534-4094

REAL ESTATE MANAGER:

DANNY PEREZ (847) 706-1765

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d/b/a VERIZON WIRELESS

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600 BUSSE HIGHWAY
PARK RIDGE, IL 60068
PH: 847-698-6400
FAX: 847-698-6401

REVISIONS

NO.	DESCRIPTION	DATE	BY
3	FINAL PENDING FIBER	08/21/17	DMS
4	UPDATE WITH NEW ECR	08/31/17	JTM
5	UPDATE WITH NEW LAYOUT	09/08/17	DMS
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7	ADDITION OF LANDSCAPING PLAN	12/29/17	JTM
8	UPDATE PER GAS COORDINATION	01/31/18	DMS
9	REVISED LANDSCAPE PLAN PER VILLAGE	04/05/18	JTM

LOC. # 311466

W 151ST
& S 80TH

15100 S 80TH AVE
ORLAND PARK, IL 60462

DRAWN BY:

PP

CHECKED BY:

TAZ

DATE:

07/23/15

PROJECT #:

33-1466

SHEET TITLE

TITLE SHEET

SHEET NUMBER


T-1



SURVEY PERFORMED BY:

Advanced Surveying & Mapping

Telephone (630) 273-2500
Fax (630) 273-2600
E-MAIL asmc@advct.com

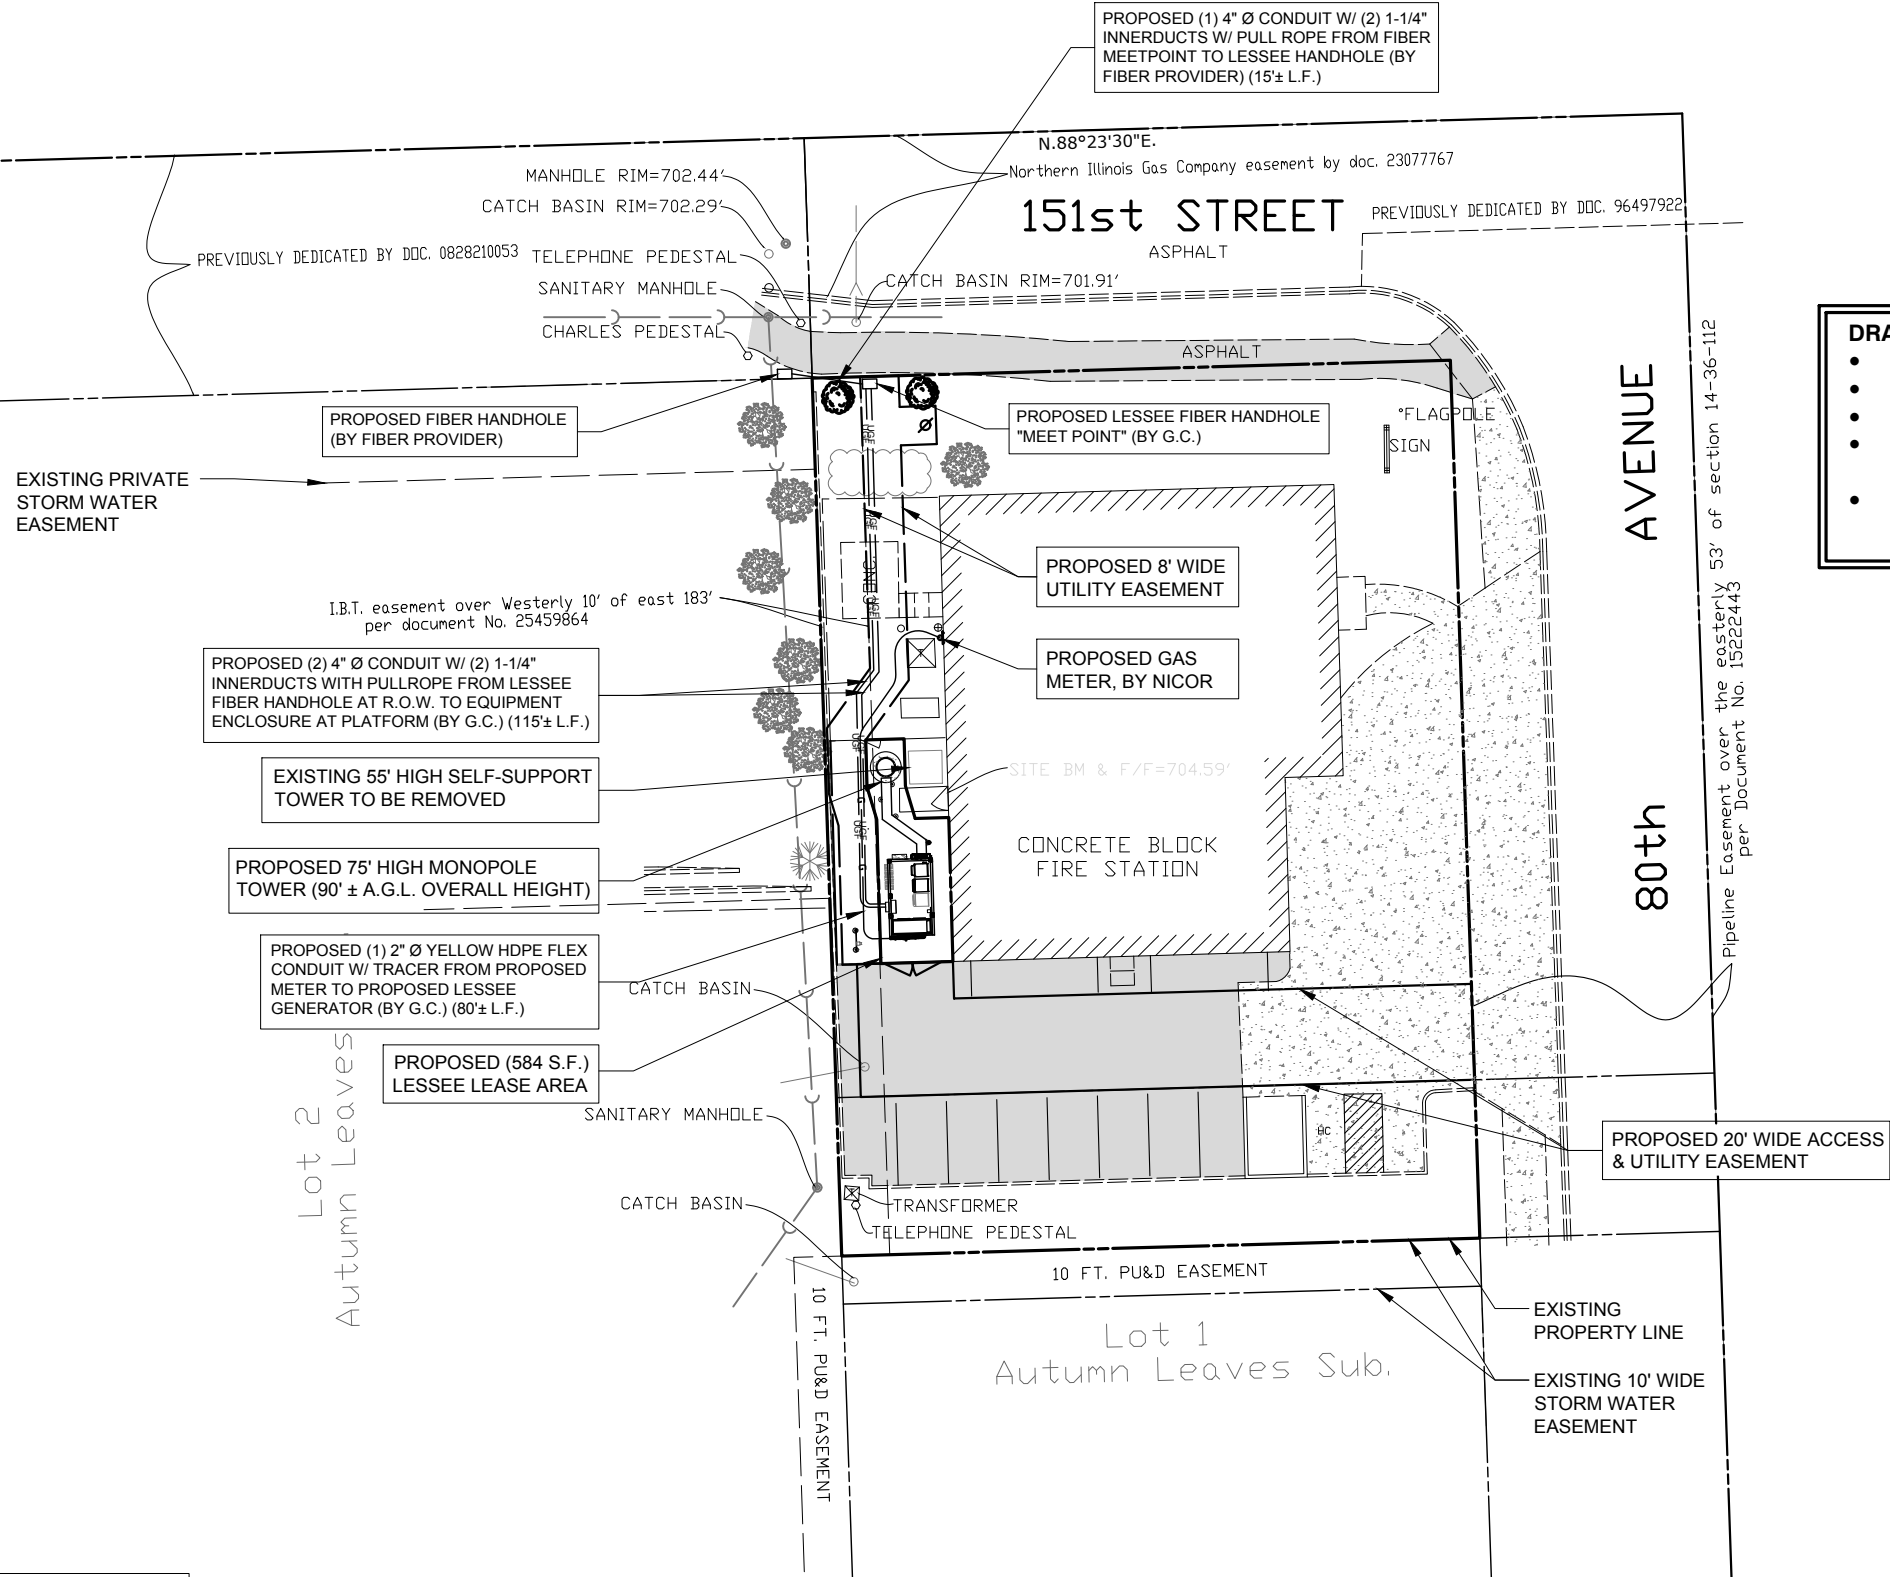

1 LOCATION PLAN
SCALE: 1" = 20'

CONTRACTOR IS RESPONSIBLE FOR ANY DAMAGE TO EXISTING PAVEMENT. CONTRACTOR SHALL PHOTOGRAPH AND VIDEOTAPE EXISTING PAVEMENT PRIOR TO CONSTRUCTION. ANY DAMAGE CAUSED DURING CONSTRUCTION SHALL BE REPLACED TO EXISTING OR BETTER CONDITION AT NO ADDITIONAL COST.

THE CONTRACTOR WILL, UPON BECOMING AWARE OF SUBSURFACE OR LATENT PHYSICAL CONDITIONS DIFFERING FROM THOSE DISCLOSED BY THE ORIGINAL SOIL INVESTIGATION WORK, PROMPTLY NOTIFY THE OWNER VERBALLY AND IN WRITING, AS TO THE NATURE OF THE DIFFERING CONDITIONS. NO CLAIM BY THE CONTRACTOR FOR ANY CONDITIONS DIFFERING FROM THOSE ANTICIPATED IN THE PLANS AND SPECIFICATIONS AND DISCLOSED BY THE SOIL STUDIES WILL BE ALLOWED UNLESS THE CONTRACTOR HAS SO NOTIFIED THE OWNER, VERBALLY AND IN WRITING, AS REQUIRED ABOVE, OF SUCH DIFFERING SUBSURFACE CONDITIONS.

CONTRACTOR TO PROVIDE APPROXIMATE 50'x50' STAGING AREA AND TEMPORARY ROAD. CONTRACTOR SHALL COORDINATE WITH ANTENNA CONTRACTOR, A STAGING AREA AND TEMPORARY ROAD THAT IS ACCEPTABLE TO THE OWNER. STAGING AREA AND TEMPORARY ROAD SHALL BE RESTORED TO EXISTING CONDITIONS AS NECESSARY UPON COMPLETION OF THE PROJECT.

BEFORE AND DURING CONSTRUCTION, THE CONTRACTOR SHALL PROVIDE ADEQUATE EROSION CONTROL AS NECESSARY IN THE FORM OF SILT FENCES FOR THE SITE AND BALES AROUND ANY EXISTING MANHOLES, INLETS, OR CATCHBASINS SUSCEPTIBLE TO EROSION. EROSION CONTROL MEASURES SHALL BE PERIODICALLY INSPECTED TO ENSURE PROPER FUNCTION. EROSION CONTROL SHALL BE REMOVED UPON COMPLETION OF WORK.

- DRA PROPERTIES LLC TO INSTALL:**
- TOWER, TOWER FOUNDATION & TOWER GROUND
 - FENCE & GATE
 - H-FRAME AND GROUNDING
 - ELECTRIC CONDUITS AND CONDUCTOR FROM METER TO COMED DEMARC
 - FIBER CONDUITS WITH PULL ROPE FROM FIBER HANDHOLE IN THE R.O.W. TO THE COMPOUND

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9	REVISED LANDSCAPE PLAN PER VILLAGE	04/05/18	DMS	JTM	

LOC. # 311466

W 151ST
& S 80TH

15100 S 80TH AVE
ORLAND PARK, IL 60462

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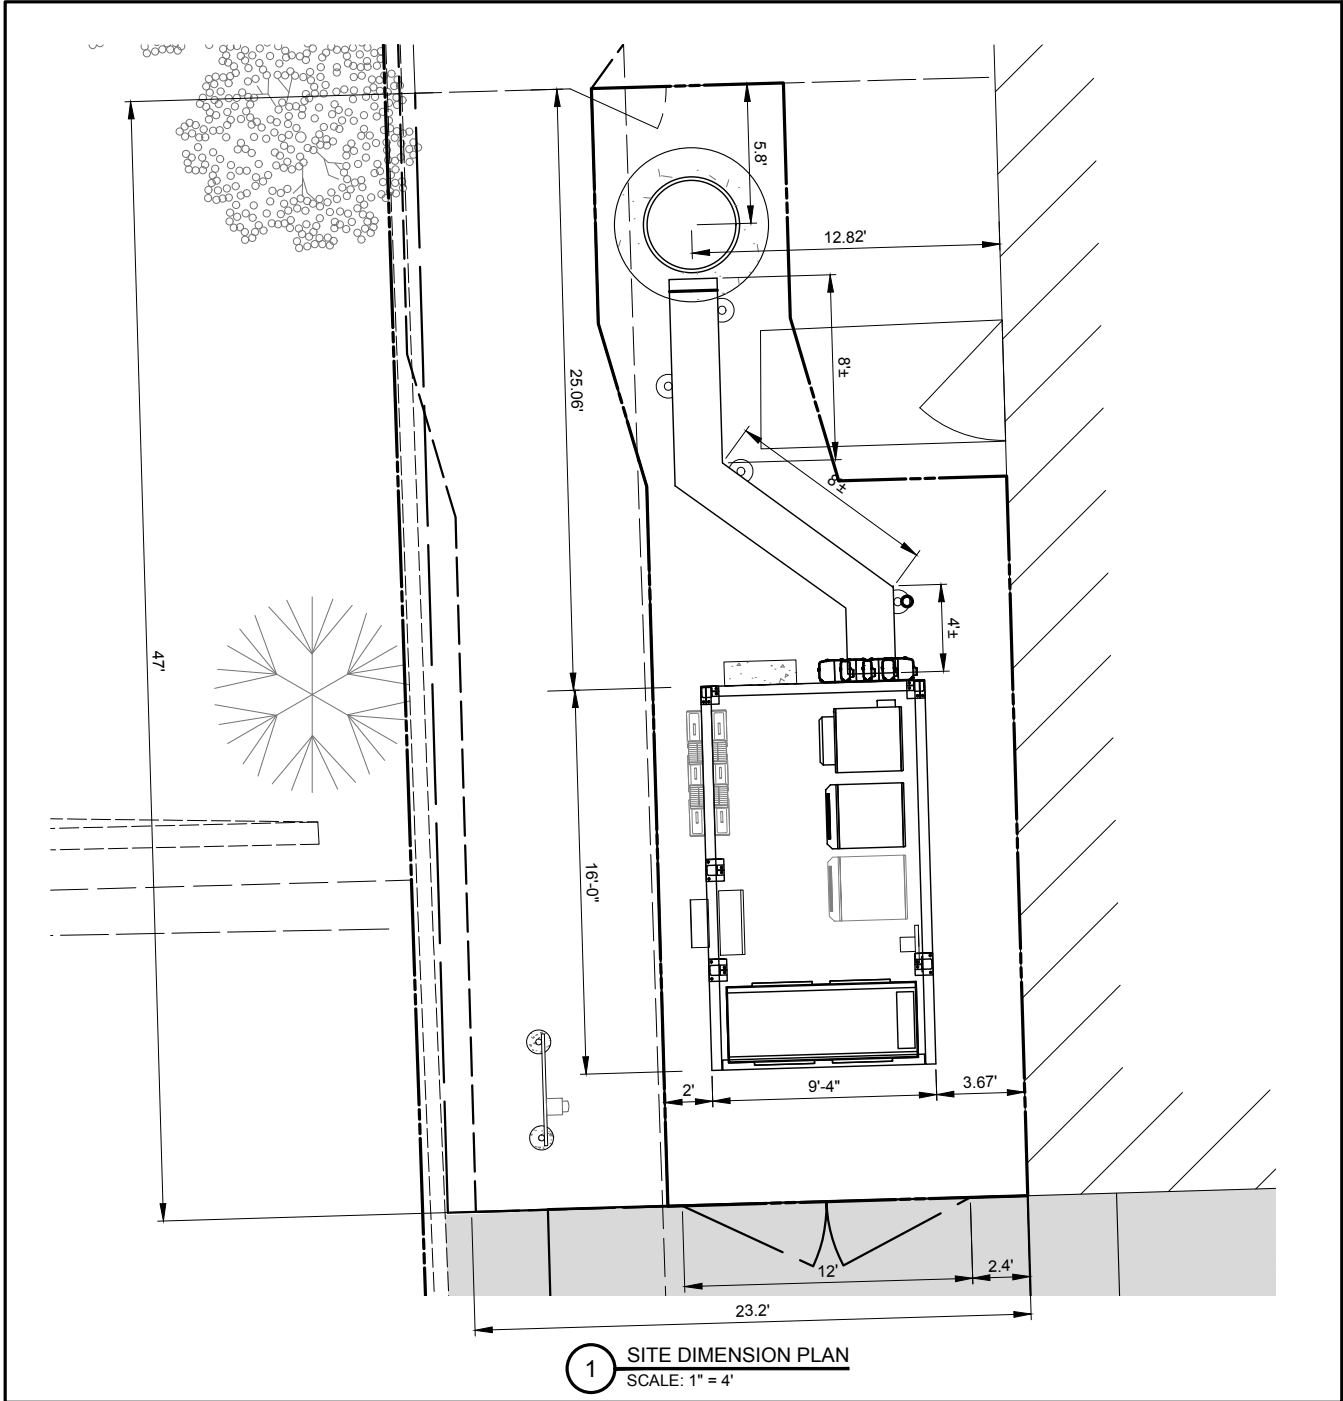
SHEET TITLE
LOCATION PLAN

SHEET NUMBER

LP

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1 SITE DIMENSION PLAN
SCALE: 1" = 4'


PAVEMENT MATERIAL

LEASE SITE
50 S.Y.
8" COMPACTED AGGREGATE BASE COURSE, WITH 3/4" CRUSHED AGGREGATE, NO FINES, OR APPROVED EQUAL. MIRAFI 500X SUBGRADE GEOTEXTILE FABRIC OR APPROVED EQUAL
71 L.F. OF FENCING

THE CONTRACTOR SHALL INCLUDE AS PART OF THE BID, THE COST OF REMOVAL OF ANY SURFACE VEGETATION AND ORGANIC SOILS OR OTHER DELETERIOUS MATERIALS AND THE REPLACEMENT WITH ENGINEERED BACKFILL FOR THE AGGREGATE ACCESS DRIVE AND LEASE SITE, IN ACCORDANCE WITH THE RECOMMENDATIONS OF THE GEOTECHNICAL REPORT.

SURVEY PERFORMED BY:
Advanced Surveying & Mapping
Telephone (630) 273-2500
Fax (630) 273-2600
E-MAIL asmc@advct.com

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 - ELECTRIC CONDUITS AND CONDUCTOR FROM METER TO COMED DEMARC
 - FIBER CONDUITS WITH PULL ROPE FROM FIBER HANDHOLE IN THE R.O.W. TO THE COMPOUND

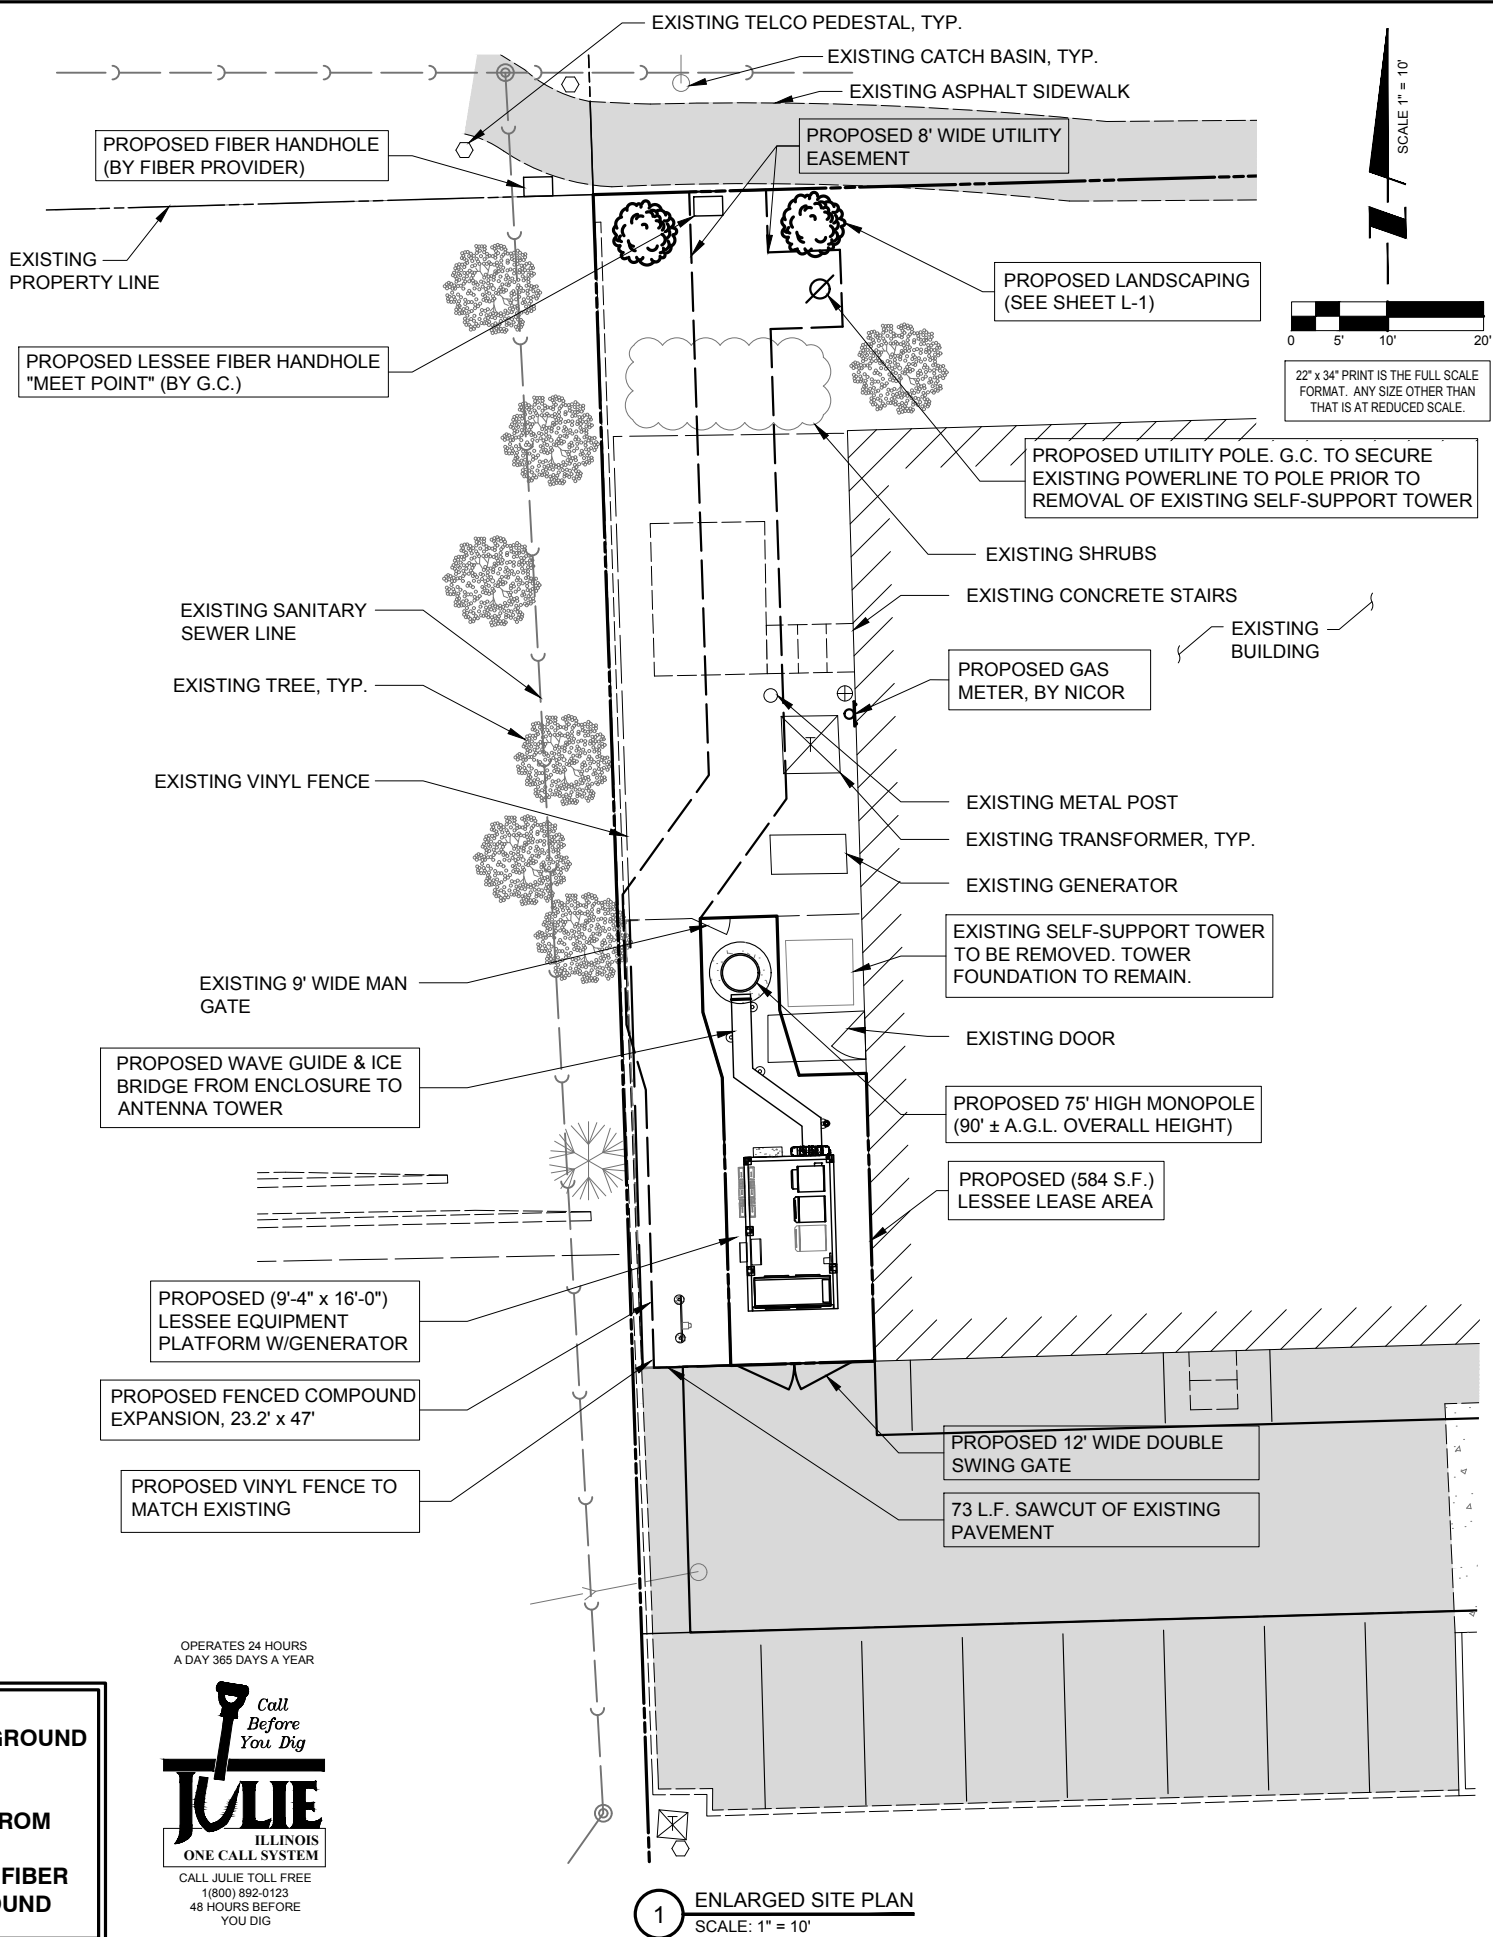

1 ENLARGED SITE PLAN
SCALE: 1" = 10'

OPERATES 24 HOURS
A DAY 365 DAYS A YEAR

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9	REVISED LANDSCAPE PLAN PER VILLAGE

LOC. # 311466



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SHEET TITLE
ENLARGED SITE PLAN

SHEET NUMBER
C-1



.B.T. easement over Westerly 10' of east 183' per document No. 25459864

PROPOSED 75' HIGH MONOPOLE TOWER
-P/GRADE AT TOWER = 704.00
-T/FOUNDATION = 704.80

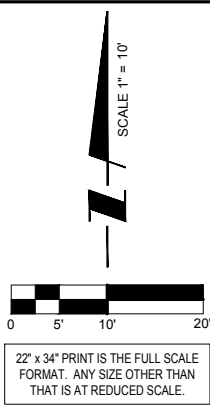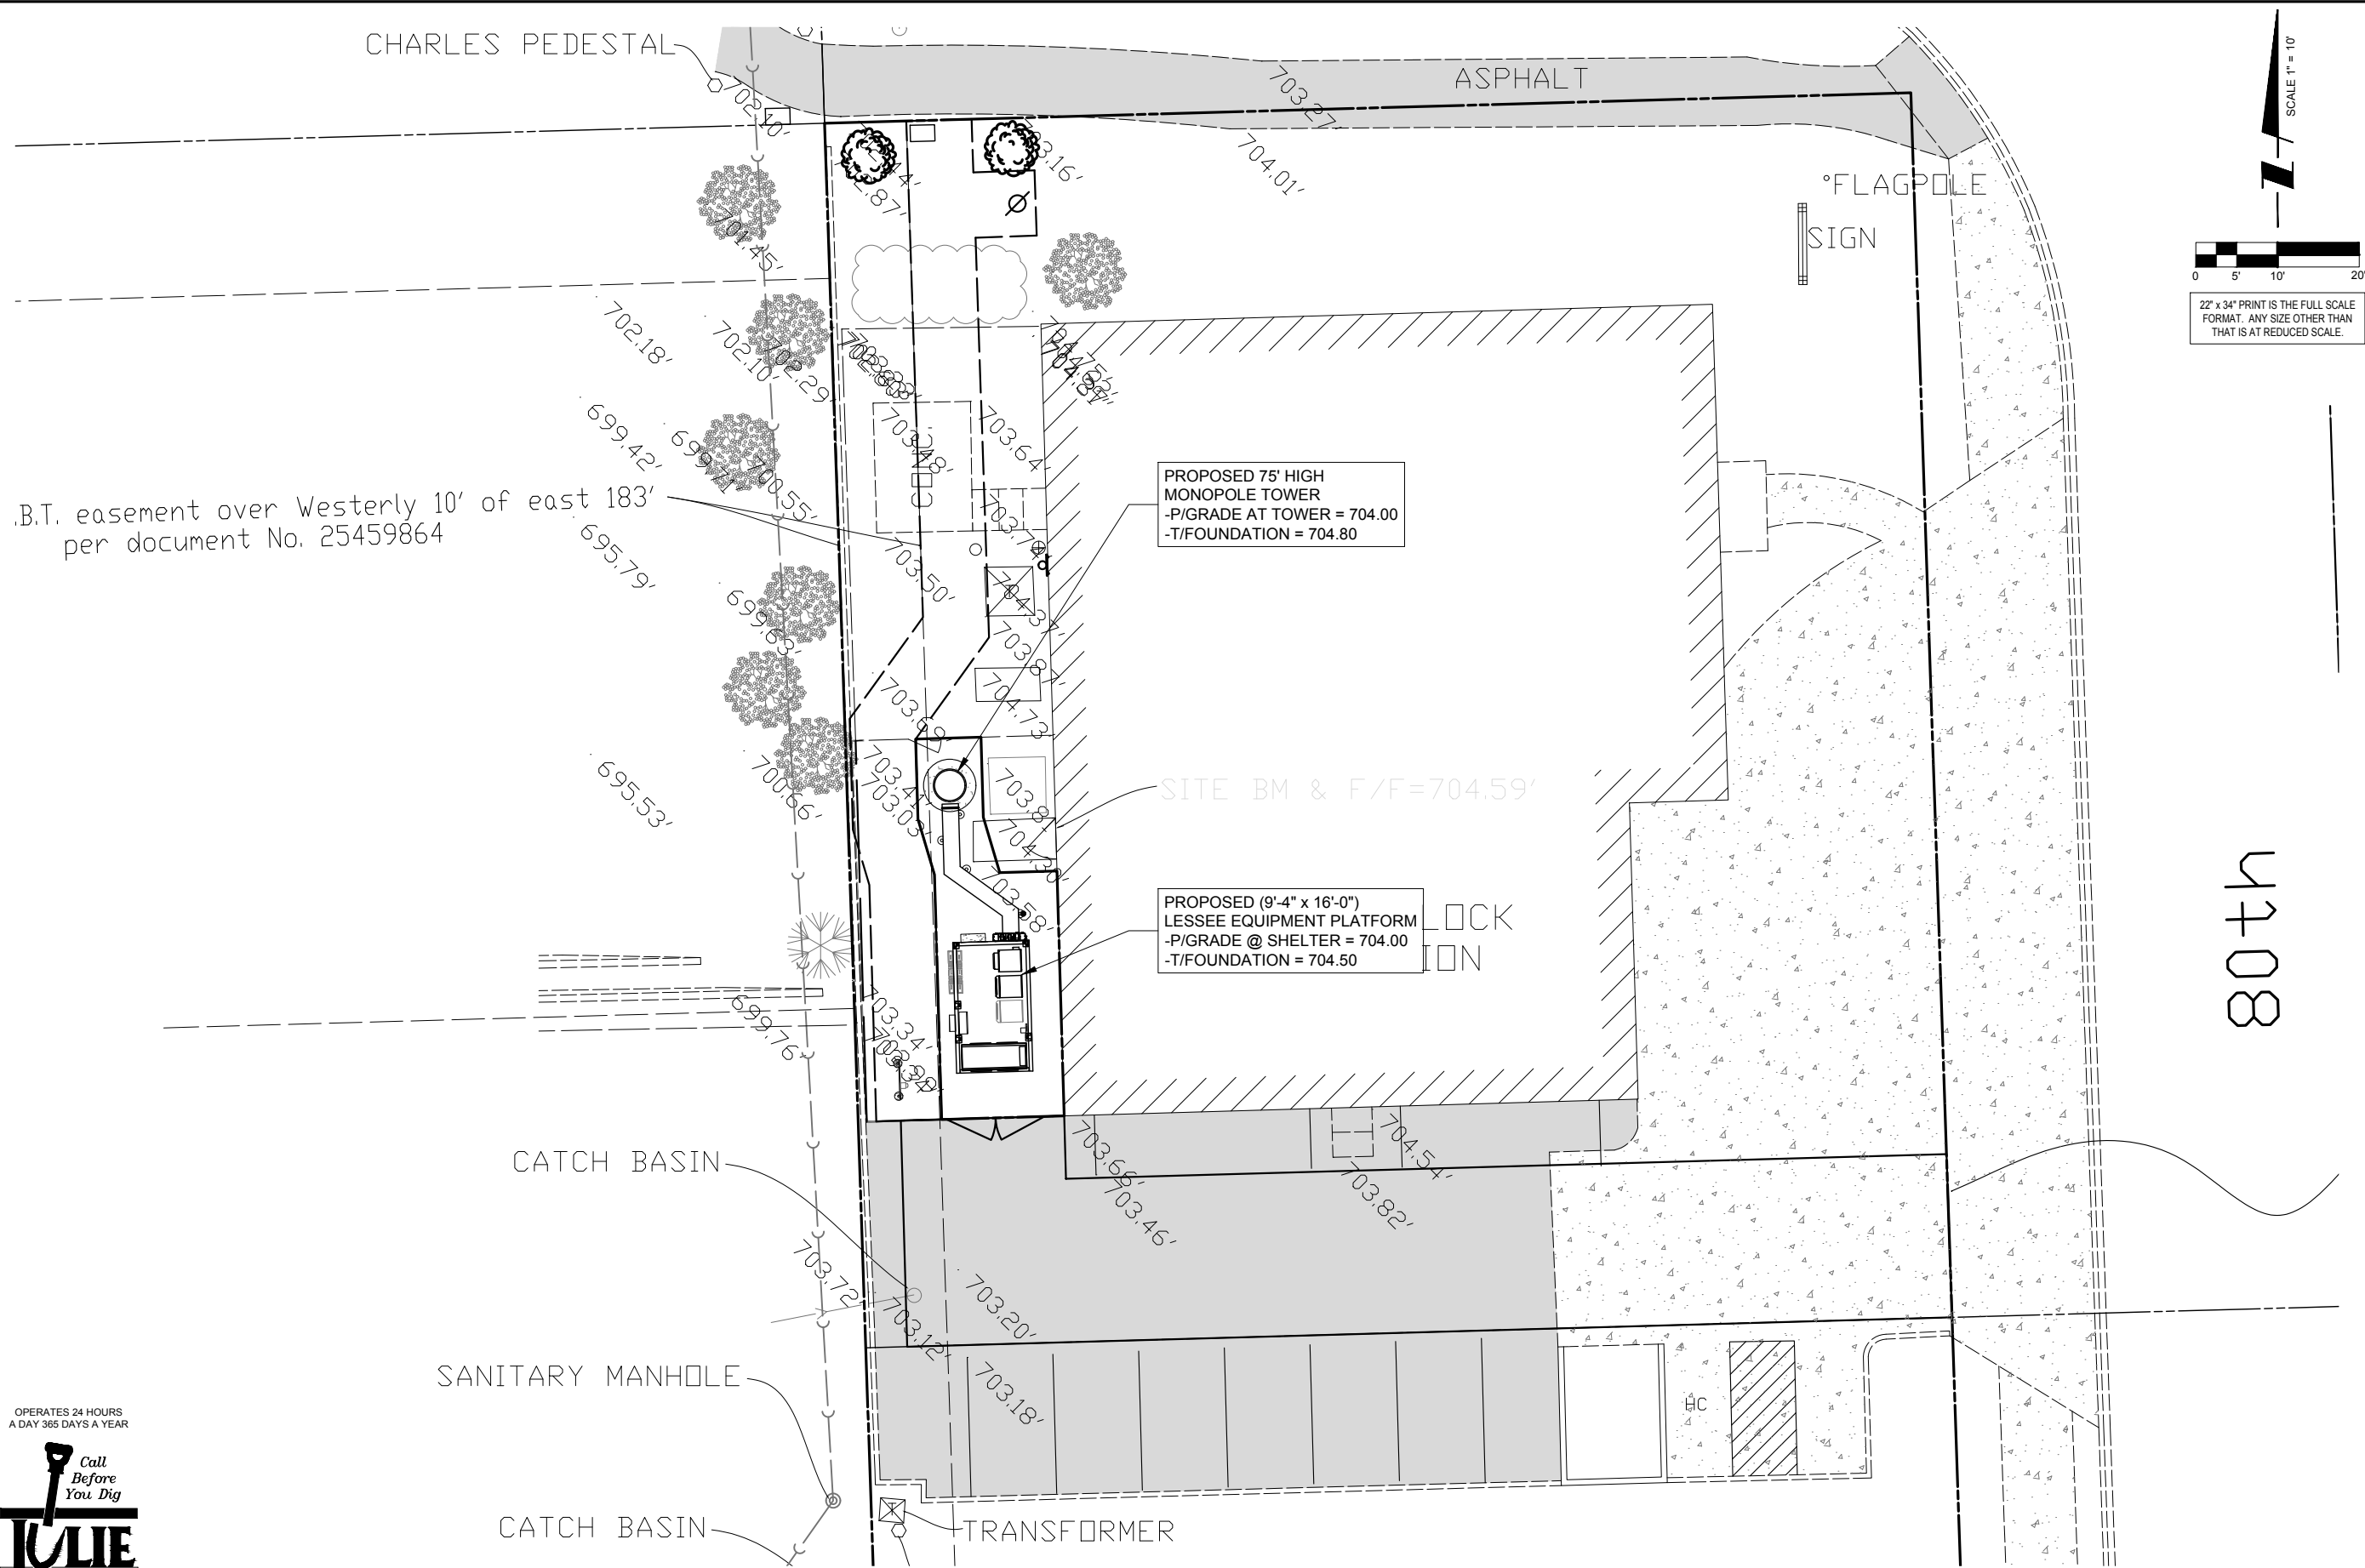PROPOSED (9'-4" x 16'-0") LESSEE EQUIPMENT PLATFORM
-P/GRADE @ SHELTER = 704.00
-T/FOUNDATION = 704.50

SITE BM & F/F=704.59'

OPERATES 24 HOURS
A DAY 365 DAYS A YEAR

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1 SITE GRADING PLAN
SCALE: 1" = 10'

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SHEET TITLE
SITE GRADING PLAN
(SHEET 1 OF 1)

SHEET NUMBER


C-2

Diagram illustrating the cross-section of a vinyl fence assembly, showing components and dimensions:




- 7/8"x6 1/2" VINYL TONGUE & GROVE PICKET (TYP)**: The main vertical picket.
- 2x6 VINYL SLOTTED RAIL (TOP & BOTTOM) (TYP)**: The horizontal rails.
- 5x5 VINYL POST (TYP)**: The vertical post supporting the rails.
- 1" CROWN (TYP)**: The top decorative crown of the picket.
- CAST-IN-PLACE CONCRETE FOUNDATION**: The base for the post.
- FINISHED GRADE**: The ground level.
- 1'-0"Ø CONCRETE FOOTING (TYP)**: The circular concrete base for the post.
- 8'-0" OC (MAX)**: Maximum on-center spacing between posts.
- Dimensions**:
 - Top rail thickness: 2"
 - Picket height above top rail: 8'-0"
 - Post diameter: 1'-0"Ø
 - Concrete footing depth: 3'-6" (TYP)
 - Concrete footing width: 6"
 - Concrete footing height above grade: 3"

Legend:


- 1 PVC POST
- N.T.S.

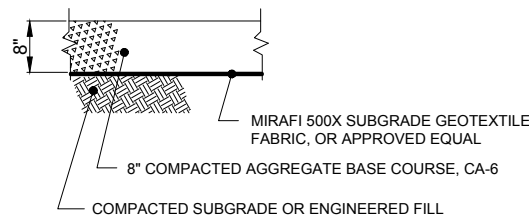

4 AGGREGATE CROSS-SECTION
ACCESS EASEMENT N.T.S.

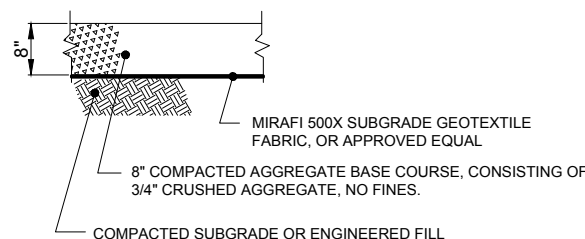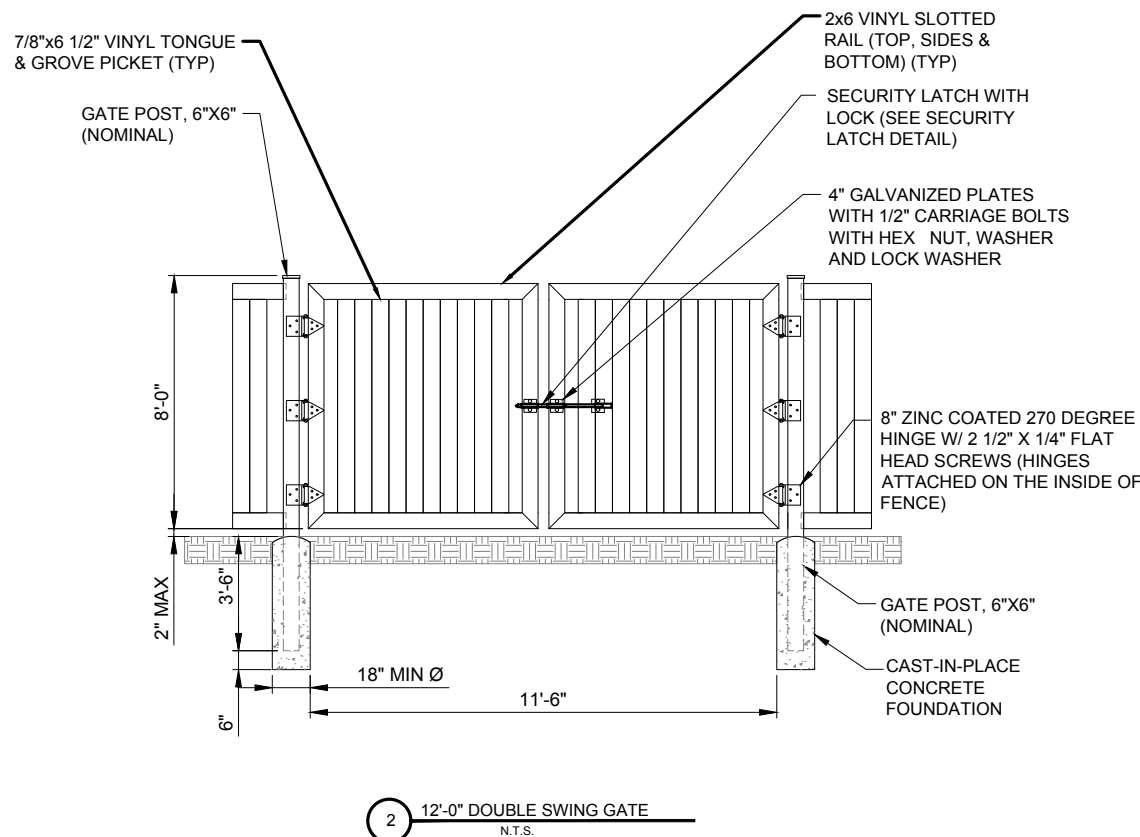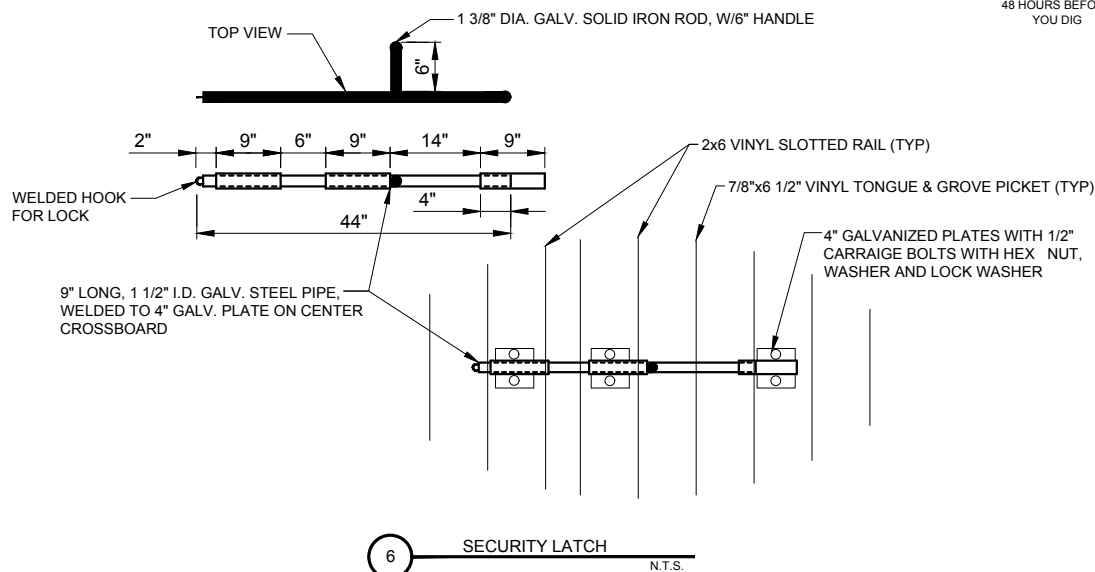

5 AGGREGATE CROSS-SECTION
LEASE SITE N.T.S.

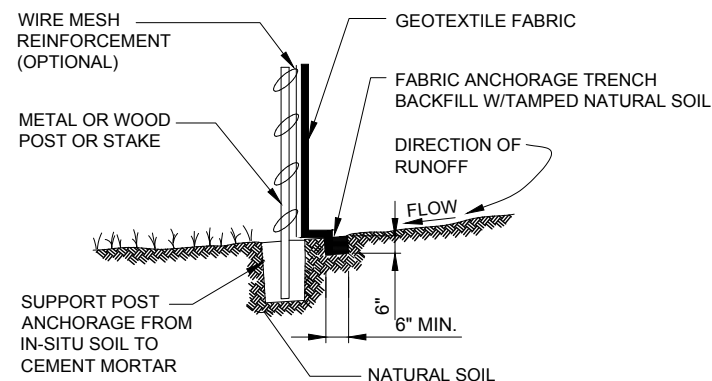

NOTE:
DEPENDING UPON CONFIGURATION, ATTACH
FABRIC TO WIRE MESH W/HOG RINGS, STEEL
POSTS W/ TIE WIRES, WOOD POSTS W/ NAILS.

7 EROSION CONTROL SILT FENCE DETAIL
N.T.S.

7/8"x6 1/2" VINYL TONGUE & GROVE PICKET (TYP)

PVC CORNER POST 6"x6" (NOMINAL)

2x6 VINYL SLOTTED RAIL (TOP & BOTTOM) (TYP)

8'-0"

8'-0"

2" MAX

CAST-IN-PLACE CONCRETE FOUNDATION

3'-6"

6"

18" MIN Ø

3 CORNER POST

N.T.S.

- 1) REFER TO THE PROJECT MANUAL FOR ADDITIONAL INFORMATION AND REQUIREMENTS RELATED TO CONSTRUCTION.
- 2) THE OWNER HAS CAUSED A GEOTECHNICAL EXPLORATION TO BE PERFORMED AT THE SITE.
- 3) THE CONTRACTOR SHALL NOTIFY THE CLIENT'S GEOTECHNICAL ENGINEER TO COORDINATE HAVING A FIELD REPRESENTATIVE ON SITE FOR TESTING AND INSPECTION.

GEOTEXTILE PARAMETERS		
PROPERTY	MINIMUM VALUE (a)	TEST METHOD
GRAB STRENGTH	180 LBS.	ASTM D-4632-91
PUNCTURE STRENGTH	75 LBS.	ASTM D-4833-88
BURST STRENGTH	290 LBS.	ASTM D-3786
TRAPEZOIDAL TEAR	50 LBS.	ASTM D-4571-87
(a) ALL VALUES REPRESENT MINIMUM ROLL VALUES		

NOTES:
THE FABRIC SHOULD BE PLACED IN ACCORDANCE WITH THE MANUFACTURERS RECOMMENDATIONS. INTERSECTIONS OF SHEETS MUST BE SEWN OR SUFFICIENTLY OVERLAPPED (AT LEAST 24 INCHES) OR AS SPECIFIED BY THE MANUFACTURER. THE GEOTEXTILE SHEETS SHOULD ALSO BE PLACED TAUT TO REDUCE WRINKLES OR FOLDS. CARE MUST BE EXERCISED TO PREVENT PHYSICAL DAMAGE OF THE GEOTEXTILE PRIOR TO, DURING AND AFTER INSTALLATION. UTILITIES SHOULD BE INSTALLED BEFORE PLACING THE FABRIC.



TERRA
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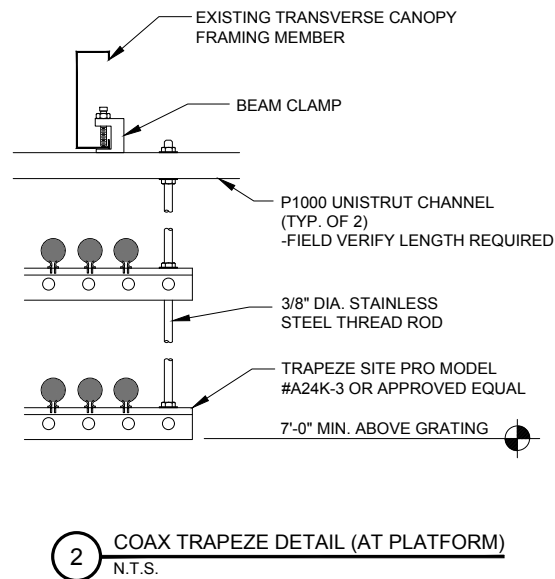
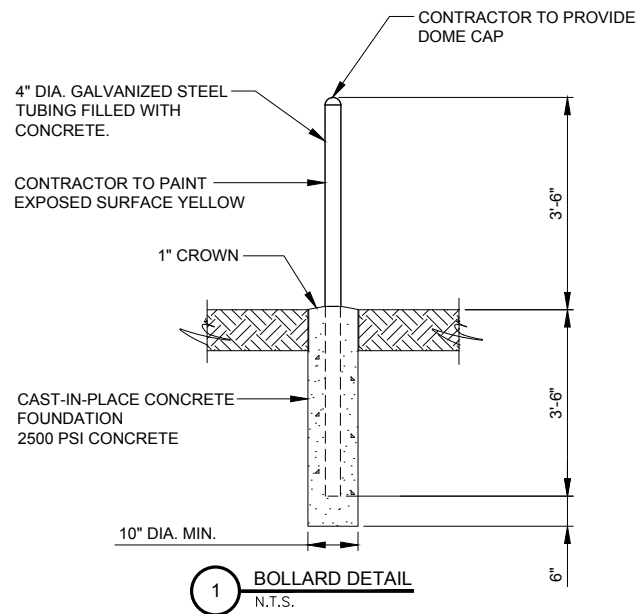
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SHEET TITLE

SHEET NUMBER

C-3



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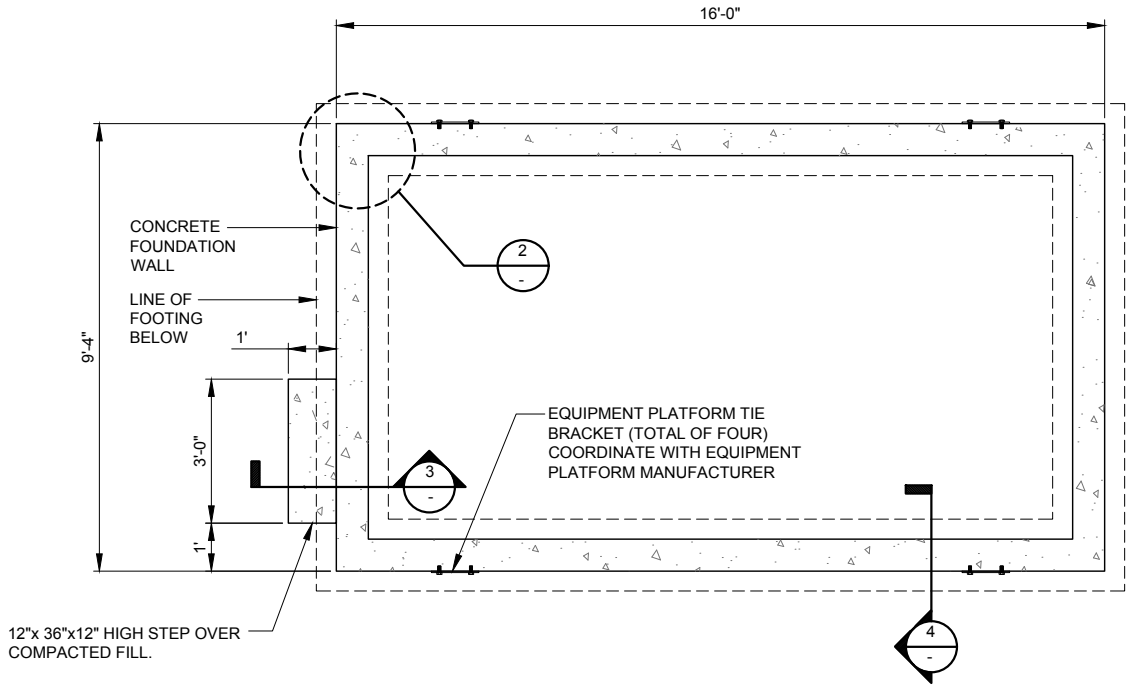
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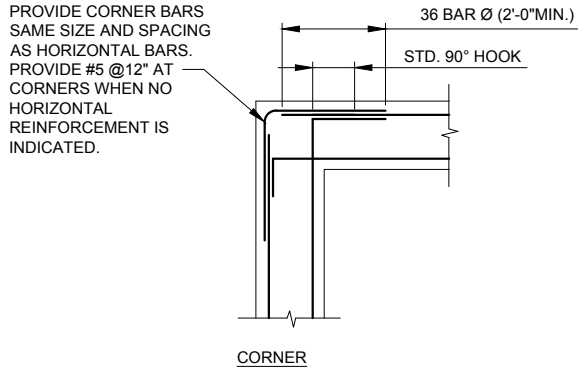
SHEET TITLE
SITE DETAILS

SHEET NUMBER


C-4




1 EQUIPMENT ENCLOSURE FOUNDATION PLAN
N.T.S.



2 CONCRETE WALL REINFORCEMENT DETAILS
N.T.S.

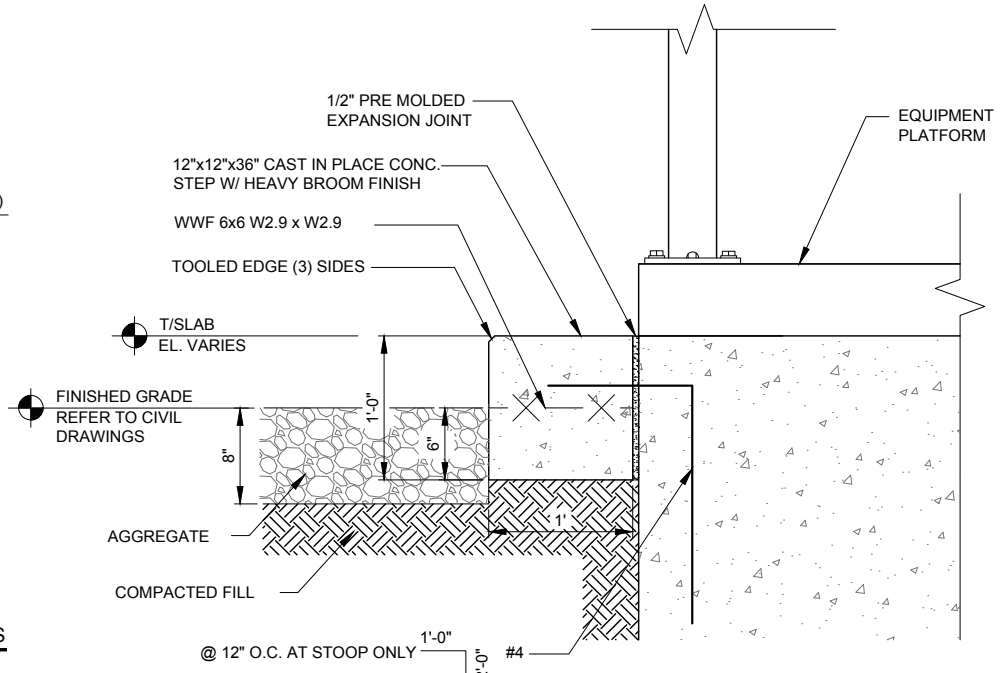


3 STEP DETAIL
N.T.S.

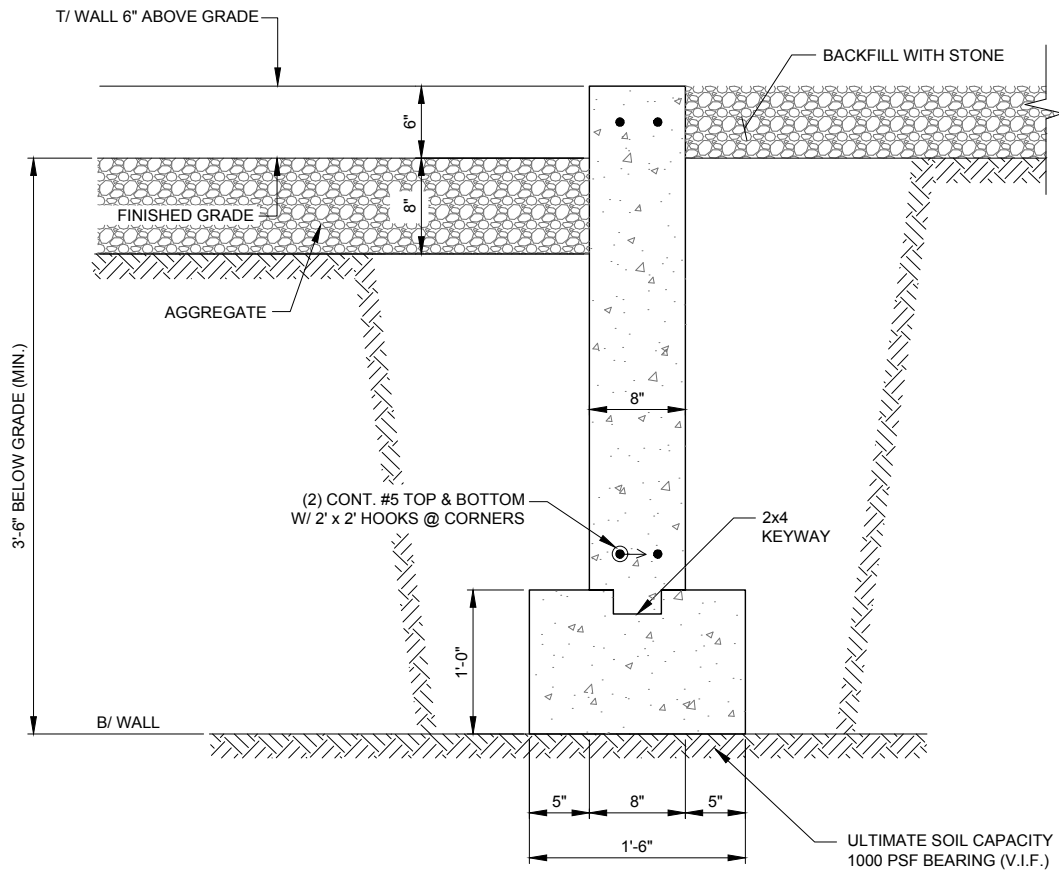

4 FOUNDATION WALL SECTION
SCALE: N.T.S.

NOTE:
LOCALIZED AREAS OF SOFT OR LOOSE MATERIALS MAY BE ENCOUNTERED AT THE PROPOSED BEARING ELEVATION. THE SOILS MAY REQUIRE COMPACTION USING A PLATE COMPACTOR IN THE FOOTING TRENCH IF FIELD CONDITIONS INDICATE LOOSE GRANULAR SOILS. THE SOILS MAY REQUIRE REMOVAL AND REPLACEMENT WITH AN APPROVED ENGINEERED FILL. FOUNDATION DEPTH AND OVER DIG REQUIREMENTS SHALL BE VERIFIED WITH THE RECOMMENDATIONS OF THE GEOTECHNICAL REPORT AND INCLUDED IN THE BID BEFORE CONSTRUCTION. THE EVALUATION OF THE SUB GRADE AND SELECTION OF FILL MATERIALS SHALL BE MONITORED AND TESTED BY A QUALIFIED REPRESENTATIVE OF THE SOILS ENGINEER.

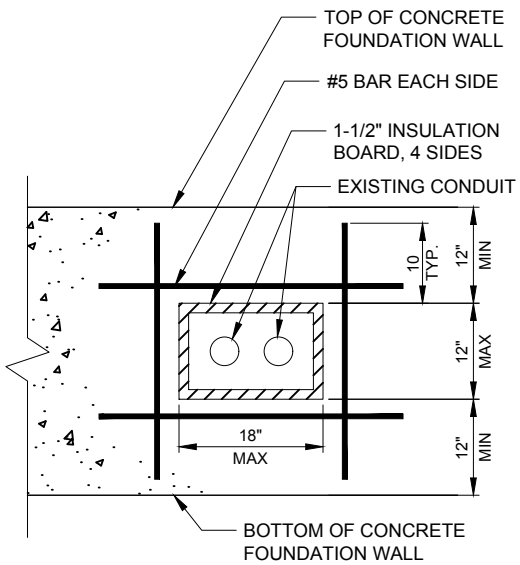

5 SLEEVE DETAIL (IF APPLICABLE)
N.T.S.

A. EQUIPMENT PLATFORM FOUNDATION

- REFER TO CIVIL DRAWINGS FOR ORIENTATION OF THE FOUNDATIONS.
- EQUIPMENT ENCLOSURE FOUNDATION IS DESIGNED FOR THE FOLLOWING LOADS:
ROOF LIVE LOAD: 81 PSF
FLOOR LIVE LOAD: 986 PSF
- THE CONTRACTOR SHALL NOTIFY THE CLIENT'S GEOTECHNICAL ENGINEER TO COORDINATE HAVING A FIELD REPRESENTATIVE ON SITE FOR TESTING AND INSPECTION.
- FOOTINGS SHALL BEAR ON VIRGIN SOIL OR COMPACTED FILL MATERIAL CAPABLE OF SUPPORTING A MINIMUM SOIL BEARING PRESSURE OF 1000 PSF MINIMUM.
- SUBGRADE PREPARATION:
 - REMOVE ALL SOILS CONTAINING TOPSOIL: ORGANIC MATERIALS, AND/OR FILL MATERIALS FROM WITHIN AREA OF ENCLOSURE FOUNDATION.
 - PROOF ROLL RESULTING SUBGRADE WITH A HEAVILY LOADED SINGLE AXLE ROLLER OR SIMILAR VEHICLE. (20 TON LOAD). CONTRACTOR SHALL UNDERCUT AND REPLACE WITH ENGINEERED FILL. ALL LOOSE SOFT OR UNSTABLE AREAS REVEALED DURING PROOFROLLING AS DIRECTED BY THE TESTING AGENCY. CONTRACTOR SHALL INCLUDE ANTICIPATED UNDERCUT AND REPLACEMENT AS INDICATED IN THE GEOTECHNICAL REPORT AS PART OF THE BID.
 - BACKFILL AND COMPACT THE AREA WITHIN THE PLATFORM FOUNDATION. BETWEEN RESULTANT SUBGRADE AND FOUNDATION WALL WITH APPROVED GRANULAR MATERIAL.
- FOUNDATION WALLS SHALL BE BACKFILLED EVENLY ON EACH SIDE OF THE WALL OR WALLS SHALL BE ADEQUATELY BRACED BY THE CONTRACTOR UNTIL FOUNDATION WALL HAS BEEN PLACED AND CURED FOR 72 HOURS MINIMUM.
- PLATFORM SHALL NOT BE SET UNTIL FOUNDATION WALL HAS BEEN CURED FOR 72 HOURS MINIMUM.
- CONTRACTOR TO ENSURE FOUNDATION WALL ARE POURED TO MEET FLATNESS LEVEL TOLERANCES AS INDICATED IN ACI 4.5.6 AND 4.5.7.

B. EQUIPMENT PLATFORM

THE EQUIPMENT PLATFORM IS A PRE-FABRICATED PLATFORM MANUFACTURED BY SABRE INDUSTRIES, BOSSIER CITY, LA 71111
THE EQUIPMENT PLATFORM SHALL BE FURNISHED AND INSTALLED BY THE OWNER UNDER SEPARATE CONTRACT PER THE OWNER AND MANUFACTURER SPECIFICATIONS.

C. CONCRETE NOTES

- ALL CONCRETE WORK SHALL CONFORM TO THE REQUIREMENTS OF ACI 318 AND ACI 301, LATEST EDITION. THESE DOCUMENTS SHALL BE AVAILABLE IN THE FIELD OFFICE.
- EXCEPT WHERE OTHERWISE INDICATED, CONCRETE SHALL BE NORMAL WEIGHT AND WITH MINIMUM 28-DAY COMPRESSIVE STRENGTHS OF $F'_c=4000$ PSI. ALL EXTERIOR EXPOSED CONCRETE SHALL BE AIR ENTRAINED WITH 6% AIR CONENT.
- REINFORCING BARS SHALL CONFORM TO ASTM A615, GRADE 60. ALL WELDED WIRE FABRIC SHALL CONFORM TO ASTM A185.
- UNLESS NOTED OTHERWISE, ALL SLABS-ON GRADE SHALL BE REINFORCED WITH ONE (1) LAYER OF 6X6 W2.1XW2.1 W.W.F.

CHICAGO
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d/b/a VERIZON WIRELESS



NO.		DESCRIPTION	DATE	BY
3		FINAL PENDING FIBER	08/21/17	DMS
4		UPDATE WITH NEW ECR	08/31/17	JTM
5		UPDATE WITH NEW LAYOUT	09/08/17	DMS
6		FINALS WITH FINER	10/20/17	RA
7		ADDITION OF LANDSCAPING PLAN	12/29/17	JTM
8		UPDATE PER GAS COORDINATION	01/31/18	DMS
9		REVISED LANDSCAPE PLAN PER VILLAGE	04/05/18	JTM

LOC. # 311466

W 151ST
& S 80TH

15100 S 80TH AVE
ORLAND PARK, IL 60462

DRAWN BY:	PP
CHECKED BY:	TAZ
DATE:	07/23/15
PROJECT #:	33-1466


SHEET TITLE
PLATFORM
FOUNDATION PLAN

SHEET NUMBER


C-5

OPERATES 24 HOURS
A DAY 365 DAYS A YEAR



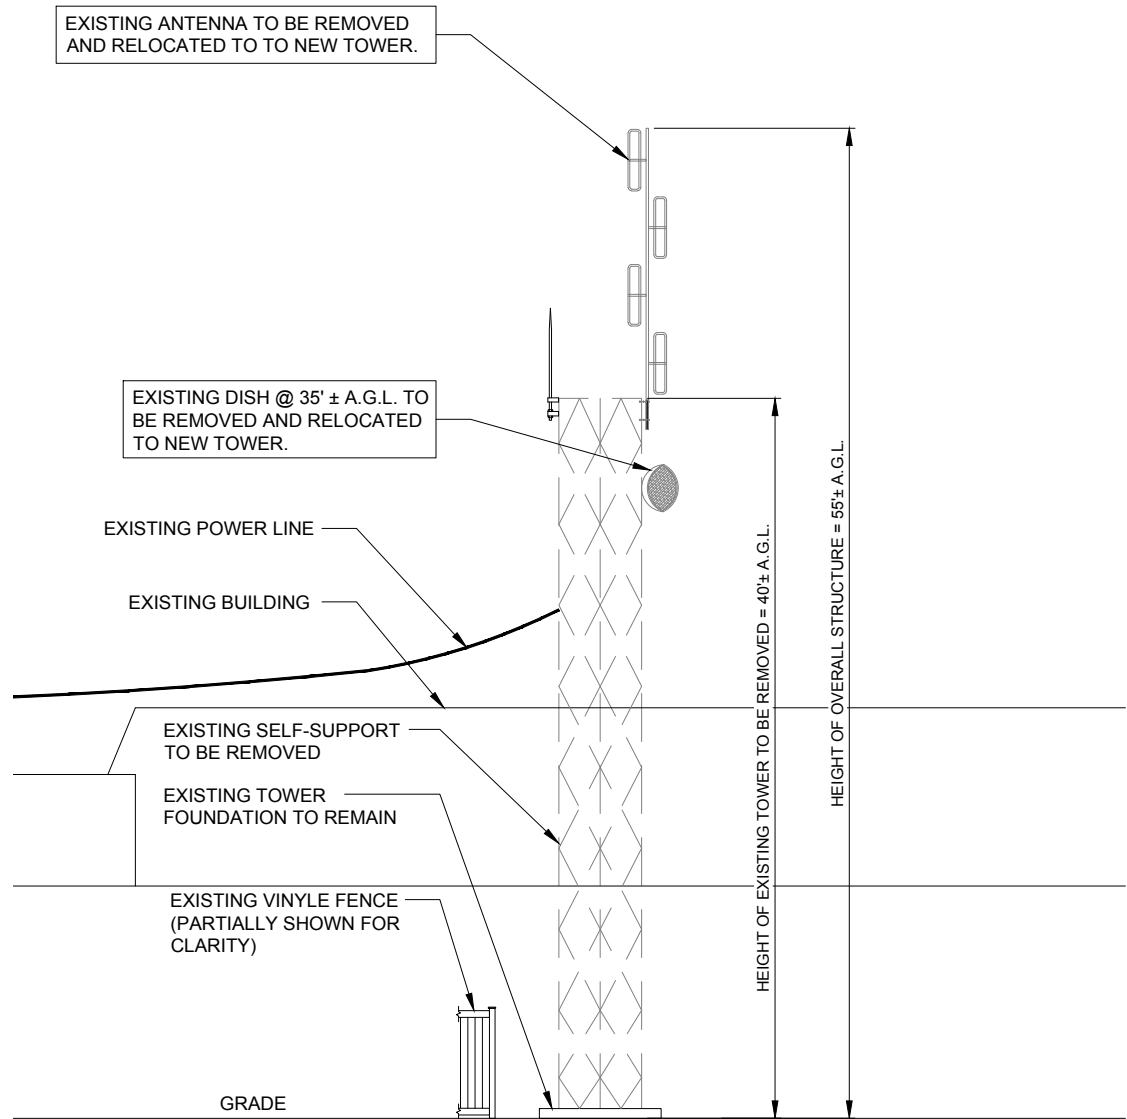

1 EXISTING SITE ELEVATION
SCALE: 3/16" = 1'-0"

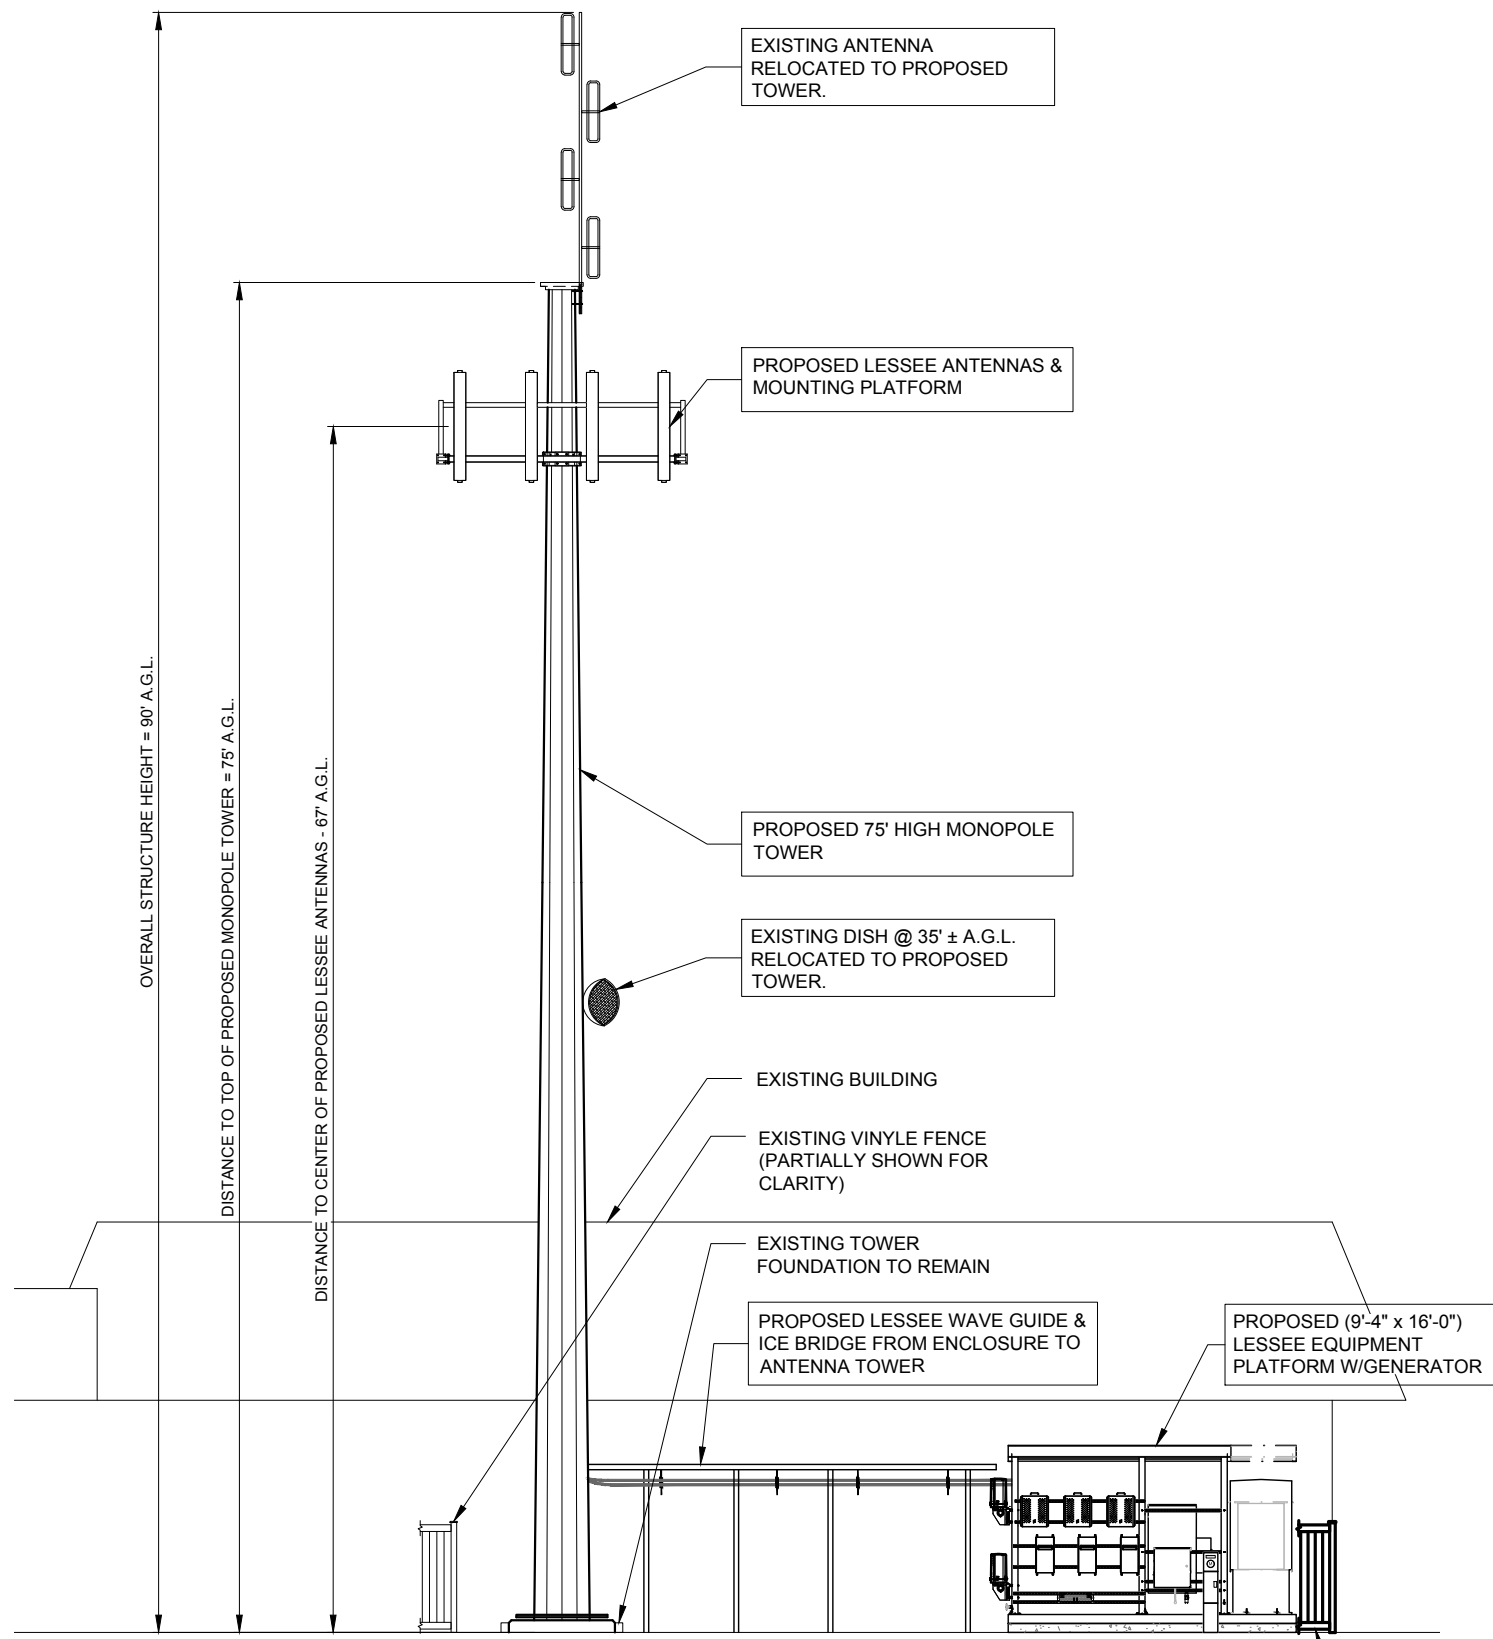

1 PROPOSED SITE ELEVATION
SCALE: 3/16" = 1'-0"

0 1/2" 1" 2"
SCALE: 3/16" = 1'
24" x 36" PRINT IS THE FULL SCALE
FORMAT. ANY SIZE OTHER THAN
THAT IS AT REDUCED SCALE.

CHICAGO
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TERRA
CONSULTING GROUP, LTD.
600 BUSSE HIGHWAY
PARK RIDGE, IL 60068
PH: 847-898-6400
FAX: 847-898-6401

REVISIONS		NO.	DATE	BY	DESCRIPTION
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		7	12/29/17	JTM	ADDITION OF LANDSCAPING PLAN
		8	01/31/18	DMS	UPDATE PER GAS COORDINATION
		9	04/05/18	JTM	REVISED LANDSCAPE PLAN PER VILLAGE

LOC. # 311466

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DRAWN BY:	PP
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SHEET TITLE
SITE ELEVATION

SHEET NUMBER

ANT-1


EQUIPMENT CHANGE REQUEST FORM- ECR											
Cell Name		151st St & 80th Ave		RF Engineer		Jeremy Litz		Cell ID		15100 S 80th St	
Location Number				Market		HH		Address		Orland Park/IL/60462	
Date of Request		8/31/2017						City/State/Zip			
PROPOSED CONFIGURATION								Configuration		Option-A2	
Antenna				Antenna Manufacturer	Antenna Model	Antenna Serial Number	Centerline	Azimuth	Variable Tilt	Mechanical Tilt	Action
Sector	Pos	Port	RF Path								
Alpha	A1	L1 (-45)	LTE C - RxTx0	CommScope	SBNHH-1D65B		67	25	2	0	Change-Install
		L2 (+45)	LTE C - RxTx1								
		H1 (-45)	AWS - RxTx0						0		
		H2 (+45)	AWS - RxTx1								
	A2	L1 (-45)	Unused at this time								
		L2 (+45)	Unused at this time								
		H1 (-45)	Unused at this time								
		H2 (+45)	Unused at this time								
	A3	L1 (-45)	Unused at this time								
		L2 (+45)	Unused at this time								
		H1 (-45)	Unused at this time								
		H2 (+45)	Unused at this time								
	A4	L1 (-45)	Unused at this time	CommScope	SBNHH-1D65B		67	25	2	0	Change-Install
		L2 (+45)	Unused at this time						0		
		H1 (-45)	PCS Future - RxTx0								
		H2 (+45)	PCS Future - RxTx1								
Beta	B1	L1 (-45)	LTE C - RxTx0	CommScope	SBNHH-1D65B		67	140	4	0	Change-Install
		L2 (+45)	LTE C - RxTx1						1		
		H1 (-45)	AWS - RxTx0								
		H2 (+45)	AWS - RxTx1								
	B2	L1 (-45)	Unused at this time								
		L2 (+45)	Unused at this time								
		H1 (-45)	Unused at this time								
		H2 (+45)	Unused at this time								
	B3	L1 (-45)	Unused at this time								
		L2 (+45)	Unused at this time								
		H1 (-45)	Unused at this time								
		H2 (+45)	Unused at this time								
	B4	L1 (-45)	Unused at this time	CommScope	SBNHH-1D65B		67	140	4	0	Change-Install
		L2 (+45)	Unused at this time						1		
		H1 (-45)	PCS Future - RxTx0								
		H2 (+45)	PCS Future - RxTx1								
GAMMA	G1	L1 (-45)	LTE C - RxTx0	CommScope	SBNHH-1D65B		67	270	4	0	Change-Install
		L2 (+45)	LTE C - RxTx1						1		
		H1 (-45)	AWS - RxTx0								
		H2 (+45)	AWS - RxTx1								
	G2	L1 (-45)	Unused at this time								
		L2 (+45)	Unused at this time								
		H1 (-45)	Unused at this time								
		H2 (+45)	Unused at this time								
	G3	L1 (-45)	Unused at this time								
		L2 (+45)	Unused at this time								
		H1 (-45)	Unused at this time								
		H2 (+45)	Unused at this time								
	G4	L1 (-45)	Unused at this time	CommScope	SBNHH-1D65B		67	270	4	0	Change-Install
		L2 (+45)	Unused at this time						1		
		H1 (-45)	PCS Future - RxTx0								
		H2 (+45)	PCS Future - RxTx1								
Comments											

1 PROPOSED ANTENNA SCHEDULE
N.T.S.

ESTIMATED MAIN LINE HYBRID LENGTH			
ANTENNA CENTERLINE (±)	ICE BRIDGE LENGTH (±)	SHELTER (±)	TOTAL (±)
67'	13'	15'	100'

Proposed						
Passive Components	Location	Manufacturer	Component Model	Count	Action	
	Top (Platform)					
	Bottom (Shelter)					
	Top (Platform)	Ericsson	2212 - AWS	6	Install	
	Top (Platform)	Ericsson	2212 - PCS	6	Install	
	Top (Platform)					
	Top (Platform)	Raycap	RCMDC-3315-PF-48	3	Install	
	Bottom (Shelter)	Raycap	RCMDC-3315-PF-48	3	Install	
	Bottom (Shelter)	CommScope	CBC78T-DS-43	6	Install	
Coax	Sector	Coax Manufacturer	Type	Size	Count	Action
	Alpha	ANDREW		1 5/8	4	Install
	Beta	ANDREW		1 5/8	4	Install
	Gamma	ANDREW		1 5/8	4	Install
			RFF-16SM-808-418-APE			
	AWS	Andrew		1 5/8	3	Install
Comments						

2 COMBINER CABLE DATA INFORMATION
N.T.S.

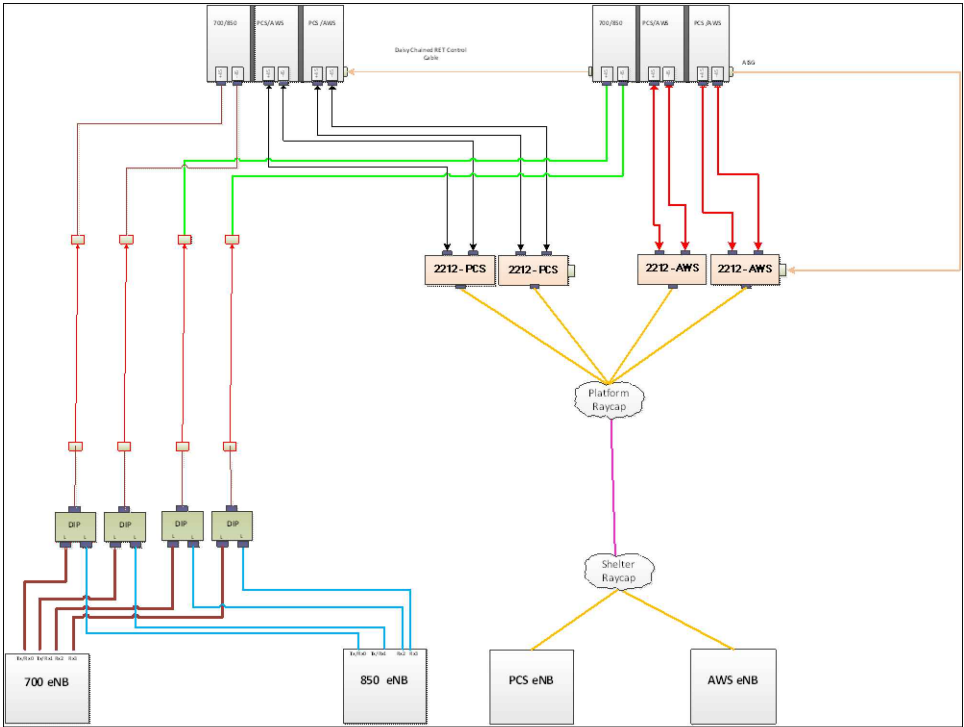

3 CABLE DIAGRAM
N.T.S.

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LOC. # 311466

W 151ST
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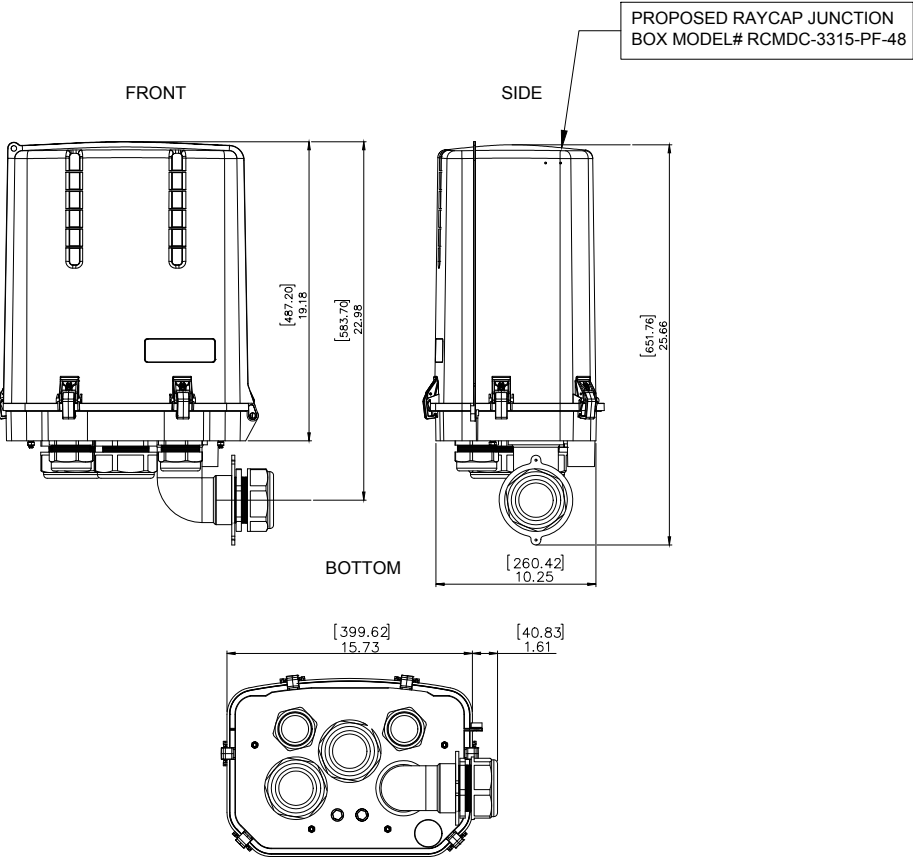
DRAWN BY:	PP
CHECKED BY:	TAZ
DATE:	07/23/15
PROJECT #:	33-1466

SHEET TITLE
ANTENNA INFORMATION

SHEET NUMBER
ANT-2


SPECIFICATIONS DC SURGE PROTECTION FOR RRU/INTEGRATED ANTENNA RADIO HEAD
APPLICATION: TOWER / BASE / ROOFTOP / ROOFTOP DISTRIBUTION MODELS
WEIGHT: 32LBS (14.51 KG)

[mm]
INCHES




1 RAYCAP JUNCTION BOX DETAIL
SCALE: N.T.S.


NOTE: EACH SECTOR BAR TO HAVE TO HAVE
SEPARATE GROUND LEAD TO COLLAR MOUNT

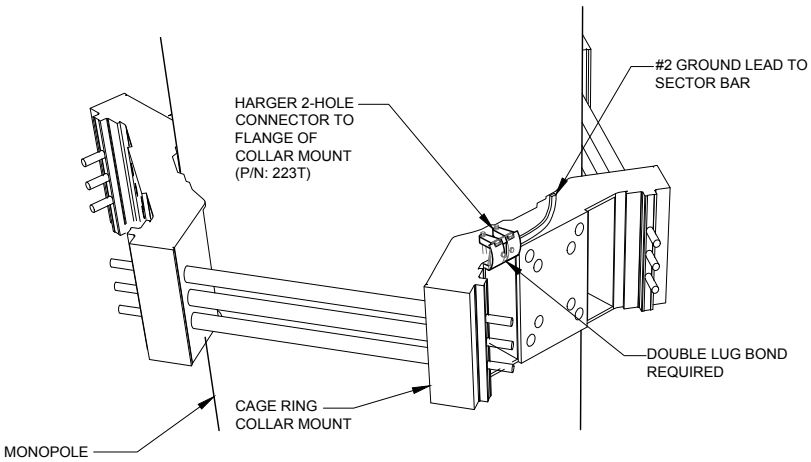


2 MONOPOLE GROUND AT ANTENNA LEVEL
SCALE: N.T.S.

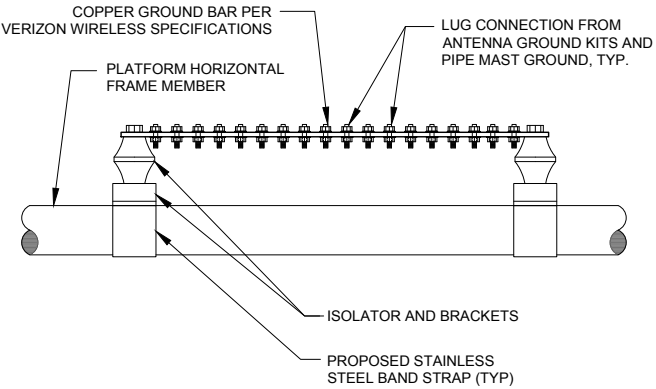


3 GROUND BAR AT SECTOR
N.T.S.

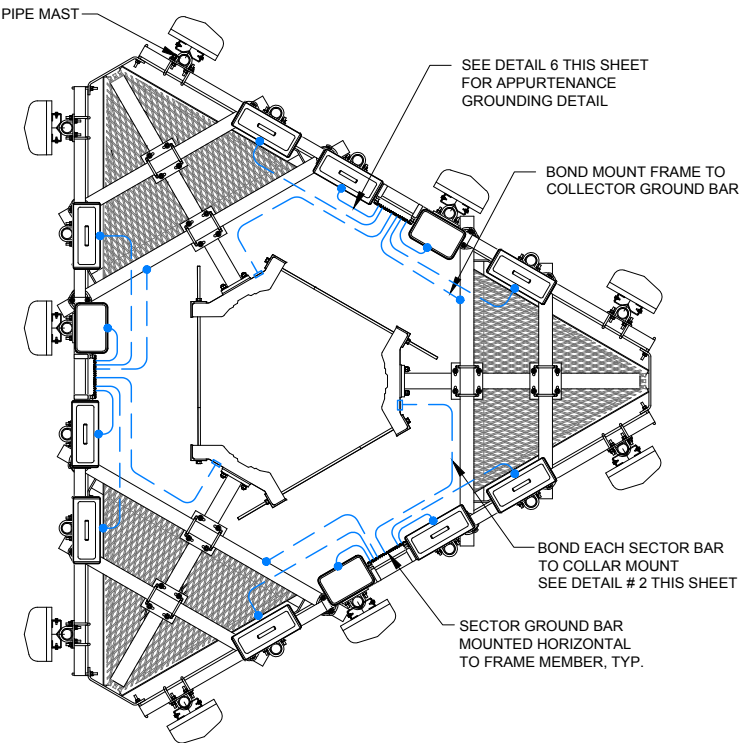

4 EQUIPMENT GROUNDING AT ANTENNA ELEVATION
N.T.S.

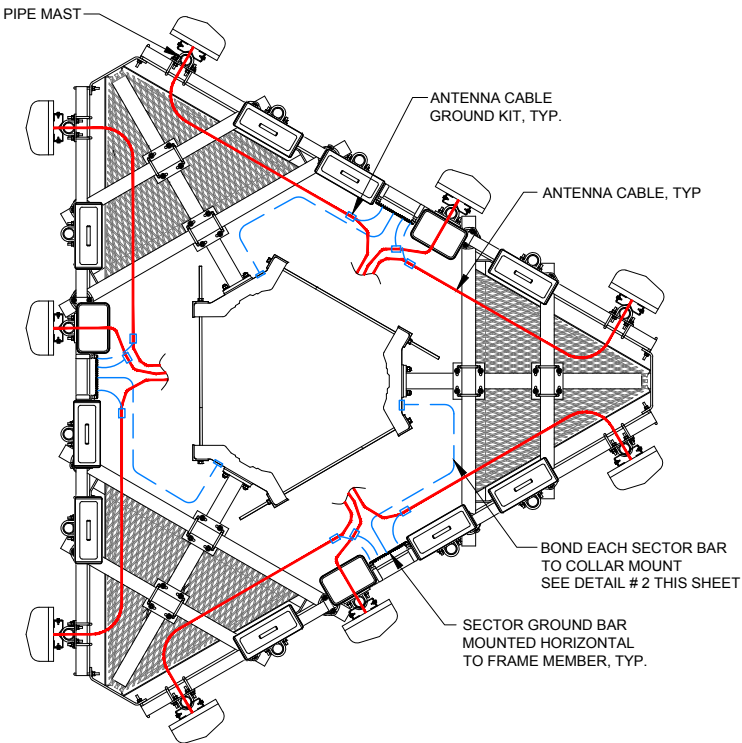

5 ANTENNA CABLE GROUNDING AT ANTENNA ELEVATION
N.T.S.

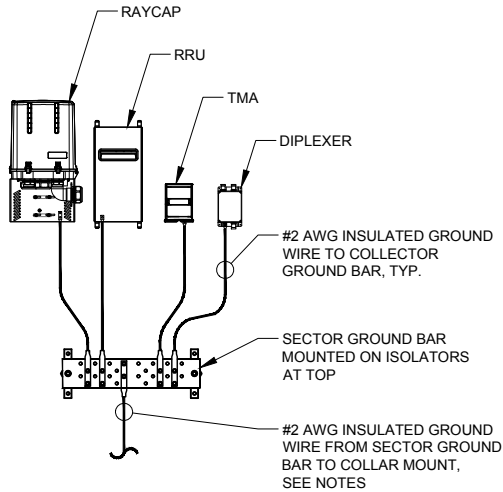

THIS DETAIL IS CONCEPTUAL TO
DEMONSTRATE GROUNDING AT THE
ANTENNA LEVEL. VERIFY EQUIPMENT,
MOUNTING FRAME, AND AZIMUTH WITH
ANT-1 SHEET & ECR.

6 TYPICAL APPURTENANCE
GROUNDING AT ANTENNA LEVEL
N.T.S.

APPROVED UL LISTED GROUND CLAMPS

APPLICATION	UL LISTED HARGER PART #
METAL FLANGE	213, 213T, 213TTP
PIPE MEMBER	CPC SERIES (SIZED TO FIT DIAMETER OF PIPE)
LARGER PIPE MEMBER	UPC SERIES (UNIVERSAL PIPE CLAMP) SIZED TO FIT DIAMETER OF PIPE
TO COLLAR MOUNT	233T

NOTES:

1. THE BOND BETWEEN THE SECTOR BAR AND THE TOWER IS TO BE MECHANICALLY BONDED TO COLLAR MOUNT. THE MECHANICAL BOND IS TO BE A UL APPROVED MECHANICAL CONNECTION CLAMP.
2. GROUND CONNECTIONS MUST BE DOUBLE HOLE CONNECTION. SPECIAL EXCEPTION ONLY TO EQUIPMENT THAT WILL NOT ALLOW FOR A DOUBLE HOLE CONNECTION.

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PH: 847-898-6400
FAX: 847-898-6401

REVISIONS		BY	DATE	DMS	JTM	DMS	RA	JTM	DMS	JTM
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LOC. # 311466

W 151ST
& S 80TH


15100 S 80TH AVE
ORLAND PARK, IL 60462

DRAWN BY:	PP
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DATE:	07/23/15
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SHEET TITLE
SITE
DETAILS


SHEET NUMBER

ANT-3

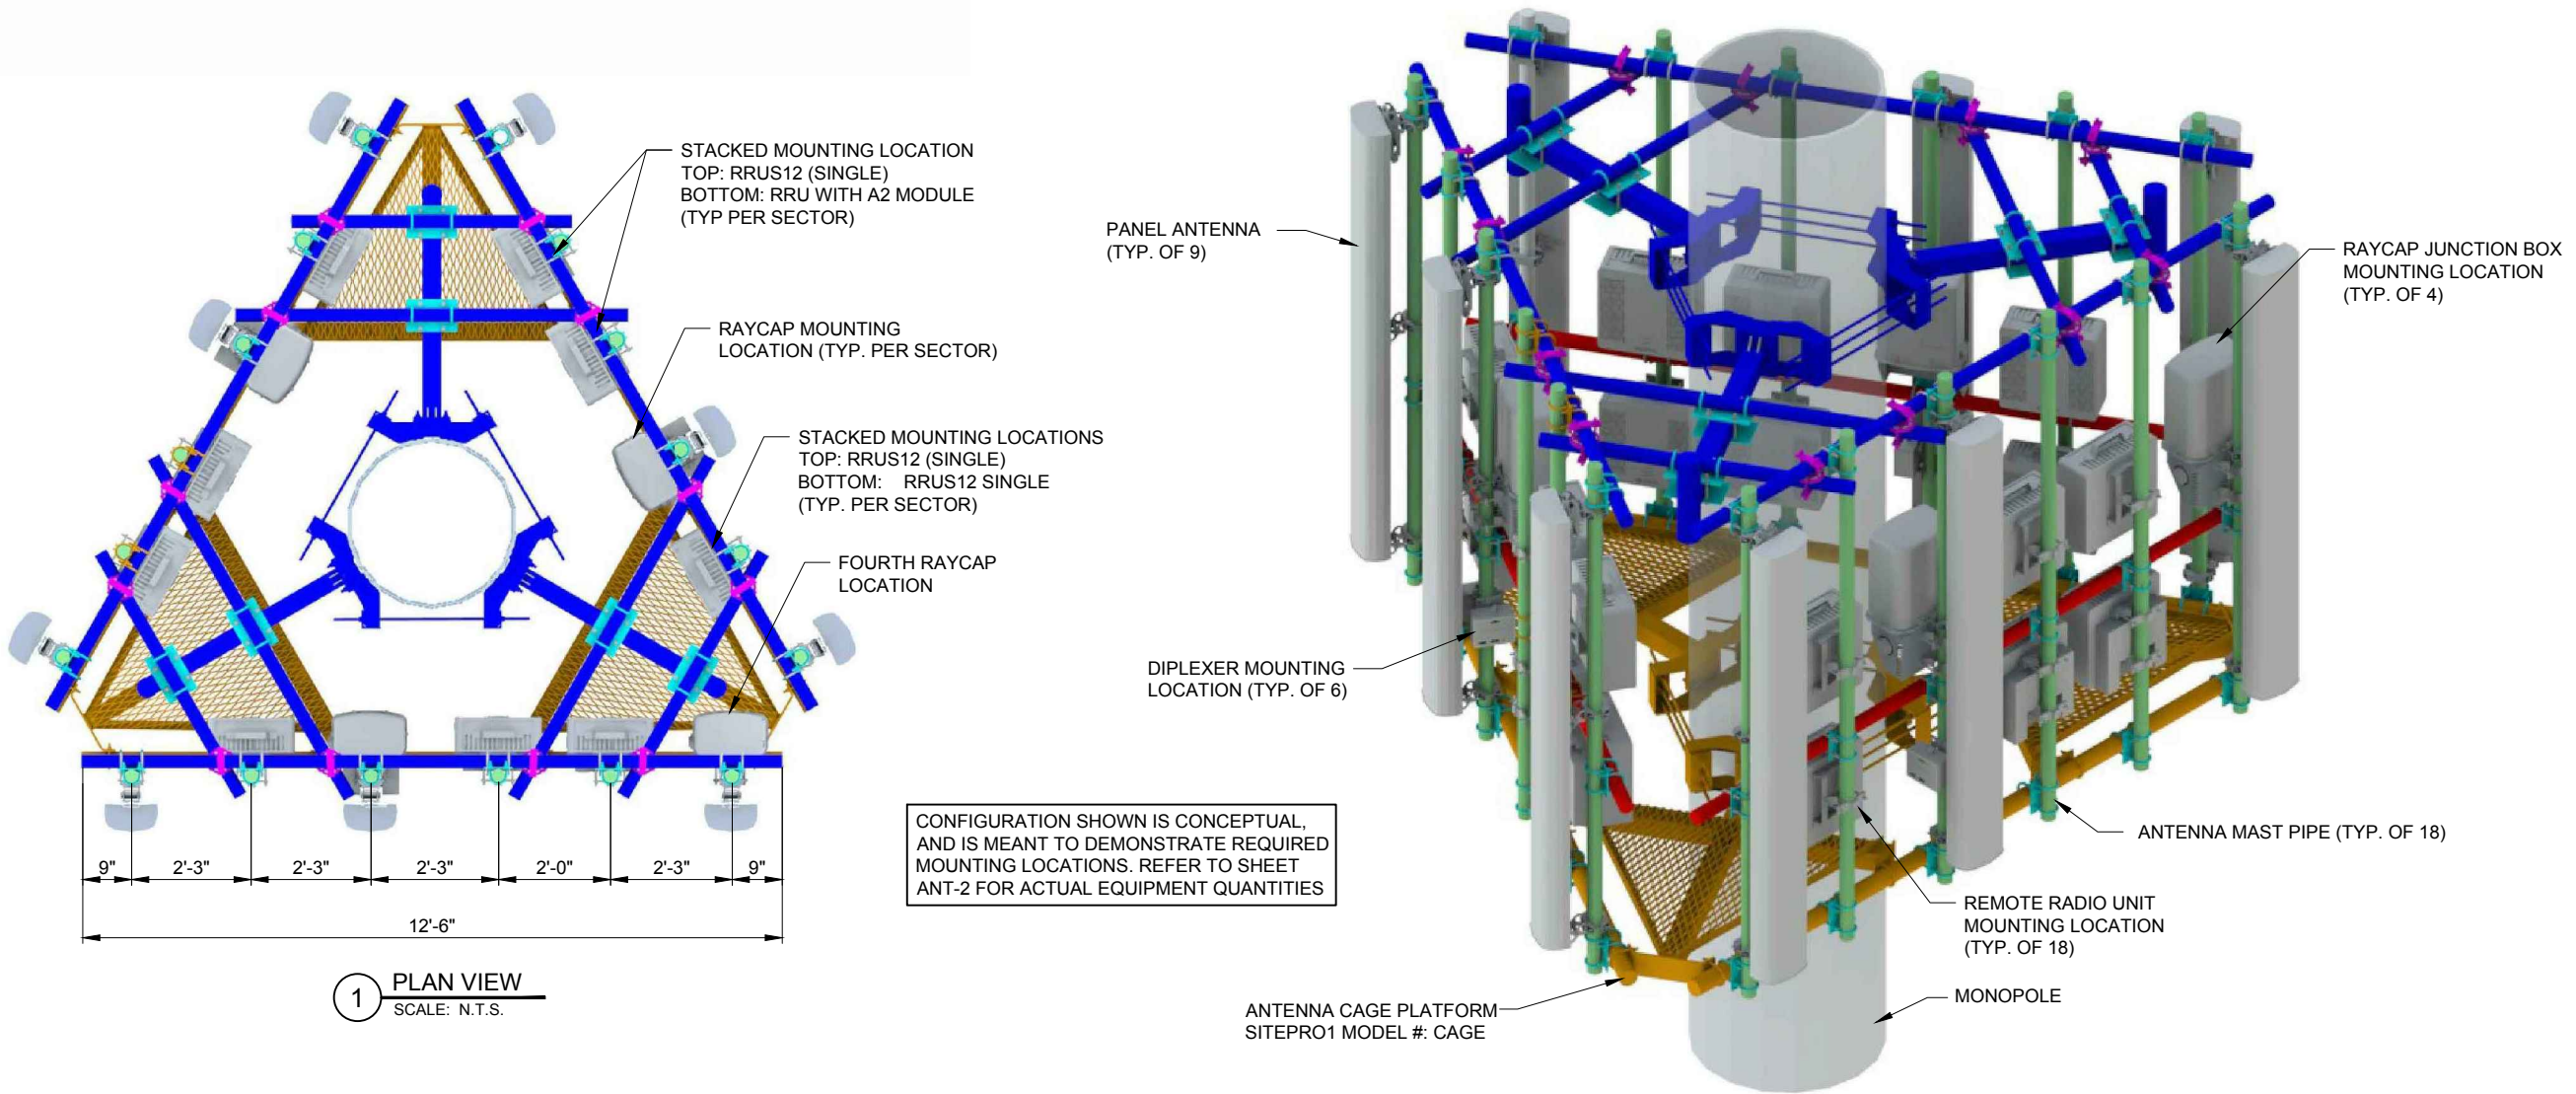


1 PLAN VIEW
SCALE: N.T.S.


2 ISOMETRIC VIEW
SCALE: N.T.S.

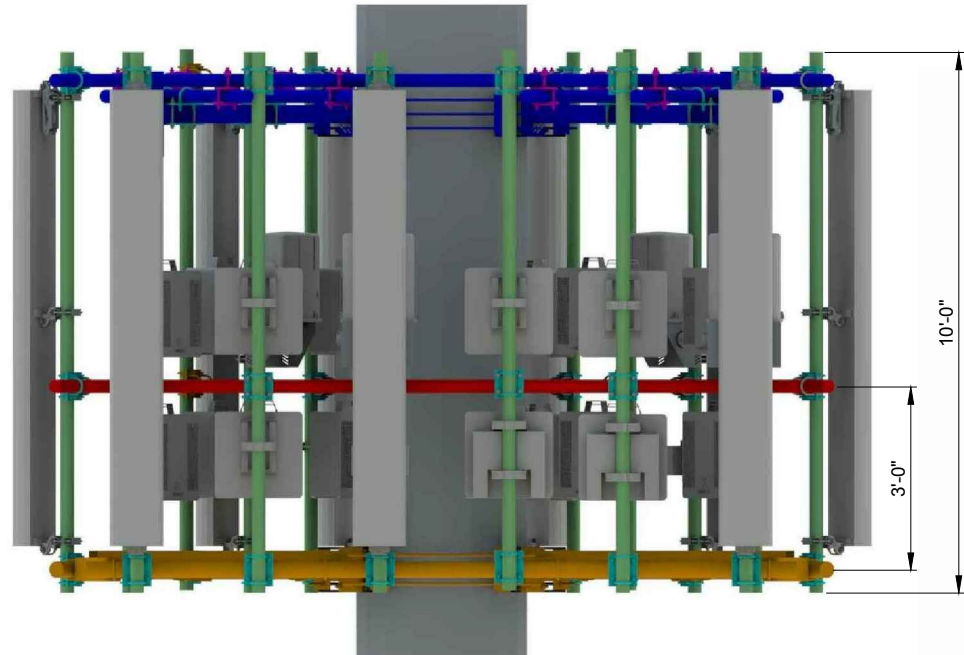

3 FRONT VIEW
SCALE: N.T.S.

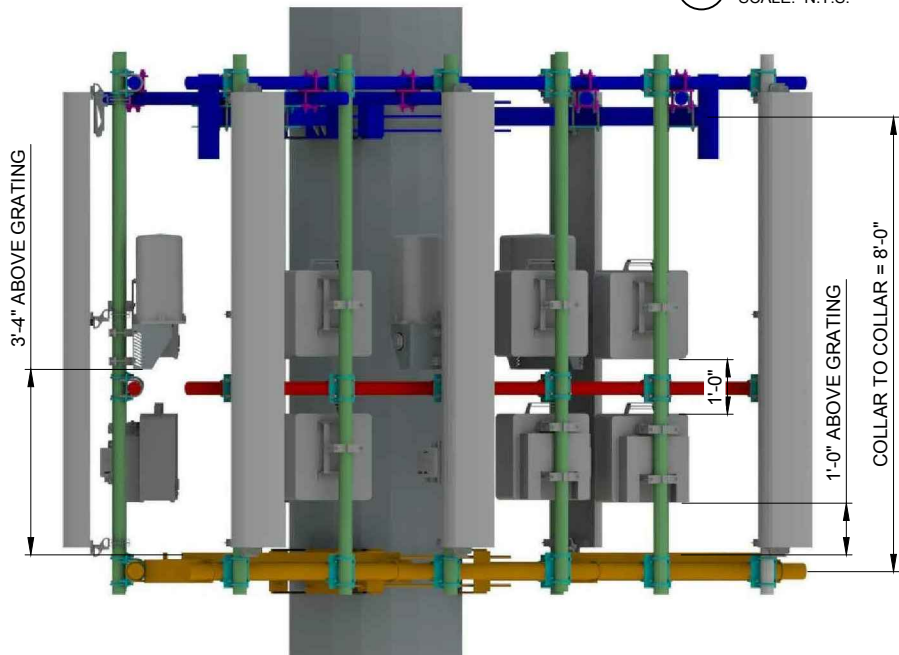

4 SIDE VIEW
SCALE: N.T.S.

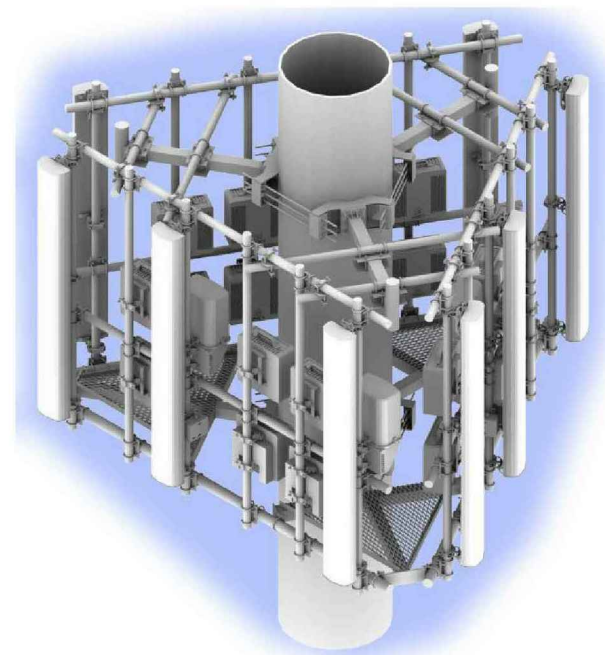

5 ISOMETRIC RENDERING
SCALE: N.T.S.

REVISIONS		NO.	DATE	BY	DESCRIPTION
		3	08/21/17	DMS	FINAL PENDING FIBER
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		9	04/05/18	JTM	REVISED LANDSCAPE PLAN PER VILLAGE

LOC. # 311466



W 151ST
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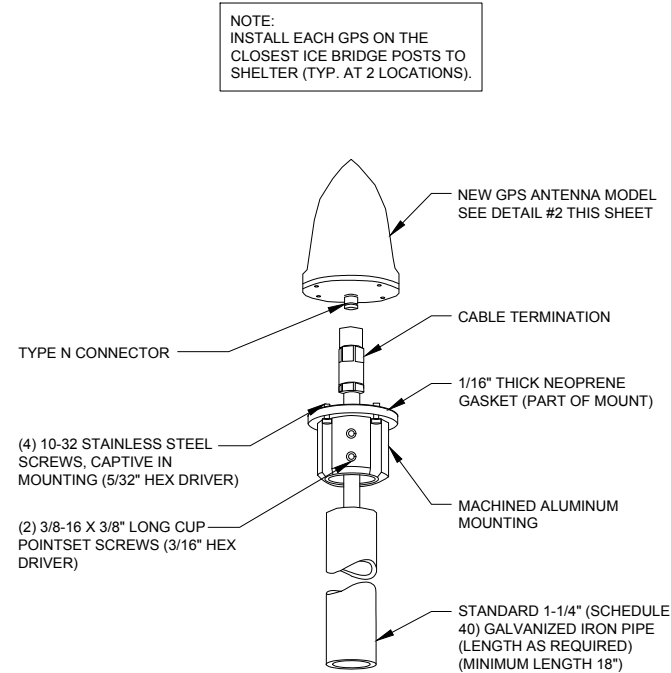
DRAWN BY:	PP
CHECKED BY:	TAZ
DATE:	07/23/15
PROJECT #:	33-1466

SHEET TITLE
**ANTENNA
MOUNTING
DETAILS**

SHEET NUMBER
ANT-3A




1 GPS MOUNTING DETAIL
N.T.S.

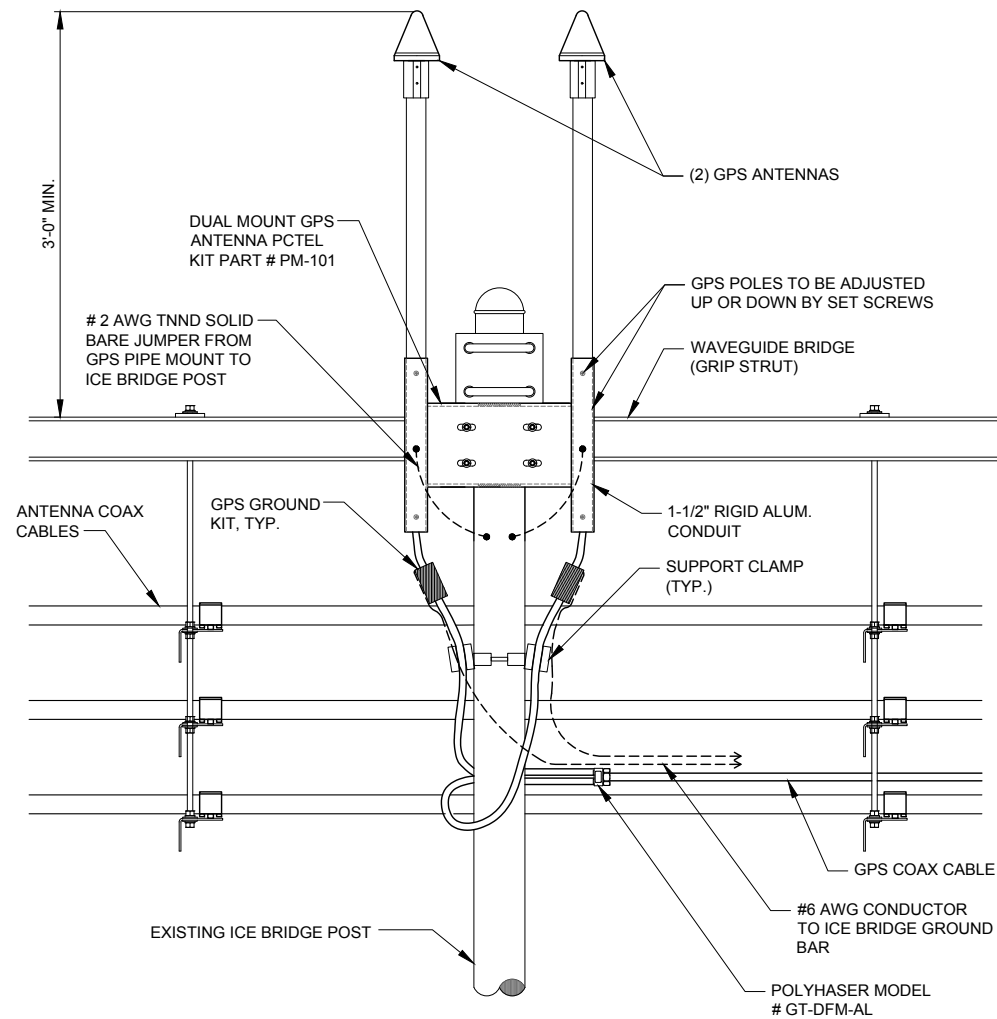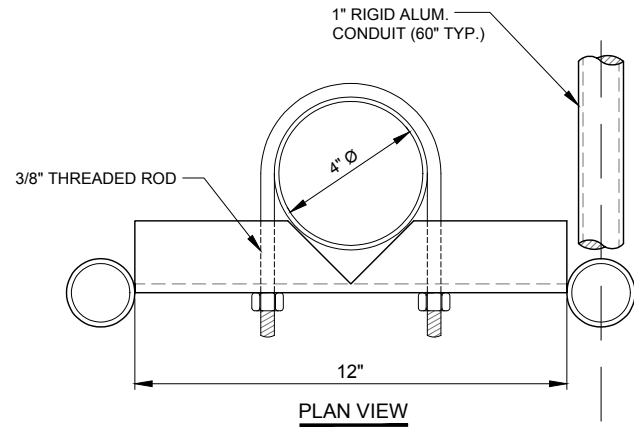


2 TYPICAL GPS DETAIL
N.T.S.


- NOTES:
- DO NOT INSTALL CABLE GROUND KIT AT A BEND AND ALWAYS DIRECT GROUND WIRE DOWN TO GROUND BAR.
 - THIS DETAIL IS TYPICAL FOR EACH CABLE WHERE IT IS SPECIFIED TO BE GROUNDED
 - CABLE TO BE GROUNDED AT ANTENNA LEVEL AND PRIOR TO ENTERING SHELTER ENTRY PANEL.
 - CABLE ALSO TO BE GROUNDED TO GROUND BAR AT TOWER BASE IF APPLICABLE.
 - USE ONLY TIN PLATED GROUNDING KITS.

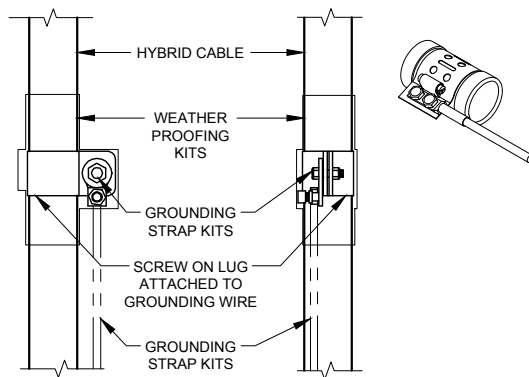

4 COAX/ HYBRID GROUND KIT DETAIL
N.T.S.

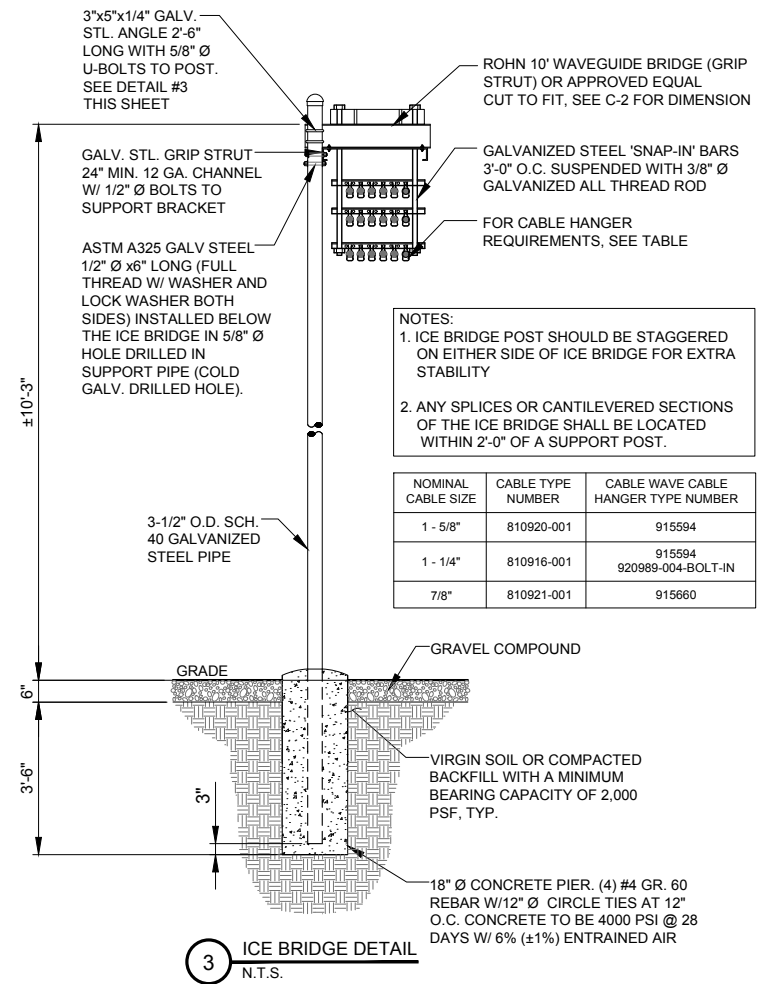

3 ICE BRIDGE DETAIL
N.T.S.

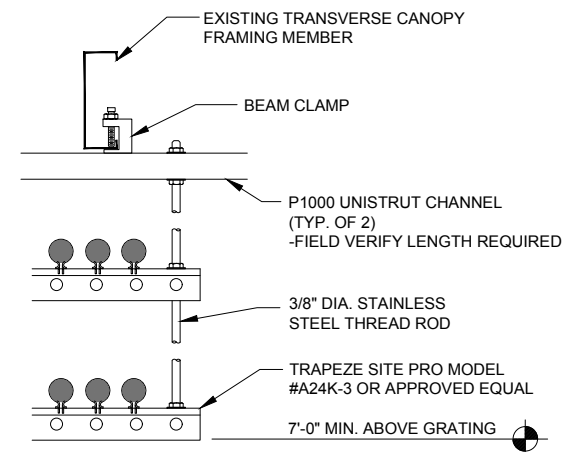

4 COAX TRAPEZE DETAIL (AT PLATFORM)
N.T.S.

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NO.		BY		DATE		DESCRIPTION	
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LOC. # 311466

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& S 80TH

15100 S 80TH AVE
ORLAND PARK, IL 60462

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SHEET TITLE
SITE
DETAILS

SHEET NUMBER

ANT-4

REVISIONS		NO.	DESCRIPTION	DATE	BY
3	FINAL PENDING FIBER	08/21/17	DMS	JTM	
4	UPDATE WITH NEW ECR	08/31/17	DMS	RA	
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W 151ST
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SHEET TITLE
**EQUIPMENT
SKID
PLAN & NOTES**

SHEET NUMBER

B-1


KEY NOTES

1. COMMSCOPE RBA72-30 EQUIPMENT CABINET (72"x31.3"x44")
2. COMMSCOPE RBA72-36 BATTERY CABINET (72"x36.3"x40.6")
3. ERICSSON 61220 ENODE B CABINET IF REQUIRED (6'-6"x2'-3"x2'x3")
4. CHARLES CUBE RL1003 FIBER ENCLOSURE
5. INTEGRATED LOAD CENTER
6. RAYCAP SURGE SUPPRESSION UNIT (VERIFY QUANTITY AND LOCATION WITH CONSTRUCTION DRAWINGS AND LOCATION OF ICE BRIDGE)
7. GENERATOR MODEL #: LP/NATURAL GAS OUTDOOR - 35KW-GENERAC SGNG SEE EX-1 PAGE FOR GENERATOR DETAILS
8. UNI-STRUT (P1000T) OVP MOUNTING RACK
9. UNI-STRUT (P1000T) ILC MOUNTING RACK
10. 3" O.D. PIPE W/ 8"x8" MOUNTING PLATE
11. FIRE EXTINGUISHER BRACKET ON UNI-STRUT (P1000T) SUPPORT
12. UNI-STRUT (P1000T) SUPPORT BASE FOR CONDUITS BETWEEN ILC AND GENERATOR.
13. 3"x4"x3/8" THK. SLOTTED ANGLE
14. 12"x36" CONCRETE STEP

NOTES:

1. EQUIPMENT SKID PRE MANUFACTURED BY OTHERS
2. THIS IS UNMANNED STORAGE AND EQUIPMENT SKID ONLY.
3. SKID SHALL BE PLACED ACCORDING TO STATE AND LOCAL CODE FROM ANY PROPERTY LINE, INTERIOR LOT LINE OR ANY OTHER BUILDING.
4. ALL ITEMS NOTED AS "FIELDWORK" SHALL BE INSTALLED AND TESTED AT THE FACTORY THEN REMOVED FOR TRANSPORT AND REINSTALLED AT THE FINAL SITE.
5. SKID NOT DESIGNED FOR INSTALLATION IN A FLOOD PRONE AREA.
6. FIRE EXTINGUISHER INSTALLED BY OTHERS WHEN NOT SUPPLIED BY SABRE.
7. THIS SKID DOES NOT CONTAIN PLUMBING FACILITIES.
8. THIS ENCLOSURE IS CLASSIFIED AS USE S-2 (IBC, FBC), U (OBC)
2006-2015 INTERNATIONAL BUILDING CODE
2009-2012 UNIFORM MECHANICAL CODE
2006-2015 INTERNATIONAL MECHANICAL CODE
2004 CHICAGO BUILDING CODE
9. DESIGN PARAMETERS
USE GROUP: S-2 (IBC, FBC)
U (OBC)
CONSTRUCTION TYPE: V-B (IBC, FBC)
OCCUPANCY CATEGORY: II
ROOF LIVE LOAD: 81 PSF
FLOOR LIVE LOAD: 986 PSF
GROUND SNOW LOAD: 96 PSF (N/A FOR FBC 2014)
WIND SPEED: 150 MPH/EXPOSURE C
SEISMIC ZONE FOR SBC & UBC: 4
SEISMIC DESIGN CATEGORY FOR IBC: E (IBC)
USE GROUP-III (OBC)
SITE CLASS-D (OBC)
BULLET RESISTANCE LEVEL 4 FOR 4" CONCRETE PER IBC
CONCRETE f'c: 5000 PSI AT 28 DAYS
CONCRETE UNIT WEIGHT: 115 PCF

10. SKID AND ASSOCIATED EQUIPMENT IS PROVIDED BY OWNER UNDER SEPARATE CONTRACT. EQUIPMENT SKID INFORMATION INDICATED HEREIN IS PROVIDED FOR REFERENCE ONLY AND IS TAKEN FROM MANUFACTURER'S AVAILABLE DATA. REFER TO CIVIL, STRUCTURAL AND ELECTRICAL DRAWINGS FOR WORK TO BE PERFORMED UNDER THIS CONTRACT.

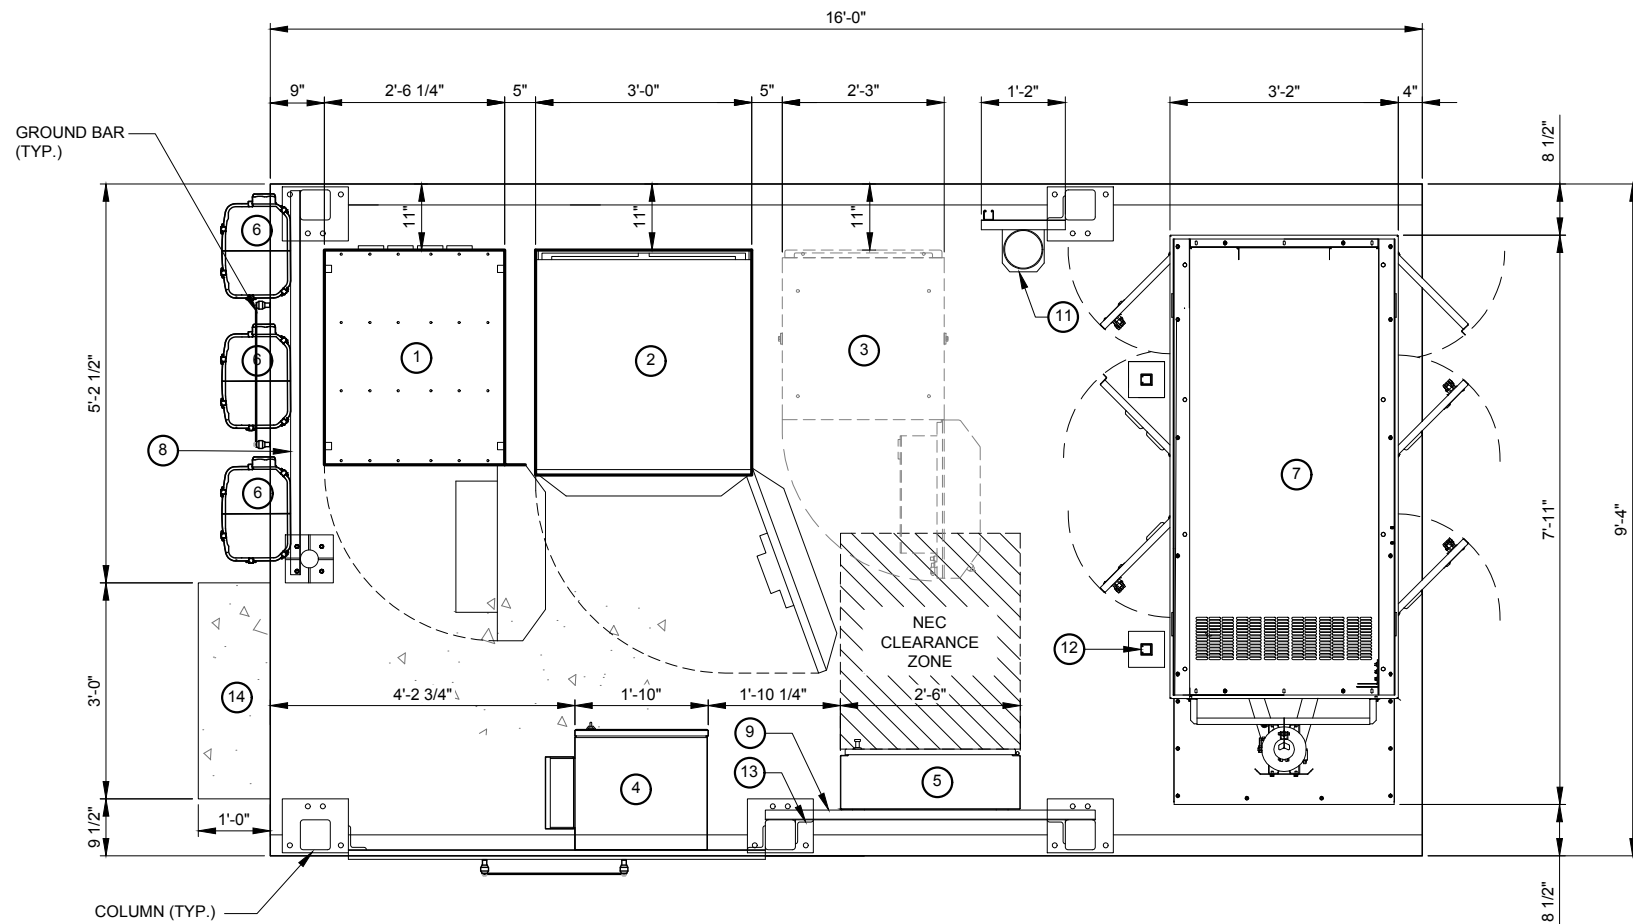

1 EQUIPMENT SKID - LAYOUT PLAN
SCALE: 3/4" = 1'-0"

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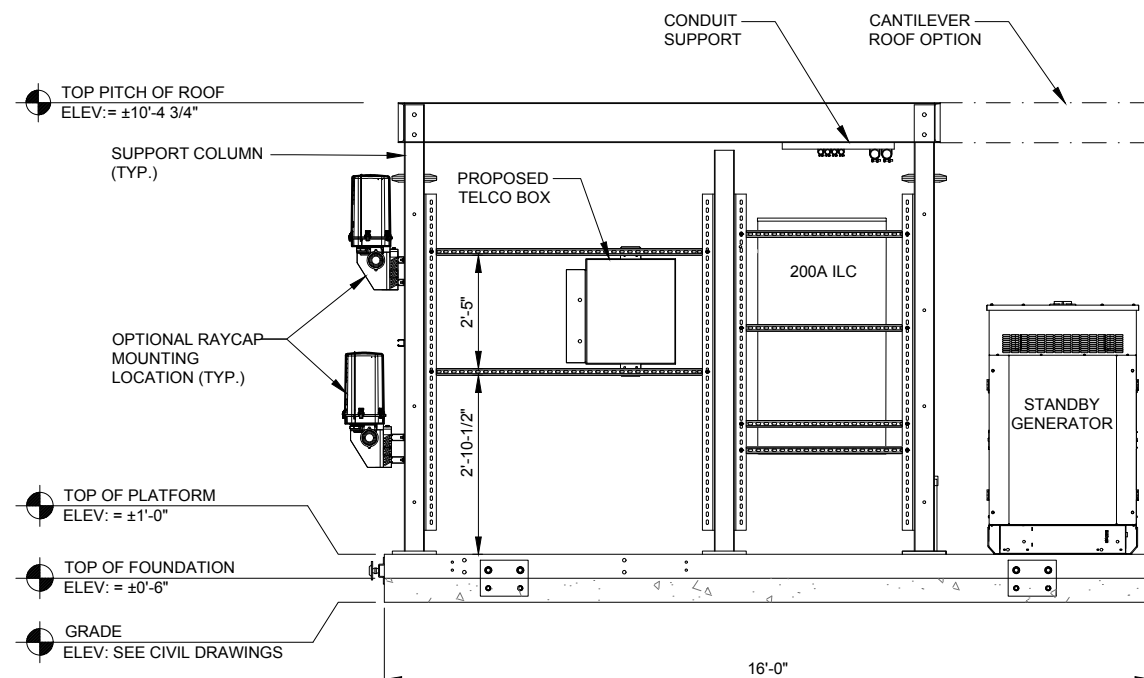
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DRAWN BY:	PP
CHECKED BY:	TAZ
DATE:	07/23/15
PROJECT #:	33-1466


SHEET TITLE
EQUIPMENT PLATFORM
ELEVATIONS

SHEET NUMBER



B-2




1 EQUIPMENT PLATFORM ELEVATION
SCALE: N.T.S.

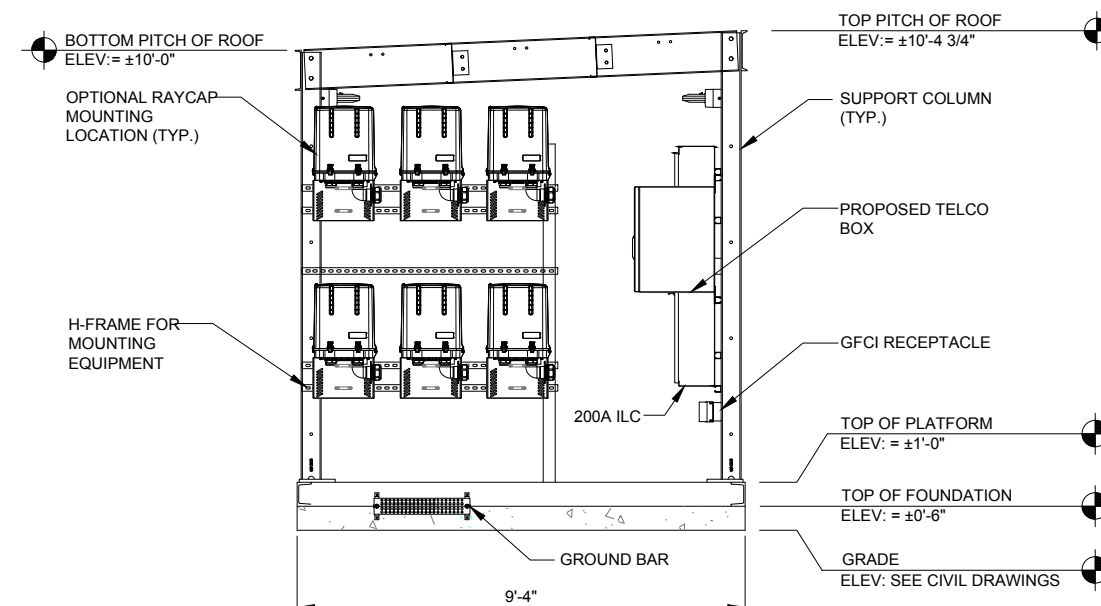

2 EQUIPMENT PLATFORM ELEVATION
SCALE: N.T.S.

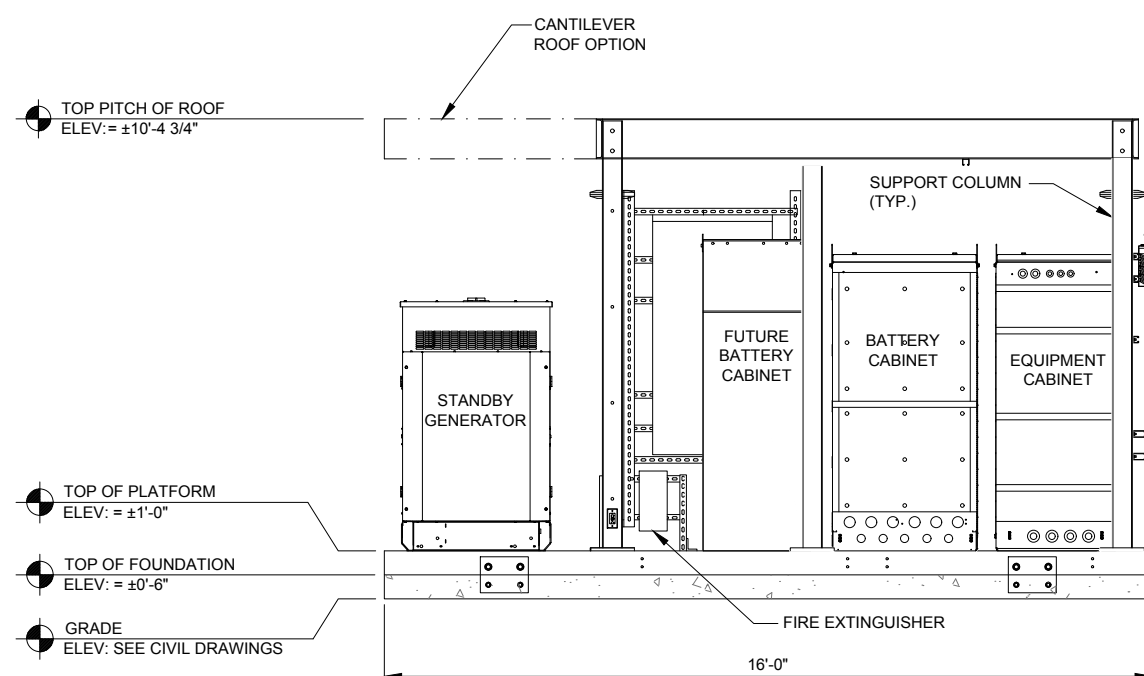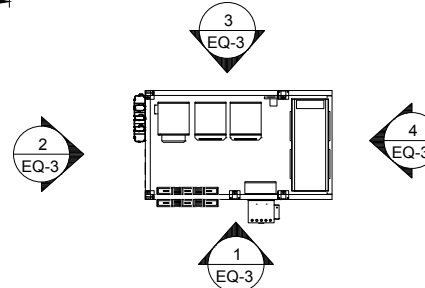

3 EQUIPMENT PLATFORM ELEVATION
SCALE: N.T.S.

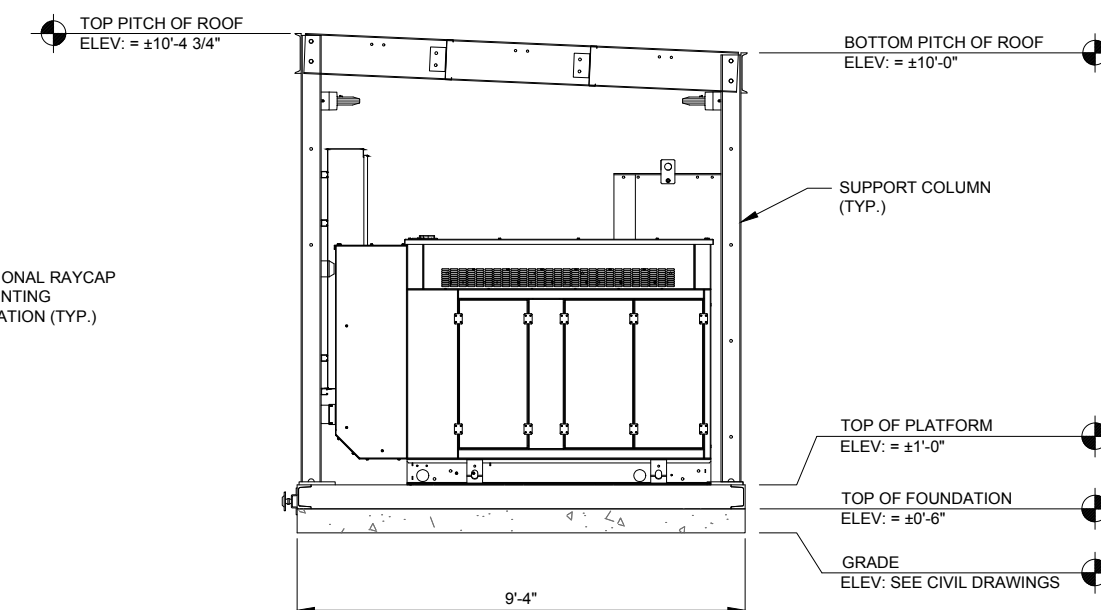

4 EQUIPMENT PLATFORM ELEVATION
SCALE: N.T.S.

NOTE: FOR REFERENCE ONLY

UTILITY NOTES:

WORK INCLUDES:
THESE NOTES AND ACCOMPANYING DRAWINGS COMPLEMENT THE PROVISIONS AND INSTALLATIONS BY THE ELECTRICAL CONTRACTOR, OF ALL LABOR, MATERIALS AND EQUIPMENT REQUIRED TO INSTALL THE ELECTRICAL WORK COMPLETE IN CONNECTION WITH THIS VERIZON WIRELESS SITE AND SHALL INCLUDE, BUT NOT BE LIMITED TO THE FOLLOWING:

1. THE PROVISIONS, INSTALLATION, AND CONNECTION OF A GROUNDING ELECTRODE SYSTEM COMPLETE WITH A BUILDING AND SECONDARY GROUNDING, CELLULAR TELEPHONE COMMUNICATIONS TOWER AND CONNECTIONS TO THE INCOMING ELECTRICAL DISTRIBUTION EQUIPMENT.
2. THE PROVISION AND INSTALLATION OF AN OVERHEAD ELECTRICAL SERVICE OR UNDERGROUND ELECTRICAL SERVICE AND ALL ASSOCIATED WIRE AND CONDUIT AS REQUIRED AND/OR INDICATED ON PLANS.
3. THE PROVISION, INSTALLATION OF CONDUIT AND CONNECTIONS FOR LOCAL TELEPHONE SERVICE.
4. THE FURNISHING AND INSTALLATION OF THE ELECTRICAL SERVICE ENTRANCE CONDUCTORS, CONDUITS, METER SOCKET, AND CONNECTIONS TO THE SERVICE EQUIPMENT WITHIN THE ENCLOSURE.
5. TWO INCH (2") AND THREE INCH (3") DIAMETER PVC CONDUITS SCHEDULE 40.
6. ALL PVC CONDUITS SHOULD BE LEFT WITH NYLON PULL CORD FOR FUTURE USE.
7. EXCAVATION, TRENCHING, AND BACKFILLING FOR CONDUIT(S), CABLE(S), AND EXTERNAL GROUNDING SYSTEM.

CODES, PERMITS, AND FEES:

1. ALL REQUIRED PERMITS, LICENSES, INSPECTIONS AND APPROVALS SHALL BE SECURED AND ALL FEES FOR SAME PAID BY CONTRACTOR.
2. THE INSTALLATION SHALL COMPLY WITH ALL APPLICABLE CODES: STATE, LOCAL AND NATIONAL, AND THE DESIGN, PERFORMANCE CHARACTERISTICS AND METHODS OF CONSTRUCTION OF ALL ITEMS AND EQUIPMENT SHALL BE IN ACCORDANCE WITH THE LATEST ISSUE OF THE VARIOUS APPLICABLE STANDARD SPECIFICATIONS OF THE FOLLOWING AUTHORITIES:

N.E.C.	NATIONAL ELECTRIC CODE
A.N.S.I.	AMERICAN NATIONAL STANDARDS INSTITUTE
I.E.E.E.	INSTITUTE OF ELECTRICAL AND ELECTRONICS ENGINEERS
A.S.T.M.	AMERICAN SOCIETY FOR TESTING MATERIALS
N.E.M.A.	NATIONAL ELECTRICAL MANUFACTURERS ASSOCIATION
U.L.	UNDERWRITERS LABORATORIES, INC.
N.F.P.A.	NATIONAL FIRE PROTECTION ASSOCIATION

RACEWAYS AND WIRING:

1. WIRING OF EVERY KIND MUST BE INSTALLED IN CONDUIT, UNLESS NOTED OTHERWISE, OR AS APPROVED BY THE ENGINEER.
2. UNLESS OTHERWISE SPECIFIED, ALL WIRING SHALL BE COPPER (CU) TYPE THWN, SIZED IN ACCORDANCE WITH THE NATIONAL ELECTRICAL CODE.
3. RACEWAYS SHALL BE GALVANIZED STEEL, SIZED IN ACCORDANCE WITH THE NATIONAL ELECTRICAL CODE, UNLESS OTHERWISE NOTED. ALL RACEWAYS SHALL BE APPROVED FOR THE INSTALLATION.
4. PULL OR JUNCTION BOXES SHALL BE PROVIDED AS REQUIRED TO FACILITATE INSTALLATION OF RACEWAYS AND WIRING. PROVIDE JUNCTION AND PULLBOXES FOR CONDUIT RUNS WITH MORE THAN (360) DEGREES OF BENDS.
5. PROVIDE A COMPLETE RACEWAY AND WIRING INSTALLATION, PERMANENTLY AND EFFECTIVELY GROUNDED IN ACCORDANCE WITH ARTICLE 250 OF THE NATIONAL ELECTRICAL CODE AND LOCAL CODES.
6. ELECTRICAL PANELBOARD SHALL BE FURNISHED AND INSTALLED BY OTHERS. ELECTRICAL CONTRACTOR SHALL FIELD VERIFY EXACT LOCATION.
7. ALL STEEL CONDUIT SHALL BE BONDED AT BOTH ENDS WITH GROUNDING BUSHING.

GENERAL NOTES:

SEE DETAILS AND SCHEDULES ON DRAWINGS AND SPECIFICATIONS FOR MEANING OF ABBREVIATIONS AND ADDITIONAL REQUIREMENTS AND INFORMATION. CHECK ARCHITECTURAL, STRUCTURAL AND OTHER MECHANICAL AND ELECTRICAL DRAWINGS FOR SCALE, SPACE LIMITATIONS, COORDINATION, AND ADDITIONAL INFORMATION, ETC. REPORT ANY DISCREPANCIES, CONFLICTS, ETC. TO ENGINEER BEFORE SUBMITTING BID. ALL EQUIPMENT FURNISHED BY OTHERS (FBO) SHALL BE PROVIDED WITH PROPER MOTOR STARTERS, DISCONNECTS, CONTROLS, ETC. BY THE ELECTRICAL CONTRACTOR UNLESS SPECIFICALLY NOTED OTHERWISE. THE ELECTRICAL CONTRACTOR SHALL INSTALL AND COMPLETELY WIRE ALL ASSOCIATED EQUIPMENT IN ACCORDANCE WITH MANUFACTURER'S WIRE DIAGRAMS AND AS REQUIRED FOR A COMPLETE OPERATING INSTALLATION. ELECTRICAL CONTRACTOR SHALL VERIFY AND COORDINATE ELECTRICAL CHARACTERISTICS AND REQUIREMENTS OF (FBO) EQUIPMENT PRIOR TO ROUGH-IN OF CONDUIT AND WIRING TO AVOID CONFLICTS.

COORDINATION WITH UTILITY COMPANY:

THE ELECTRICAL CONTRACTOR SHALL COORDINATE COMPLETE ELECTRICAL SERVICE WITH LOCAL UTILITY COMPANY FOR A COMPLETE OPERATIONS SYSTEM, INCLUDING TRANSFORMER CONNECTIONS, CONCRETE TRANSFORMER PADS, IF REQUIRED, METER SOCKETS, PRIMARY CABLE RACEWAY REQUIREMENTS, SECONDARY SERVICE, ETC. PRIOR TO SUBMITTING BID TO INCLUDE ALL LABOR AND MATERIALS. THE ELECTRICAL CONTRACTOR SHALL INCLUDE IN THE BID ANY OPTIONAL OR EXCESS FACILITY CHARGES ASSOCIATED WITH PROVIDING ELECTRICAL SERVICE FROM LOCAL UTILITY COMPANY. VERIFY BEFORE BIDDING TO INCLUDE ALL COSTS. THE ELECTRICAL CONTRACTOR SHALL VERIFY THE AVAILABLE FAULT CURRENT WITH THE LOCAL UTILITY COMPANY PRIOR TO SUBMITTING BID. ADJUST A.I.C. RATINGS OF ALL OVER CURRENT PROTECTION DEVICES IN DISTRIBUTION EQUIPMENT AS REQUIRED TO COORDINATE WITH AVAILABLE FAULT CURRENT FROM LOCAL UTILITY COMPANY. ALL GROUNDING RODS PROVIDED BY THE POWER OR TELEPHONE UTILITY COMPANIES MUST BE TIED INTO THE MAIN EXTERNAL GROUND RING.


UTILITY CONTACTS:

POWER: COMED
LEONARD ANDERSON
(708) 235-2346

FIBER: ONE FIBER
WADE BOWERS
(512)618-3411

ELECTRICAL CONTRACTOR SHALL COORDINATE WITH POWER COMPANY FOR ENTRY INTO FENCED AREA BY EITHER MAILING A KEY TO A SLAVE LOCKED CHAIN AT THE FENCE GATE OR CALLING AND LEAVING A COMBINATION.

FOR CONTINUATION AND CONNECTION OF ELECTRIC AND FIBER SERVICE. COORDINATE WITH ELECTRIC AND FIBER COMPANY.

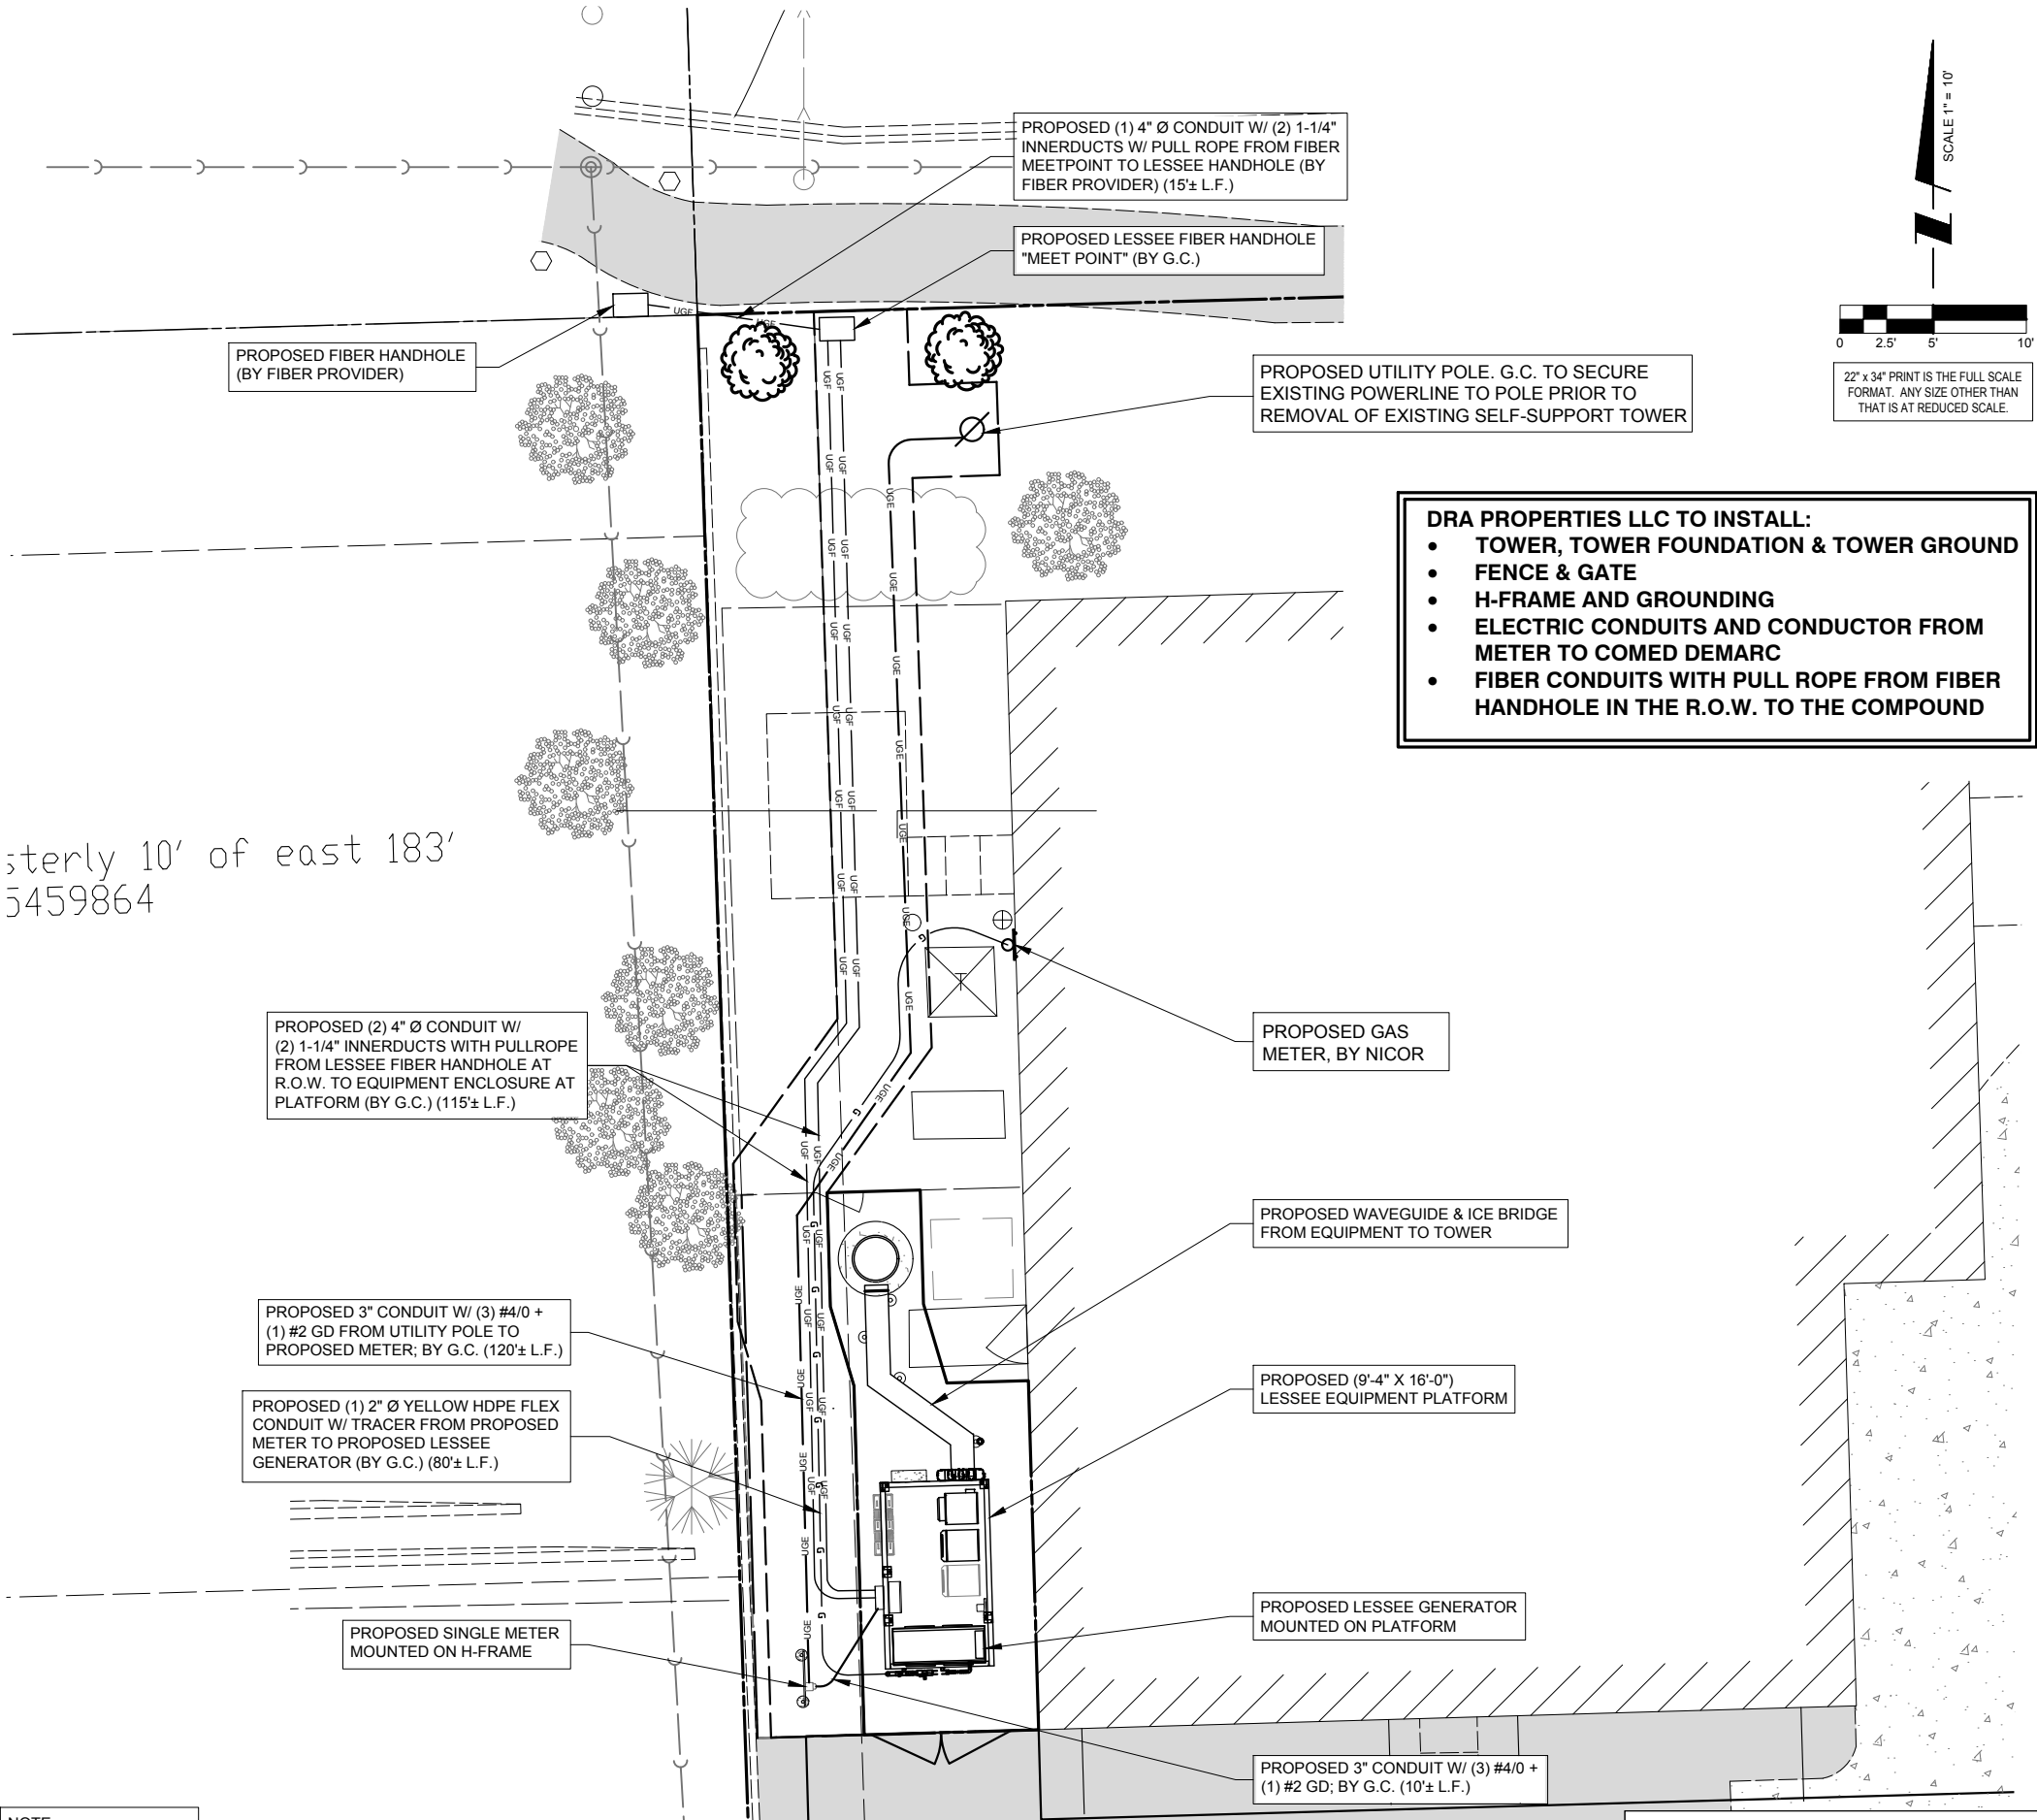

DRA PROPERTIES LLC TO INSTALL:

- TOWER, TOWER FOUNDATION & TOWER GROUND
- FENCE & GATE
- H-FRAME AND GROUNDING
- ELECTRIC CONDUITS AND CONDUCTOR FROM METER TO COMED DEMARC
- FIBER CONDUITS WITH PULL ROPE FROM FIBER HANDHOLE IN THE R.O.W. TO THE COMPOUND

REVISIONS

NO.	DESCRIPTION	DATE	BY
3	FINAL PENDING FIBER	08/21/17	DMS
4	UPDATE WITH NEW ECR	08/31/17	JTM
5	UPDATE WITH NEW LAYOUT	09/08/17	DMS
6	FINALS WITH FINER	10/20/17	RA
7	ADDITION OF LANDSCAPING PLAN	12/29/17	JTM
8	UPDATE PER GAS COORDINATION	01/31/18	DMS
9	REVISED LANDSCAPE PLAN PER VILLAGE	04/05/18	JTM

LOC. # 311466



W 151ST
& S 80TH

15100 S 80TH AVE
ORLAND PARK, IL 60462

DRAWN BY:	PP
CHECKED BY:	TAZ
DATE:	07/23/15
PROJECT #:	33-1466

SHEET TITLE
UTILITY ROUTING PLAN

SHEET NUMBER
E-1

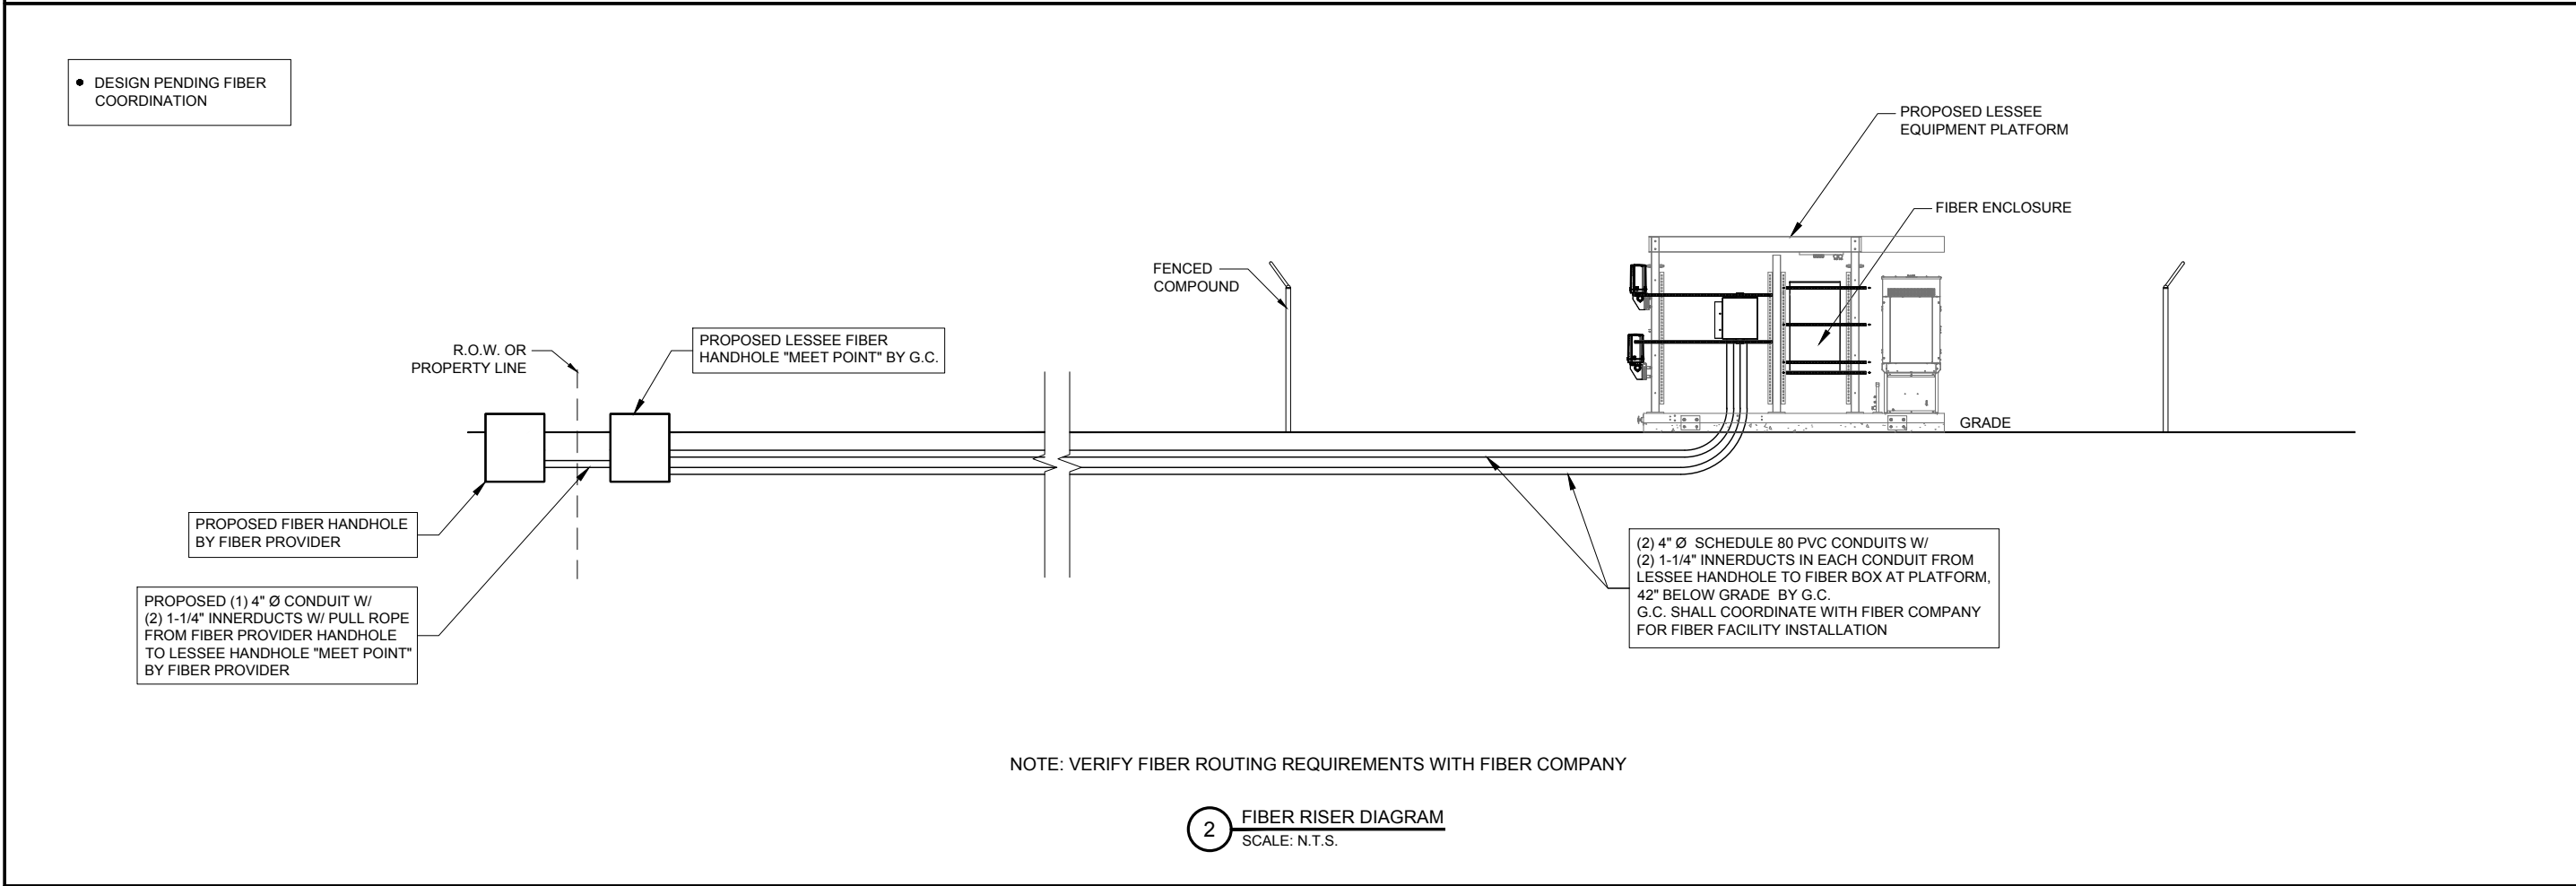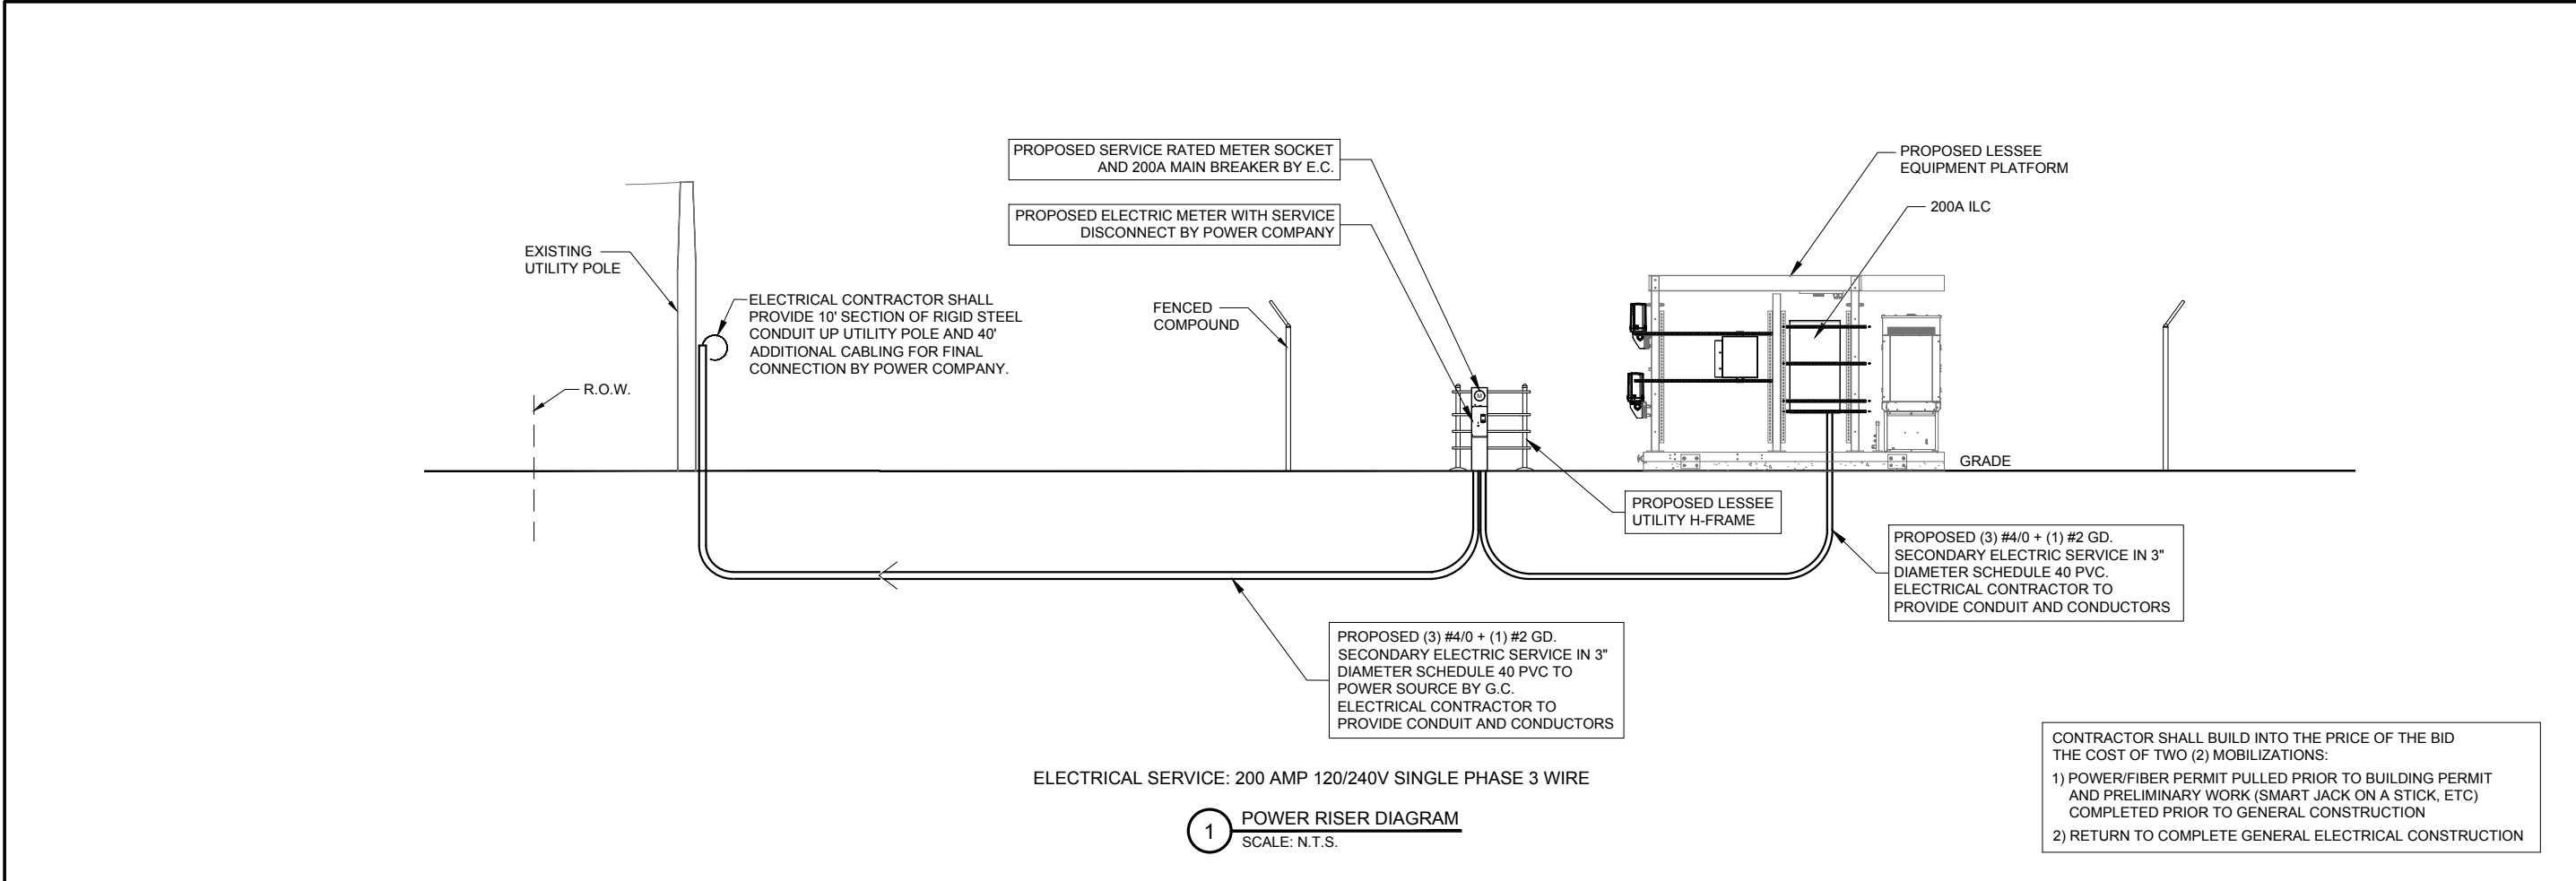

CHICAGO
SMSA

limited partnership
d/b/a VERIZON WIRELESS

TERRA

CONSTRUCTIVE GROUP, LTD.

600 BUSSE HIGHWAY
PARK RIDGE, IL 60068
PH: 847-898-6400
FAX: 847-898-6401

REVISIONS	
NO.	DESCRIPTION
3	FINAL PENDING FIBER
4	UPDATE WITH NEW ECR
5	UPDATE WITH NEW LAYOUT
6	FINALS WITH FINER
7	ADDITION OF LANDSCAPING PLAN
8	UPDATE PER GAS COORDINATION
9	REVISED LANDSCAPE PLAN PER VILLAGE

LOC. # 311466


W 151ST
& S 80TH

15100 S 80TH AVE
ORLAND PARK, IL 60462

DRAWN BY:	PP
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SHEET TITLE
UTILITY RISER
DIAGRAMS

SHEET NUMBER
E-1A

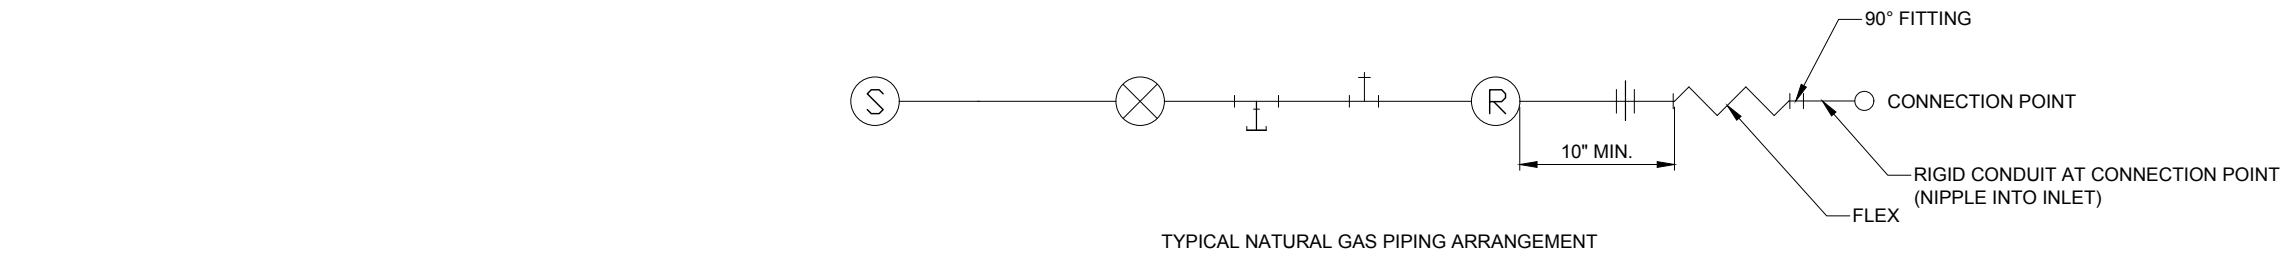

TYPICAL NATURAL GAS PIPING ARRANGEMENT

1 PIPING SCHEMATIC
N.T.S.

LEGEND:

- Ⓢ GAS SUPPLY PER VERIZON SPEC.
- ⊗ 1-1/4" FULL PORT MANUAL SHUT OFF VALVE
- ┴ DIRT LEG (1-1/4" TEE w/ 6" DROP NIPPLE + 1-1/4" CAP
- ┴ 1-1/4" x 1-1/4"x 1/2" TEE ACCESS FOR PRESSURE GAUGE w/ 1/2" PETE'S PLUG ADAPTER
- Ⓡ SENSUS GAS REGULATOR (SEE CHART)
- UNION
- ↘ FLEX CONNECTOR

PIPE SIZING & REGULATOR MODEL CHART		
GENERATOR MODEL	PIPE SIZE	REGULATOR MODEL
SG035 (35KW)	1-1/4"	SENSUS MODEL 143-80-2 W/ GREEN SPRING & 1/2" ORIFICE AT 10 DEGREES
SG050 (50KW)	1-1/4"	SENSUS MODEL 143-80-2 W/ GREEN SPRING & 1/2" ORIFICE AT 10 DEGREES
SG100 (100KW)*	1-1/4"	SENSUS MODEL 243-12-2 W/ GREEN SPRING & 3/4" ORIFICE AT 10 DEGREES
	1-1/2"	SENSUS MODEL 243-12-2 W/ GREEN SPRING & 1/2" ORIFICE AT 10 DEGREES


*FOR 400A SITES

NOTES:


1. ALL PIPING SHALL BE 1-1/4" BLACK PIPE SCHEDULE 40 (UNLESS OTHERWISE SPECIFIED).
2. ALL FITTING SHALL BE 1-1/4" BLACK MALLEABLE IRON (UNLESS OTHERWISE SPECIFIED).

NOTE:

THE GENERAL CONTRACTOR IS TO VERIFY REGULATOR SIZE BASED ON THE SIZE OF THE GENERATOR. THIS IS BASED ON HAVING A 2 PSI GAS (INLET) PRESSURE SUPPLY FROM THE GAS METER TO THE SENSUS REGULATOR & GENERATOR OUTLET PRESSURE OF 11"-14" W.C.

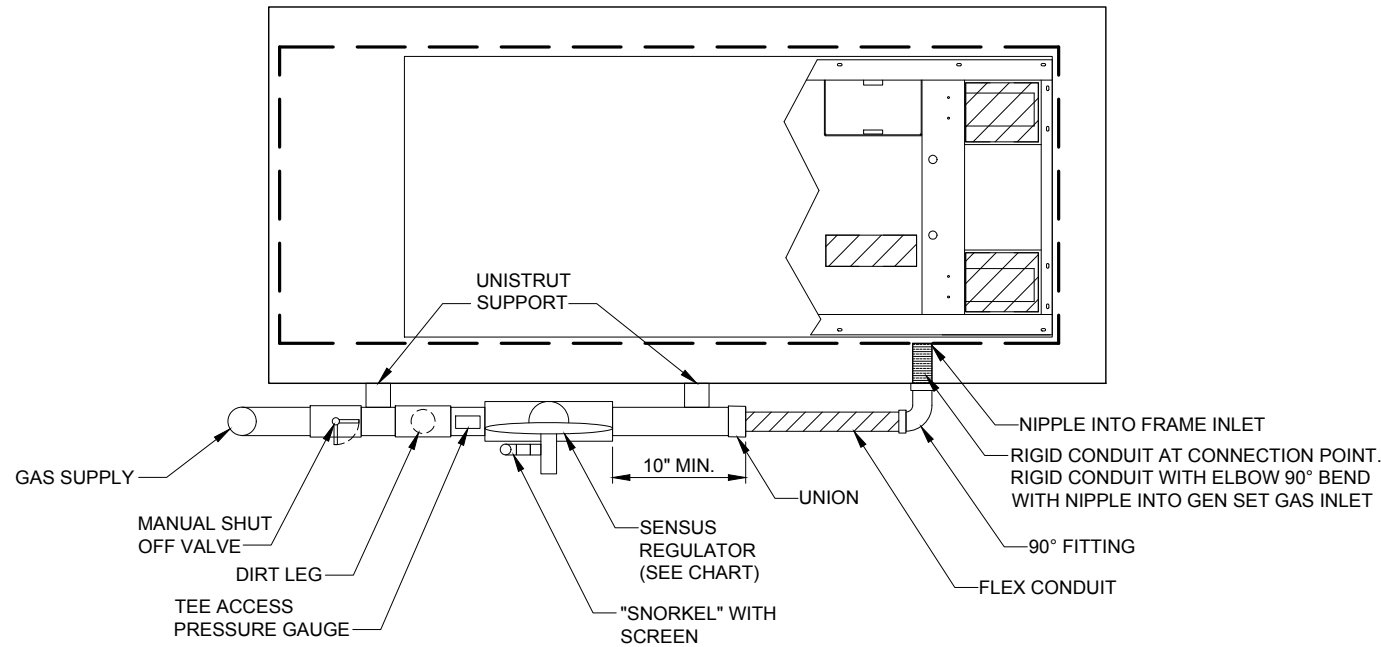

2 GAS PIPING PLAN AT GENERATOR
N.T.S.

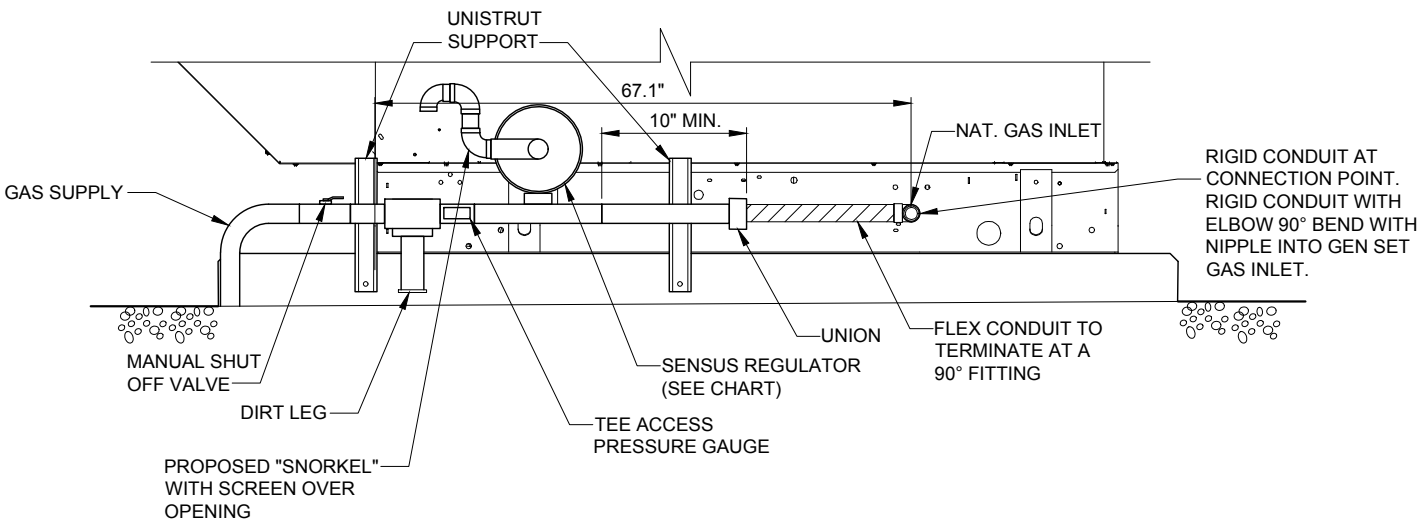

3 GAS PIPING PROFILE AT GENERATOR
N.T.S.

CHICAGO SMSA
limited partnership
d/b/a VERIZON WIRELESS



REVISONS		NO.	DESCRIPTION	DATE	BY
		3	FINAL PENDING FIBER	08/21/17	DMS
		4	UPDATE WITH NEW ECR	08/31/17	JTM
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		7	ADDITION OF LANDSCAPING PLAN	12/29/17	JTM
		8	UPDATE PER GAS COORDINATION	01/31/18	DMS
		9	REVISED LANDSCAPE PLAN PER VILLAGE	04/05/18	JTM

LOC. # 311466

W 151ST
& S 80TH

15100 S 80TH AVE
ORLAND PARK, IL 60462

DRAWN BY:	PP
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PROJECT #:	33-1466

SHEET TITLE
GAS PIPING
DETAILS

SHEET NUMBER

E-1B

GROUNDING ELECTRODE SYSTEM NOTES:

1. ALL GROUNDING CONNECTIONS SHALL BE MADE BY THE EXOTHERMIC PROCESS CONNECTIONS SHALL INCLUDE ALL CABLE TO CABLE, SPLICES, ETC. ALL CABLE TO GROUND RODS, GROUND RODS SPLICES AND LIGHTNING PROTECTION SYSTEM AS INDICATED. GROUND FOUNDATION ONLY AS INDICATED BY PM. ALL MATERIALS USED (MOLDS, WELDING, METAL, TOOLS, ETC.) SHALL BE BY EXOTHERMIC PROCESS AND INSTALLED PER MANUFACTURERS RECOMMENDATIONS AND PROCEDURES. GROUND CONDUCTOR SHALL HAVE A MINIMUM 24" BENDING RADIUS.
2. ALL EXOTHERMIC CONNECTIONS ON GALVANIZED SURFACES SHALL BE CLEANED THOROUGHLY AND COLORED TO MATCH SURFACE WITH (2) TWO COATS OF SHERWIN-WILLIAMS GALVITE (WHITE) PAINT B50W3 (OR EQUAL) OR SHERWIN- WILLIAMS SILVERBRITE (ALUMINUM) B59S11 (OR EQUAL).
3. ALL ELECTRICAL & MECHANICAL GROUND CONNECTIONS SHALL HAVE ANTI-OXIDANT COMPOUND APPLIED TO CONNECTION
4. FENCE/GATE: GROUND FENCE POSTS WITHIN 6 FEET OF PLATFORM AND 25 FEET OF TOWER AS INDICATED ON DRAWINGS. GROUND EACH GATE POST AND CORNER POST. GROUND CONNECTIONS TO FENCE POSTS SHALL BE MADE BY THE EXOTHERMIC PROCESS AND INSTALLED PER MANUFACTURER'S RECOMMENDATIONS AND PROCEDURES. ALL OTHER CONNECTIONS FOR THE GROUND GRID SYSTEM SHALL BE MADE BY THE EXOTHERMIC PROCESS, AND INSTALLED PER MANUFACTURER'S RECOMMENDATIONS AND PROCEDURES.
6. UTILITY COMPANY COORDINATION: ELECTRICAL CONTRACTOR SHALL CONFIRM THAT ALL WORK IS IN ACCORDANCE WITH THE RULES OF THE LOCAL UTILITY COMPANY BEFORE SUBMITTING THE BID, THE CONTRACTOR SHALL CHECK WITH THE UTILITY COMPANIES SUPPLYING SERVICE TO THIS PROJECT AND SHALL DETERMINE FROM THEM ALL EQUIPMENT AND CHARGES WHICH THEY WILL REQUIRE AND SHALL INCLUDE THE COST IN THE BID.
7. GROUND TEST: GROUND TESTS SHALL BE PERFORMED AS REQUIRED BY LESSEE STANDARD PROCEDURES. GROUND GRID RESISTANCE SHALL NOT EXCEED 5 OHMS.
8. CONTRACTOR SHALL SUBMIT THE GROUND RESISTANCE TEST REPORT AS FOLLOWS:
 1. ONE (1) COPY TO OWNER REPRESENTATIVE
 2. ONE (1) COPY TO ENGINEER
 3. ONE (1) COPY TO KEEP INSIDE EQUIPMENT ENCLOSURE

TYPICAL KEYED GROUNDING NOTES


- 1 #2 AWG TNNND SOLID BARE COPPER CONDUCTOR 42" BELOW GRADE (TYPICAL) MINIMUM 24" BENDING RADIUS
- 2 PLATFORM CORNER POST, STEEL COLUMN, STEEL BEAM & CANOPY GROUND
- 3 CABINET GROUND BOLTED TO UNIT HOUSING
- 4 DISCONNECT AND ELECTRIC SERVICE GROUND TO GROUND ROD
- 5 5/8" x 10' COPPER CLAD GROUND ROD
- 6 GROUND CHAIN LINK FENCE (TYPICAL) EXOTHERMIC CONNECTION (TYPE VS) GROUND FENCE POSTS WITHIN 6 FEET OF PLATFORM AND 25 FEET OF TOWER. (SEE DETAIL, SHEET E-5.)
- 7 MAINTAIN TWO FOOT DISTANCE OFF OF STRUCTURES.
- 8 GROUND COAXIAL ANTENNA CABLES TO GROUND BAR BY ANTENNA CONTRACTOR TERMINATE CABLES 1'-0" FROM PLATFORM AND INSTALL LIGHTNING SURGE ARRESTORS ON EACH CABLE GROUND.
- 9 EXOTHERMICALLY WELD COPPER GROUND BAR TAIL TO HALO GROUND RING (EXOTHERMIC CONNECTION TYPE TA) BY ANTENNA CONTRACTOR. FINAL CONNECTION BY ELECTRICAL CONTRACTOR.
- 10 4"x20"x1/4" TNNND INSULATED COPPER GROUND BAR, NON ISOLATED WITH 10.0' LONG #2 AWG TNNND SOLID COPPER WIRE WELDED TAILS (HARGER GBIT 14420VVV)
- 11 GROUND CABLE WAVEGUIDE BRIDGE (TYP.) BY ELECTRICAL CONTRACTOR.
- 12 PROPOSED PERIPHERAL GROUND RING SHOULD BE INSTALLED 1' TO 2' INSIDE THE FENCE LINE, THE TOWER GROUND RING SHOULD BE INSTALLED A MINIMUM 2' OFF OF ANY STRUCTURES.
- 13 EXISTING TOWER OR COMPOUND GROUND RING (V.I.F.)
- 14 GATE JUMPERS (SEE DETAIL, SHEET E-4)
- 15 BOND EXISTING/ PROPOSED TOWER GROUND RING TO PROPOSED PLATFORM GROUND RING WITH #2 AWG TNNND SOLID COPPER CONDUCTOR IN 2 LOCATIONS.
- 16 TWO #2 LEADS FROM THE EGR TO THE GROUND BAR AT UTILITY FRAME LOCATED ON PLATFORM STEEL. CADWELD AT EGR AND DOUBLE HOLE LUGS ON PLATFORM.
- 17 BOND RAYCAP TO MGB.
- 18 EACH TOWER FOUNDATION MESH/CAGE TO BE BONDED TO TOWER GROUND RING WITH #2 TINNED SOLID COPPER CONDUCTOR
- 19 EACH TOWER FOUNDATION TO HAVE AT LEAST ONE ANCHOR BOLT BONDED TO TOWER GROUND RING WITH #2 TINNED SOLID COPPER CONDUCTOR
- 20 COPPER CLAD GROUND ROD WITH INSPECTION WELL TOP OF GROUND ROD MAX 24" BURY.
- 21 EXTEND GROUND CONDUCTORS IN 1/2" RIGID H.W. CONDUIT ADJACENT TO PAD, OFFSET AND ATTACH TO EXTERIOR OF GENERATOR HOUSING AND EXTEND TO GROUND LUGS AS REQUIRED, VERIFY LOCATION WITH GENERAC.
- 22 MGB MOUNTED UNDER PERIMETER BEAM



NOTE:
SEE GROUNDING DETAILS
ON SHEETS E-3 & E-4

LEGEND:

- GROUND BAR OR ARRESTOR BAR
- 5/8"Ø x 10'-0" GROUND ROD
- GROUND SYSTEM TEST WELL
- CADWELD OR APPROVED CONNECTION
- SPARE GROUND LEAD
- MECHANICAL CONNECTION
- EXISTING GROUNDING
- NEW GROUNDING

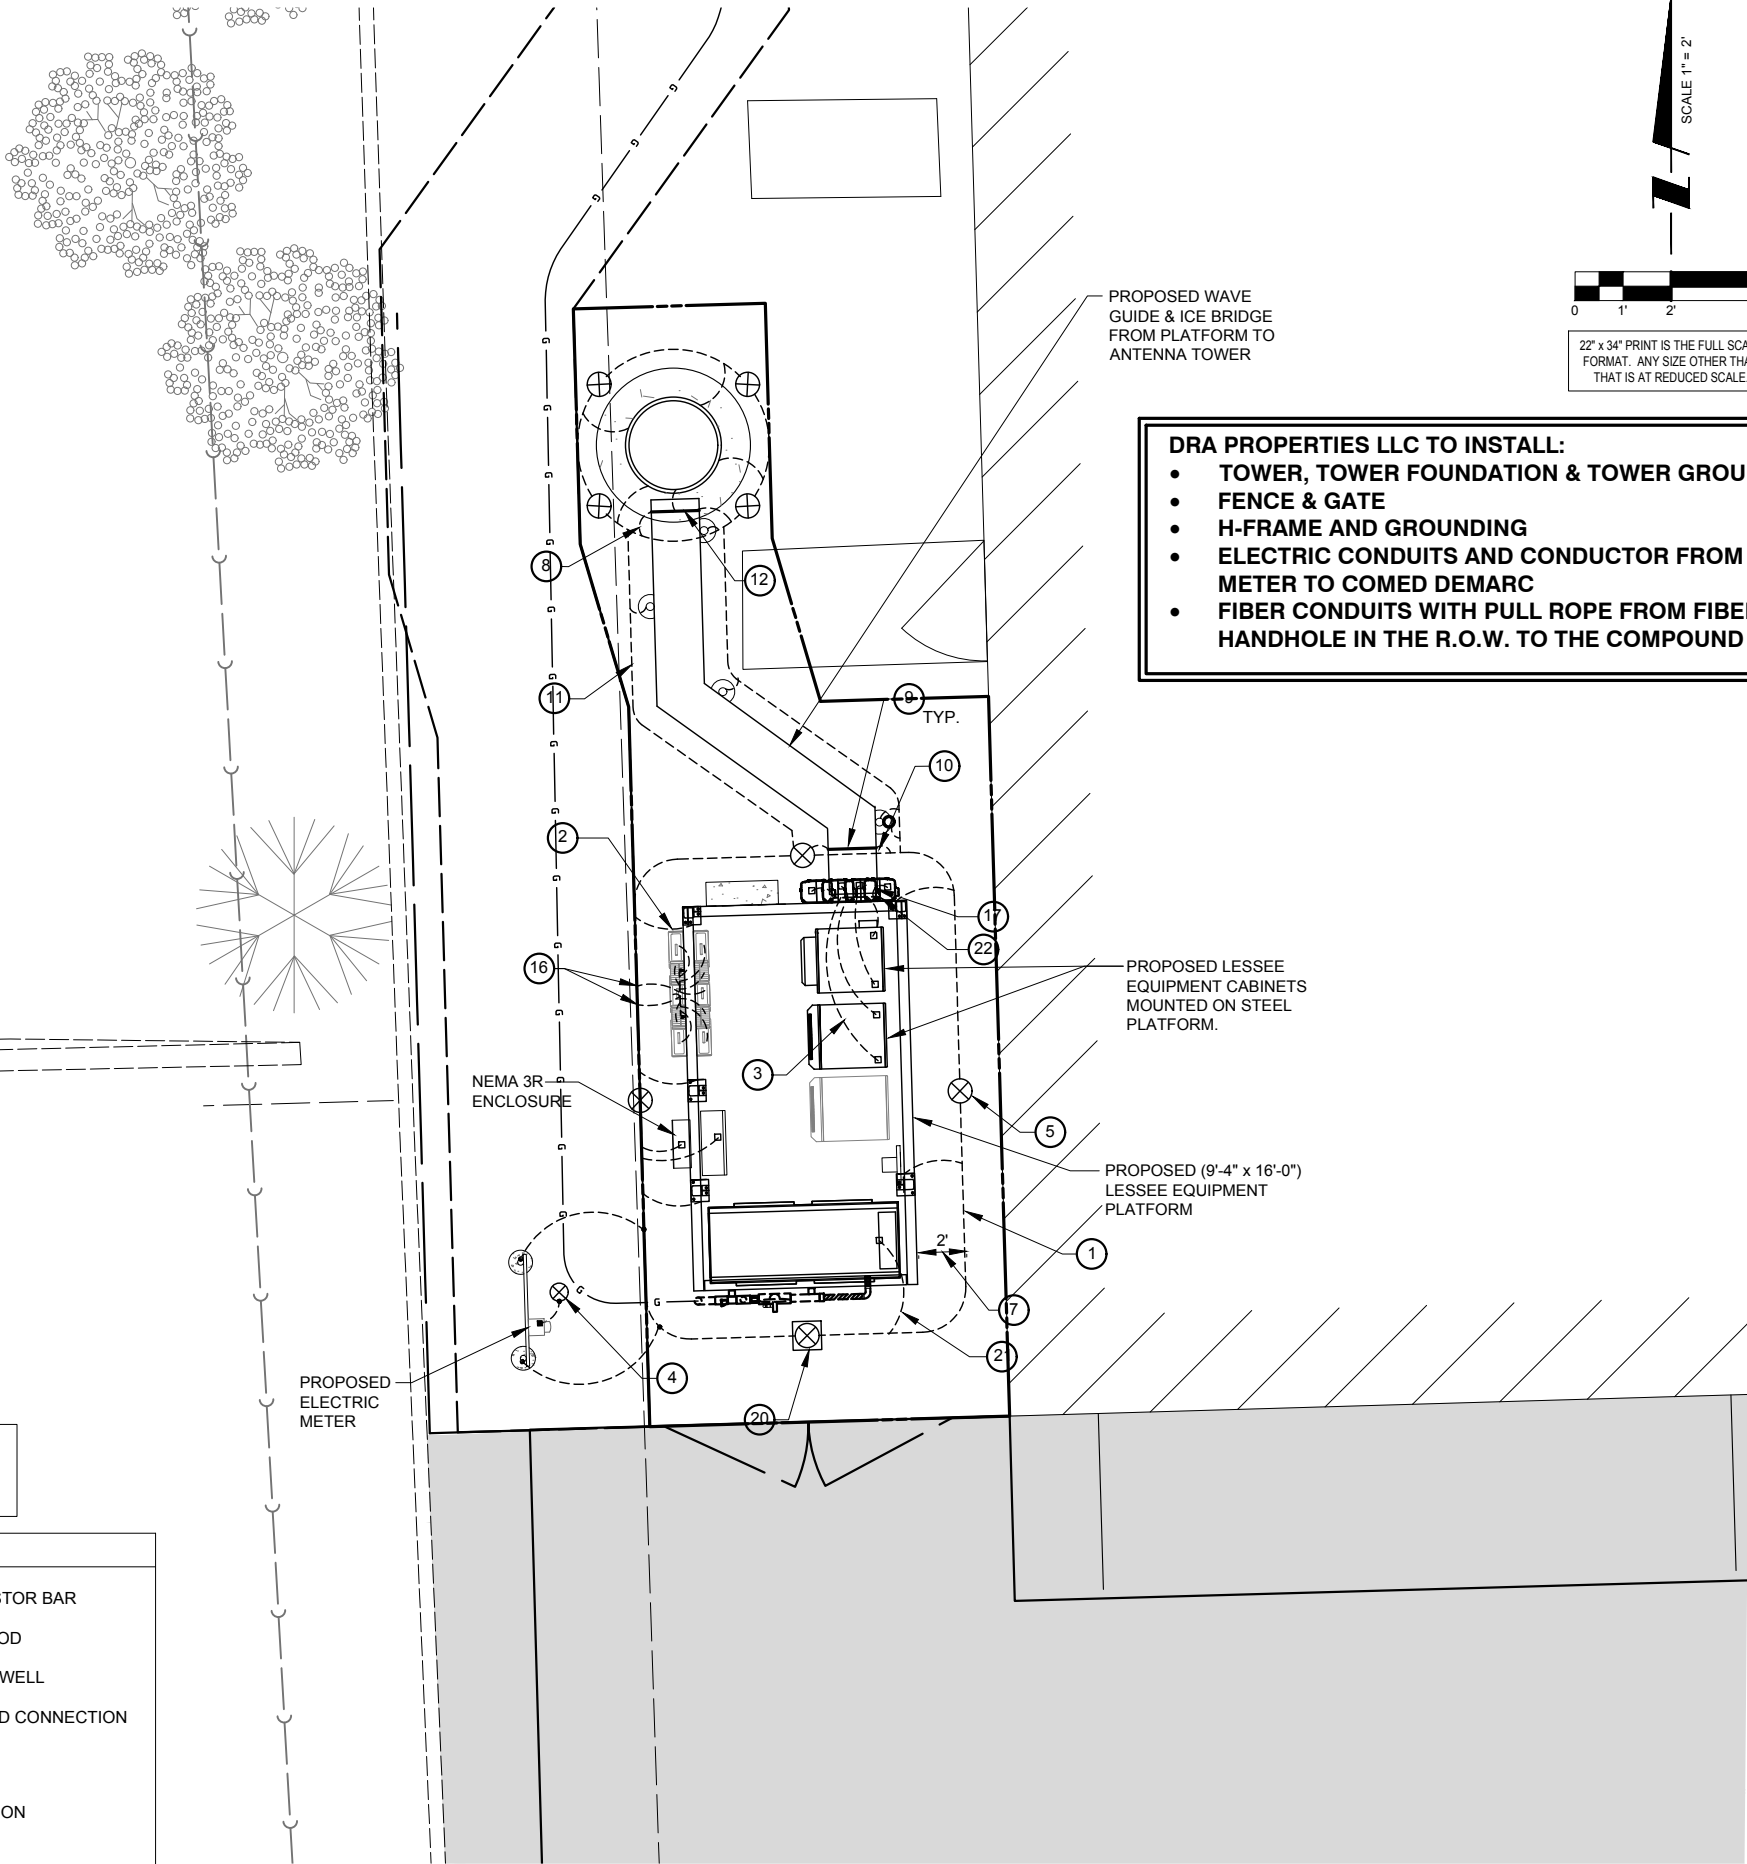

1 SITE GROUNDING PLAN
SCALE: 1" = 2'

DRA PROPERTIES LLC TO INSTALL:

- TOWER, TOWER FOUNDATION & TOWER GROUND
- FENCE & GATE
- H-FRAME AND GROUNDING
- ELECTRIC CONDUITS AND CONDUCTOR FROM METER TO COMED DEMARC
- FIBER CONDUITS WITH PULL ROPE FROM FIBER HANDHOLE IN THE R.O.W. TO THE COMPOUND

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limited partnership
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NO.	DESCRIPTION	DATE	BY	DMS	JTM	DMS	RA	JTM	DMS	JTM
3	FINAL PENDING FIBER	08/21/17								
4	UPDATE WITH NEW EGR	08/31/17								
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8	UPDATE PER GAS COORDINATION	01/31/18								
9	REVISED LANDSCAPE PLAN PER VILLAGE	04/05/18								

LOC. # 311466

W 151ST
& S 80TH

15100 S 80TH AVE
ORLAND PARK, IL 60462

DRAWN BY:	PP
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SHEET TITLE
SITE
GROUNDING PLAN

SHEET NUMBER




E-2

NOTE:
ANTENNA CABLES SHALL BE
GROUNDED AT THE
ANTENNA HEIGHT OF TOWER

NOTE:
ALL CABINET GROUND
CONNECTION BY OTHERS.

APPROVED UL LISTED GROUND CLAMPS

APPLICATION	UL LISTED HARGER PART #
METAL FLANGE	213, 213T, 213TTP
PIPE MEMBER	CPC SERIES (SIZED TO FIT DIAMETER OF PIPE)
LARGER PIPE MEMBER	UPC SERIES (UNIVERSAL PIPE CLAMP) SIZED TO FIT DIAMETER OF PIPE

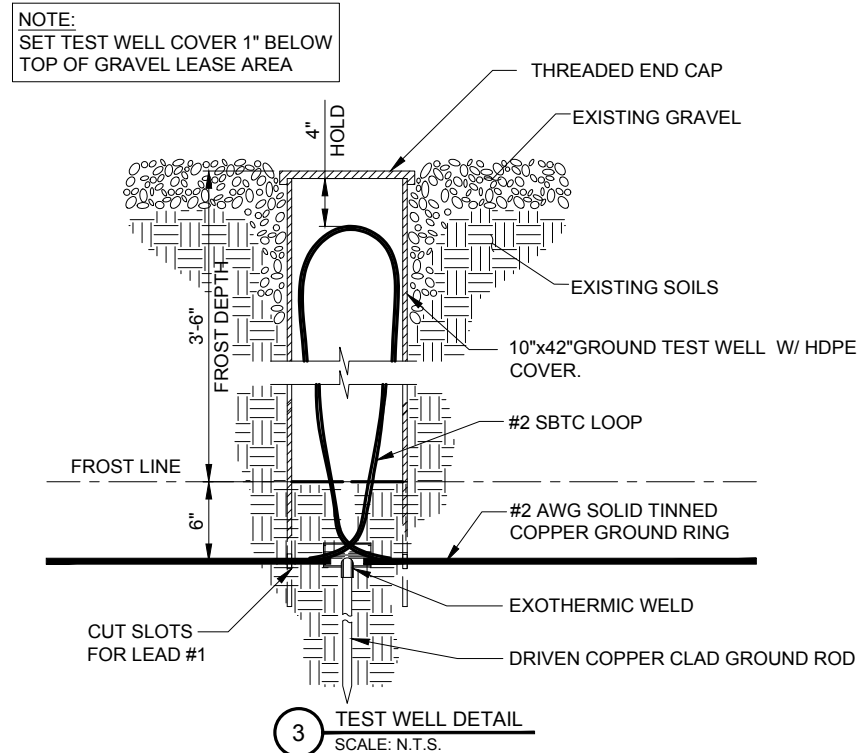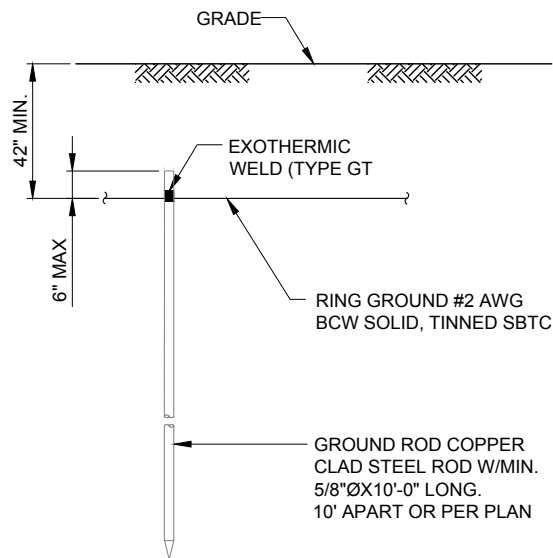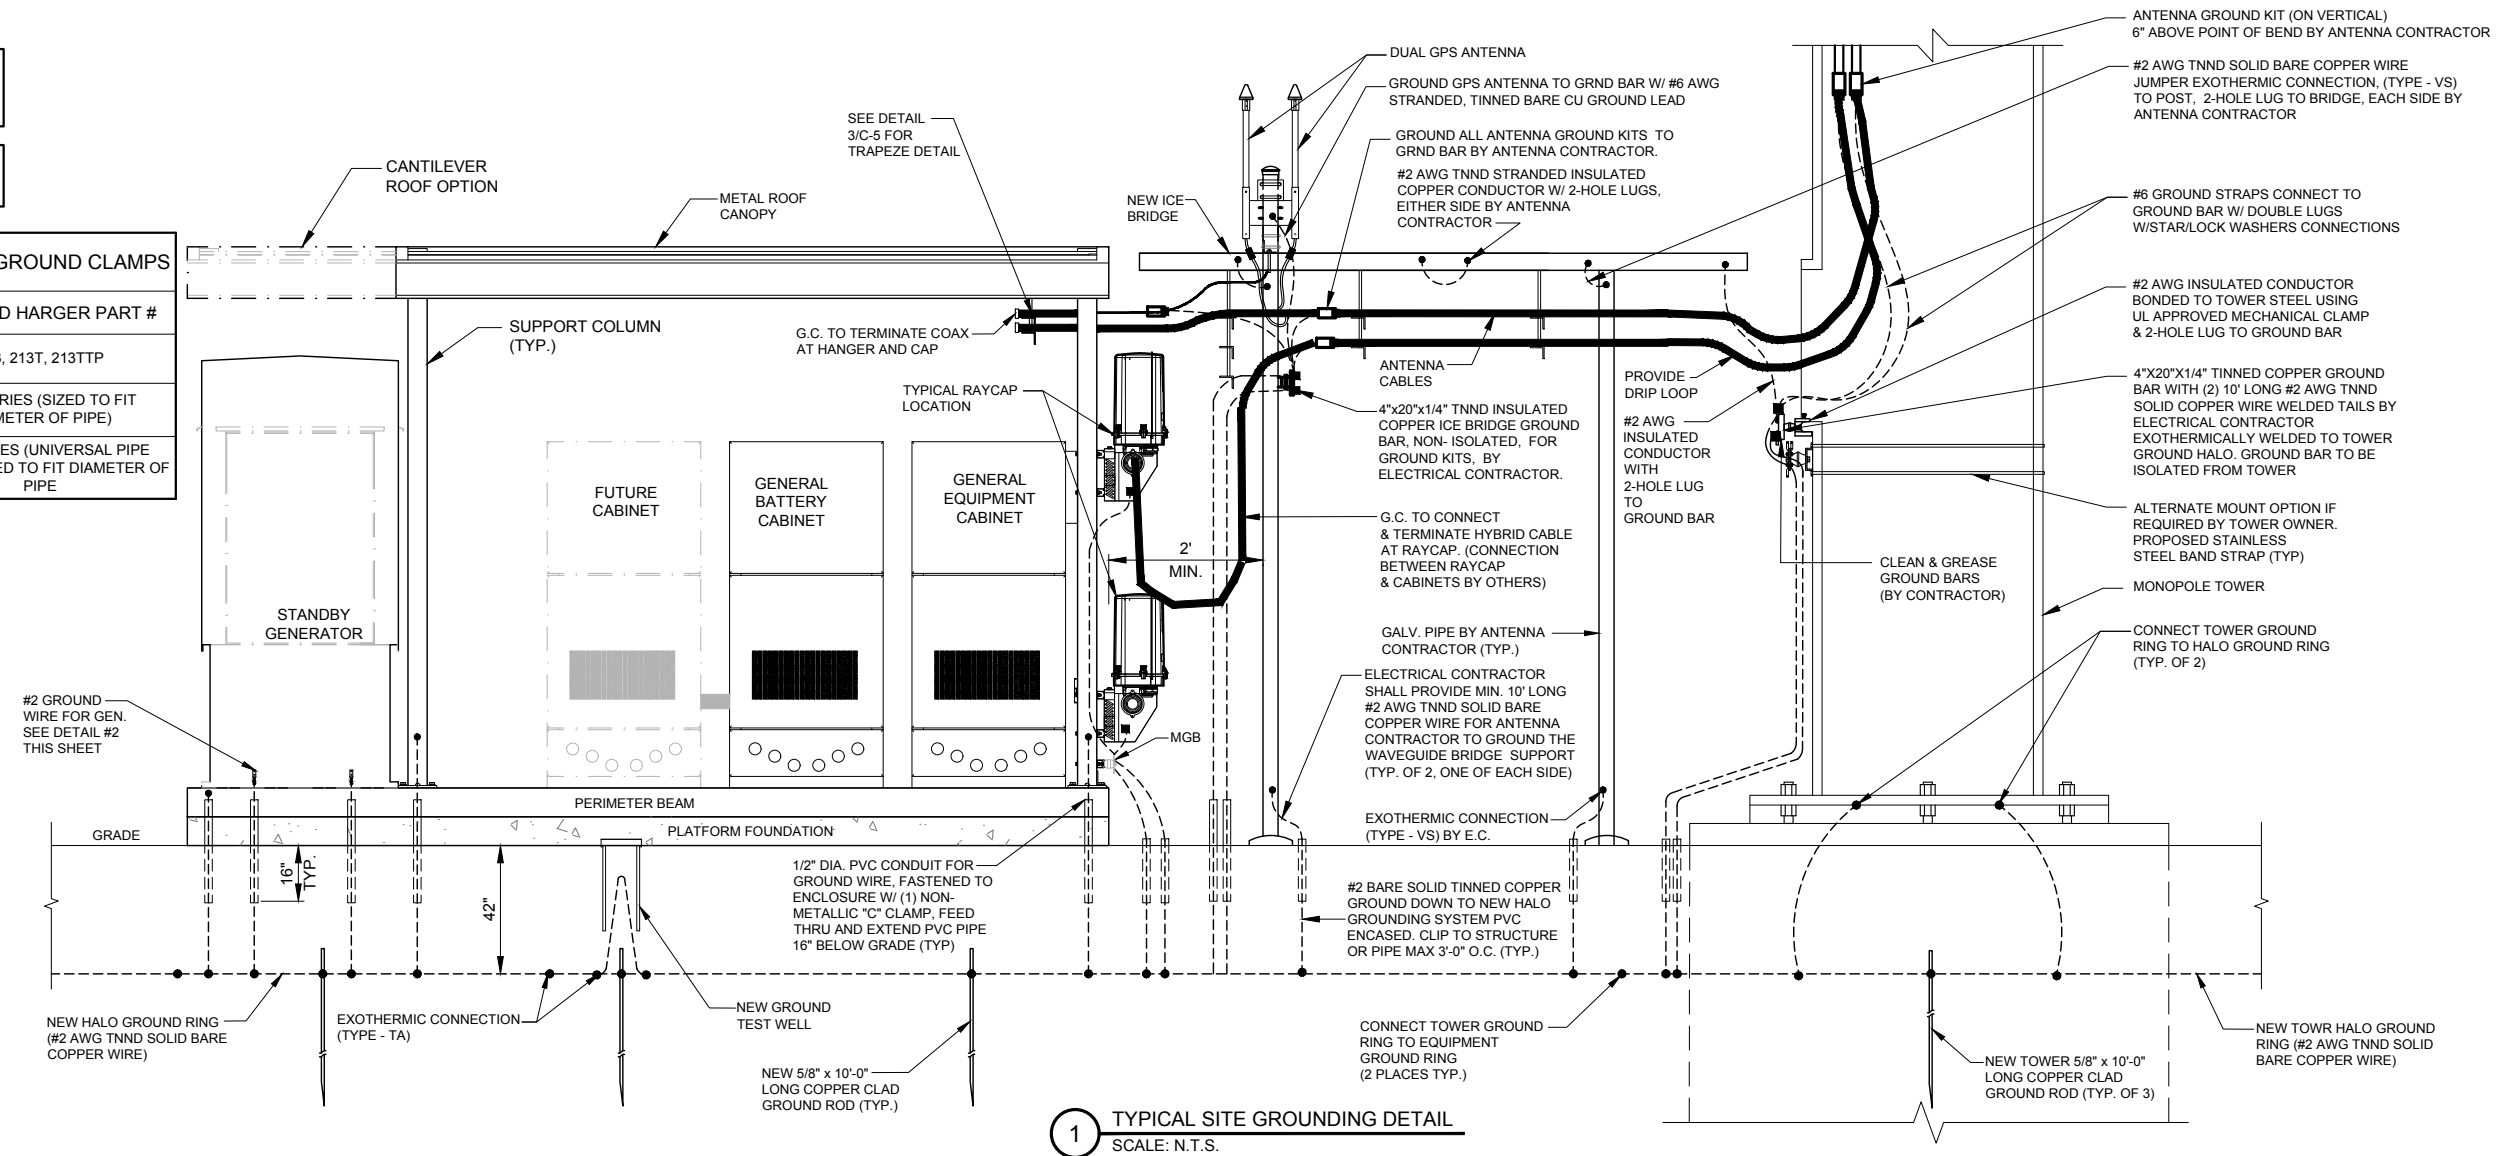

**CHICAGO
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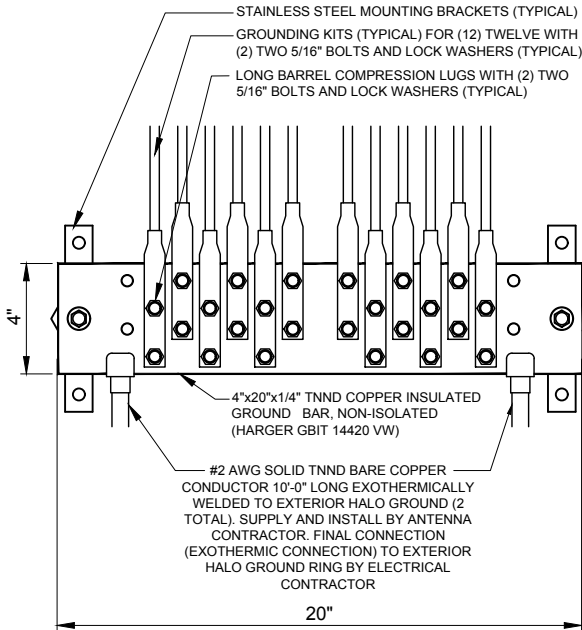
SHEET TITLE
GROUNDING DETAILS

SHEET NUMBER

E-3


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3. ALL ELECTRICAL & MECHANICAL GROUND CONNECTIONS SHALL HAVE ANTI-OXIDANT COMPOUND APPLIED TO CONNECTION
4. FENCE/GATE: GROUND FENCE POSTS WITHIN 6 FEET OF ENCLOSURE AND 25 FEET OF TOWER AS INDICATED ON DRAWINGS. GROUND EACH GATE POST AND CORNER POST. GROUND CONNECTIONS TO FENCE POSTS SHALL BE MADE BY THE EXOTHERMIC PROCESS AND INSTALLED PER MANUFACTURER'S RECOMMENDATIONS AND PROCEDURES. ALL OTHER CONNECTIONS FOR THE GROUND GRID SYSTEM SHALL BE MADE BY THE EXOTHERMIC PROCESS, AND INSTALLED PER MANUFACTURER'S RECOMMENDATIONS AND PROCEDURES.
5. AFTER INSTALLATION OF THE CANOPY AT THE DOOR, GC/EC IS TO BOND THE CANOPY TO THE DOOR FRAME WITH A #2 CONDUCTOR. USE DOUBLE-LUG CONNECTION. PREP AND PAINT SURFACE TO MATCH AFTER INSTALLATION.
6. UTILITY COMPANY COORDINATION: ELECTRICAL CONTRACTOR SHALL CONFIRM THAT ALL WORK IS IN ACCORDANCE WITH THE RULES OF THE LOCAL UTILITY COMPANY BEFORE SUBMITTING THE BID, THE CONTRACTOR SHALL CHECK WITH THE UTILITY COMPANIES SUPPLYING SERVICE TO THIS PROJECT AND SHALL DETERMINE FROM THEM ALL EQUIPMENT AND CHARGES WHICH THEY WILL REQUIRE AND SHALL INCLUDE THE COST IN THE BID.
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8. CONTRACTOR SHALL SUBMIT THE GROUND RESISTANCE TEST REPORT AS FOLLOWS:
 1. ONE (1) COPY TO OWNER REPRESENTATIVE
 2. ONE (1) COPY TO ENGINEER
 3. ONE (1) COPY TO KEEP INSIDE EQUIPMENT ENCLOSURE



1 EXTERIOR GROUND BAR DETAIL
N.T.S.

- NOTES:
1. ALL HARDWARE 18-8 STAINLESS STEEL INCLUDING BELLEVILLES. COAT ALL SURFACES WITH KOPR-SHIELD BEFORE MATING.
 2. FOR GROUND BOND TO STEEL ONLY: INSERT A DRAGON TOOTH WASHER BETWEEN LUG AND STEEL, COAT ALL SURFACES WITH KOPR-SHIELD.
 3. GROUND BARS, INSTALL BOLT HEAD TOWARD WALL
 4. ENCLOSURES, INSTALL BOLT HEAD ON OUTSIDE OF ENCLOSURE

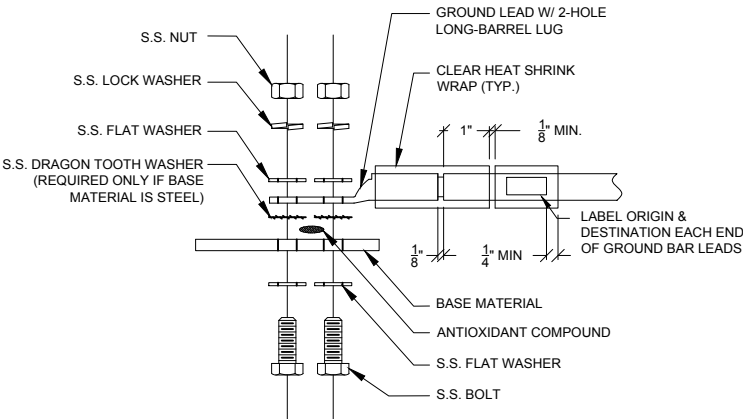

2 GROUND LUG INSTALLATION DETAIL
N.T.S.



Type GT
THROUGH CABLE TO
TOP OF GROUND ROD.



Type TA
TEE OF HORIZONTAL RUN
AND TAP CABLES.



Type HS
HORIZONTAL CABLE TAP TO
HORIZONTAL STEEL SURFACE
OR PIPE. CABLE OFF SURFACE.



Type VV
THROUGH VERTICAL CABLE TO
VERTICAL STEEL SURFACE OR
TO THE SIDE OF EITHER
HORIZONTAL OR VERTICAL
PIPE



Type XB
CROSS OF HORIZONTAL
CABLES. LAPPED AND NOT
CUT



Type VN
HORIZONTAL CABLE TAP TO
VERTICAL STEEL SURFACE OR
THE SIDE OF HORIZONTAL PIPE



Type VS
CABLE TAP DOWN AT 45° TO
VERTICAL STEEL SURFACE OR SIDE
OF HORIZONTAL OR VERTICAL PIPE.



Type GY
THROUGH CABLE TO SIDE
OF GROUND ROD



Type GR
CABLE TAP TO TOP OF GROUND
ROD



Type NC
THROUGH AND TAP CABLES
TO GROUND ROD

3

EXOTHERMIC WELD DETAILS

EXOTHERMIC AND HARGER ULTRAWELD OR APPROVED EQUAL

CHICAGO
SMSA
limited partnership
d/b/a VERIZON WIRELESS



REVISIONS

NO.	DESCRIPTION	DATE	BY
3	FINAL PENDING FIBER	08/21/17	DMS
4	UPDATE WITH NEW ECR	08/31/17	JTM
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7	ADDITION OF LANDSCAPING PLAN	12/29/17	JTM
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9	REVISED LANDSCAPE PLAN PER VILLAGE	04/05/18	JTM

LOC. # 311466

W 151ST
& S 80TH

15100 S 80TH AVE
ORLAND PARK, IL 60462

DRAWN BY:	PP
CHECKED BY:	TAZ
DATE:	07/23/15
PROJECT #:	33-1466

SHEET TITLE
GROUNDING DETAILS

SHEET NUMBER
E-4

DIVISION 5: METALS

PART1 1 - GENERAL

1. SECTION INCLUDES:
STRUCTURAL STEEL FRAMING MEMBERS, BASE PLATES, PLATES, BARS, AND GROUTING UNDER BASE PLATES.
2. SUBMITTALS:
SHOP DRAWINGS: INDICATE SIZES, SPACING, AND LOCATIONS OF STRUCTURAL MEMBERS, OPENINGS, CONNECTIONS, CAMBERS, LOADS, AND WELDED SECTIONS.
3. QUALITY ASSURANCE
 - A. FABRICATE STRUCTURAL STEEL MEMBERS IN ACCORDANCE WITH AISC SPECIFICATIONS FOR THE DESIGN, FABRICATION AND ERECTION OF STRUCTURAL STEEL FOR BUILDINGS.
 - B. PERFORM DESIGN UNDER DIRECT SUPERVISION OF A PROFESSIONAL STRUCTURAL ENGINEER LICENSED IN THE STATE.

PART 2 - PRODUCTS

- | | |
|--|---|
| 1. MATERIALS: | |
| A. STRUCTURAL STEEL MEMBERS: | ASTM A572, GRADE 50 |
| B. STRUCTURAL TUBING: | ASTM A500, GRADE B |
| C. PIPE: | ASTM A53, TYPE E OR S, GRADE B |
| D. BOLTS, NUTS, AND WASHERS: | ASTM A325 |
| E. ANCHOR BOLTS: | ASTM A307 |
| F. WELDING MATERIALS: | AWS 01.1, TYPE REQUIRED FOR
MATERIALS BEING WELDED |
| G. GROUT: | NON - SHRINK TYPE, PREMIXED
COMPOUND CONSISTING OF NONMETALLIC AGGREGATE,
CEMENT, WATER REDUCING AND PLASTICIZING ADDITIVES,
CAPABLE OF DEVELOPING A MINIMUM COMPRESSIVE
STRENGTH OF 7000 PSI AT 28 DAYS. |
| H. SHOP AND TOUCH-UP PRIMER: | SSPC 15, TYPE 1, RED OXIDE |
| I. TOUCH-UP PRIMER
FOR GALV. SURFACES | ZINC RICH TYPE |

2. FABRICATION:
CONTINUOUSLY SEAL JOINTED MEMBERS BY CONTINUOUS WELDS. GRIND EXPOSED WELDS SMOOTH.
3. FINISH:
 - A. PREPARE STRUCTURAL COMPONENT SURFACES IN ACCORDANCE WITH SSPC SP-1 TO SP-10 PROCEDURES.
 - B. STRUCTURAL STEEL MEMBERS SHALL BE HOT DIPPED GALVANIZED.

PART 3 - EXECUTION

1. EXAMINATION AND PREPARATION:
VERIFY THAT THE FIELD CONDITIONS ARE ACCEPTABLE.
2. ERECTION:
 - A. ALLOW FOR ERECTION LOADS. PROVIDE TEMPORARY BRACING TO MAINTAIN FRAMING IN ALIGNMENT UNTIL COMPLETION OF ERECTION AND INSTALLATION OF PERMANENT BRIDGING AND BRACING.
 - B. FIELD WELD COMPONENTS INDICATED ON SHOP DRAWINGS.
 - C. DO NOT FIELD CUT OR ALTER STRUCTURAL MEMBERS WITHOUT APPROVAL OF THE ARCHITECT/ENGINEER.
 - D. AFTER ERECTION, TOUCH-UP WELDS, ABRASIONS, AND SURFACES NOT SHOP PRIMED OR GALVANIZED WITH TOUCH-UP PRIMERS AS SPECIFIED UNDER SECTION 05000, 05METALS, PART 2 - PRODUCTS, H & I. SURFACES TO BE IN CONTACT WITH CONCRETE NOT INCLUDED.
3. FIELD QUALITY CONTROL:
FIELD INSPECTION OF MEMBERS, CONNECTIONS, WELDS, AND TOURING

DIVISION 16: ELECTRICAL

SECTION 16050 - BASIC ELECTRICAL MATERIALS AND METHODS

1. CONTRACTOR SHALL REVIEW THE CONTRACT DOCUMENTS PRIOR TO ORDERING THE ELECTRICAL EQUIPMENT AND STARTING THE ACTUAL CONSTRUCTION. CONTRACTOR SHALL ISSUE A WRITTEN NOTICE OF ALL FINDINGS TO THE ARCHITECT LISTING ANY DISCREPANCIES OR CONFLICTING INFORMATION.
2. ELECTRICAL PLANS, DETAILS AND DIAGRAMS ARE DIAGRAMMATIC ONLY. VERIFY EXACT LOCATIONS AND MOUNTING HEIGHTS OF ELECTRICAL EQUIPMENT WITH OWNER PRIOR TO INSTALLATION.
3. EACH CONDUCTOR OF EVERY SYSTEM SHALL BE PERMANENTLY TAGGED IN EACH PANELBOARD, PULLBOX, JUNCTION BOX, SWITCH BOX, ETC. THE TYPE OF TAGGING METHODS SHALL BE IN COMPLIANCE WITH OCCUPATIONAL SAFETY AND HEALTH ADMINISTRATION (O.S.H.A).
4. ALL MATERIALS AND EQUIPMENT SHALL BE NEW AND IN GOOD WORKING CONDITION WHEN INSTALLED AND SHALL BE OF THE BEST GRADE AND OF THE SAME MANUFACTURER THROUGHOUT FOR EACH CLASS OR GROUP OF EQUIPMENT. MATERIALS SHALL BE LISTED "J" WHERE APPLICABLE. MATERIALS SHALL MEET WITH APPROVAL OF ALL GOVERNING BODIES HAVING JURISDICTION. MATERIALS SHALL BE MANUFACTURED IN ACCORDANCE WITH APPLICABLE STANDARDS ESTABLISHED BY ANSI, NEMA, NBFU, AND "UL" LISTED.
5. ALL CONDUIT SHALL HAVE A PULL CORD.
6. PROVIDE PROJECT MANAGER WITH ONE SET OF COMPLETE ELECTRICAL "AS INSTALLED" DRAWINGS AT THE COMPLETION OF THE JOB, SHOWING ACTUAL DIMENSIONS, ROUTINGS, AND CIRCUITS.
7. ALL CIRCUIT BREAKERS, FUSES AND ELECTRICAL EQUIPMENT SHALL HAVE AN INTERRUPTING SHORT CIRCUIT CURRENT TO WHICH THEY MAY BE SUBJECTED, AND A MINIMUM OF 10,000 A.I.C.
8. THE ENTIRE ELECTRICAL INSTALLATION SHALL BE GROUNDED AS REQUIRED BY UBC, NEC AND ALL APPLICABLE CODES.
9. PATCH, REPAIR AND PAINT ANY AREA THAT HAS BEEN DAMAGED IN THE COURSE OF THE ELECTRICAL WORK.
10. PLASTIC PLATES FOR ALL SWITCHES, RECEPTACLES, TELEPHONE AND BLANKED OUTLETS SHALL HAVE ENGRAVED LETTERING WHERE INDICATED ON THE DRAWINGS. WEATHERPROOF RECEPTACLES SHALL HAVE SIERRA #WPD-8 LIFT COVERPLATES.

SECTION 1640 - SERVICE AND DISTRIBUTION

- WIRE AND CABLE CONDUCTORS SHALL BE COPPER, 600V, TYPE THHN OR THWN, WITH A MINIMUM OF #12 AWG, COLOR CODED. ALL RECTIFIER DROPS SHALL BE STRANDED TO ACCEPT CRIMP CONNECTORS.
2. ALL CHEMICAL GROUND RODS SHALL BE "UL" APPROVED.
3. METER SOCKET AMPERES, VOLTAGE, NUMBER OF PHASES SHALL BE AS NOTED ON THE DRAWINGS. MANUFACTURED BY MILBANK OR APPROVED EQUAL, AND SHALL BE UTILITY COMPANY APPROVED.
4. CONDUIT:
- A. RIGID CONDUIT SHALL BE U.L. LABEL GALVANIZED ZINC COATED WITH GALVANIZED ZINC INTERIOR AND SHALL BE USED WHEN INSTALLED IN OR UNDER CONCRETE SLABS, IN CONTACT WITH THE EARTH, UNDER PUBLIC ROADWAYS, IN MASONRY WALLS OR EXPOSED ON BUILDING EXTERIOR. RIGID CONDUIT IN CONTACT WITH EARTH SHALL BE ½ LAPPED WRAPPED WITH HUNTS WRAP PROCESS NO. 3.
- B. ELECTRICAL METALLIC TUBING SHALL HAVE U.L. LABEL, FITTING SHALL BE GLAND RING COMPRESSION TYPE.
- C. FLEXIBLE METALLIC CONDUIT SHALL HAVE U.L. LISTED LABEL AND MAY BE USED WHERE PERMITTED BY CODE. FITTINGS SHALL BE "JAKE" OR SQUEEZE" TYPE. ALL FLEXIBLE CONDUITS SHALL HAVE FULL LENGTH GROUND WIRE.
- D. ALL UNDERGROUND CONDUIT SHALL BE AS NOTED ON THE DRAWINGS AT A MINIMUM DEPTH OF 42" BELOW GRADE. IT IS REQUIRED AND WILL BE THE RESPONSIBILITY OF THE ELECTRICAL CONTRACTOR TO NOTIFY J.U.L.I.E. AT 1-800-892-0123 OR OTHER SUCH NOTIFYING AGENCY FORTY-EIGHT (48) HOURS PRIOR TO DIGGING.
5. CONTRACTOR TO COORDINATE WITH UTILITY COMPANY FOR CONNECTION OF TEMPORARY AND PERMANENT POWER TO THE SITE. THE TEMPORARY POWER AND ALL HOOKUP COSTS ARE TO BE PAID BY THE CONTRACTOR.
6. ALL ELECTRICAL EQUIPMENT SHALL BE LABELED WITH PERMANENT ENGRAVED PLASTIC LABELS WITH WHITE ON BLUE BACKGROUND LETTERING (MINIMUM LETTER HEIGHT SHALL BE ONE FORTH INCH (1/4"). NAMEPLATES SHALL BE FASTENED WITH STAINLESS STEEL SCREWS, NOT ADHESIVE.
7. UPON COMPLETION OF WORK, CONDUCT CONTINUITY, SHORT CIRCUIT, AND FALL POTENTIAL GROUNDING TESTS BY AN INDEPENDENT TESTING SERVICE ENGAGED BY THE CONTRACTOR SHALL BE SUBMITTED FOR APPROVAL. SUBMIT TEST REPORTS TO PROJECT MANAGER. CLEAN PREMISES OF ALL DEBRIS RESULTING FROM WORK AND LEAVE WORK IN A COMPLETE AND UNDAMAGED CONDITION.
8. GROUNDING ELECTRODE SYSTEM
- A. PREPARATION
1. SURFACE PREPARATION:
- ALL CONNECTIONS SHALL BE MADE TO BARE METAL. ALL PAINTS SURFACES SHALL BE FIELD INSPECTED AND MODIFIED TO ENSURE PROPER CONTACT. NO WASHERS ARE ALLOWED BETWEEN THE ITEMS BEING GROUND. ALL CONNECTIONS ARE TO HAVE A NO-OXIDIZING GENT APPLIED PRIOR TO INSTALLATION.
2. GROUND BAR PREPARATION
- ALL COPPER GROUND BARS SHALL BE CLEANED, POLISHED AND A NON-OXIDIZING AGENT APPLIED. NO FINGERPRINTS OR DISCOLORED COPPER WILL BE PERMITTED.
3. SLEEVES:
- ALL GROUNDING CONDUCTORS SHALL RUN THROUGH PVC SLEEVES WHEREVER CONDUCTORS RUN THROUGH WALLS, FLOORS OR CEILINGS. IF CONDUCTORS MUST RUN THROUGH EMT, BOTH ENDS OF CONDUIT SHALL BE GROUNDED. SEAL BOTH ENDS OF CONDUIT WITH SILICONE CAULK.
- B. GROUND BARS
1. ALL GROUND BARS SHALL BE ONE FORTH INCH (1/4" THICK TINNED COPPER PLATE AND OF AND OF SIZE INDICATED ON DRAWINGS.
2. ALL CONNECTIONS TO THE GROUND BAR SHALL OBSERVE THE FOLLOWING SEQUENCE:
- A. BOLT-HEAD
- B. 2-HOLE LUG
- C. TINNED COPPER BUSS BAR
- D. STAR WASHER
- E. NUT
- C. EXTERNAL CONNECTIONS
1. ALL BURIED GROUNDING CONNECTIONS SHALL BE MADE BY THE EXOTHERMIC WELD PROCESS. CONNECTIONS SHALL INCLUDE ALL CABLE TO CABLE, SPICES, TEE'S, CROSSES, ETC. ALL CABLE TO GROUND RODS, GROUND ROD SPICES AND LIGHTNING PROTECTION SYSTEMS ARE TO BE AS INDICATED. ALL MATERIALS USED (MOLDS, WELDING METAL, TOOLS, ETC.) SHALL BE BY "CADWELD" AND INSTALLED PER MANUFACTURER'S RECOMMENDED PROCEDURES.
2. ALL ABOVE GRADE GROUNDING AND BONDING CONDUCTORS SHALL BE CONNECTED BY TWO HOLE CRIMP TYPE (COMPRESSION) CONNECTIONS (EXCEPT FOR THE ACEG AND GROUND ROD) MECHANICAL CONNECTIONS, FITTINGS OR CONNECTIONS THAT DEPEND SOLELY ON SOLDIER SHALL NOT BE USED. ALL CABLE TO CABLE CONNECTIONS SHALL BE HIGH PRESSURE DOUBLE CRIMP TYPE CONNECTIONS. CONNECTIONS TO STRUCTURAL STEEL SHALL BE EXOTHERMIC WELDS.
- D. GROUND RODS
- ALL GROUND RODS SHALL BE 5/8 -INCH DIAMETER X 10' -0" LONG "COPPERWELD" OR APPROVED EQUAL, OF THE NUMBER AND LOCATIONS INDICATED. GROUND RODS SHALL BE DRIVEN FULL LENGTH VERTICAL IN UNDISTURBED EARTH.
- E. GROUND RODS
- ALL GROUND RODS SHALL BE STANDARD TINNED SOLID BARE COPPER ANNEALED, AND OF SIZE INDICATED ON DRAWINGS UNLESS NOTED OTHERWISE.

- F. LUGS
1. LUGS SHALL BE 2 - HOLE, LONG BARREL, STRAND COPPER UNLESS OTHERWISE SPECIFIED IN THE CONTRACT DOCUMENTS. LUGS SHALL BE THOMAS AND BETTS SERIES #548__BE OR EQUIVALENT
- | | |
|-----------------------|---------|
| A. 535 MCM DLO | 54880BE |
| B. 262 MCM DLO | 54872BE |
| C. #1/0 DLO | 54862BE |
| D. #4/0 THWN AND BARE | 54866BE |
| E. #2/0 THWN | 54862BE |
| F. #2 THHN | 54207BE |
| G. #6 DLO | 54205BE |

2. WHEN THE DIRECTION OF THE CONDUCTOR MUST CHANGE, IT SHALL BE DONE GRADUALLY. THE CURVATURE OF THE TURN SHALL BE DONE IN ACCORDANCE WITH THE FOLLOWING CHART:

	<u>GROUNDING CONDUCTOR SIZE</u>	<u>MINIMUM BENDING RADIUS TO INSIDE EDGE</u>
NO.	6 AWG TO NO. 4 AWG	6 INCHES
NO.	2 AWG TO NO. 1/0 AWG	8 INCHES
NO.	2/0 AWG TO 4/0 MCM	12 INCHES
	250 MCM TO 750 MCM	24 INCHES

G. GROUND RING

1. THE EXTERNAL GROUND RING ENCIRCLING THE TOWER (IF APPLICABLE) AND BETWEEN BETWEEN THE EQUIPMENT SHELTER PLATFORM ANCHORS SHALL BE MINIMUM NO. 2 A.W.G SOLID TINNED BARE COPPER CONDUCTOR IN DIRECT CONTACT WITH THE EARTH AT THE DEPTH INDICATED ON THE DRAWINGS. CONDUCTOR BENDS SHALL HAVE A MINIMUM BENDING RADIUS OF EIGHT INCHES (8").
 2. ALL EXTERNAL GROUND RINGS ARE TO BE JOINED TOGETHER AND ALL CONNECTIONS MUST BE CADWELDED. NO LUNGS OR CLAMPS WILL BE ACCEPTED.
- H. FENCE/GATE
- GROUND EACH GATE POST, CORNER POST AND GATE AS INDICATED ON DRAWING GROUND CONNECTIONS TO FENCE POST AND ALL OTHER CONNECTIONS FOR THE GROUND GRID SYSTEM SHALL BE MADE BY EXOTHERMIC WELD PROCESS, AND INSTALLED PER MANUFACTURER'S RECOMMENDATIONS AND PROCEDURES, AND SPRAYED WITH COLD-GALVANIZED PAINT.
3. I.E.E.E. FALL POTENTIAL TESTS

3. I.E.E.E. FALL POTENTIAL TESTS

- A. FOR RAW LAND SITE
1. GROUND TESTS SHALL BE PERFORMED AS INDICATED ON DRAWINGS. A BIDDLE GROUND OHMER OR THE METHOD OF USING TWO AUXILIARY GROUND RODS (AS DESCRIBED IN I.E.E.E. STANDARDS NO. 81-1983, PART 1) MAY BE USED. THE I.E.E.E. METHOD REQUIRES THE USE OF AN A.C. TEST CURRENT. THE AUXILIARY TEST RODS MUST BE SUFFICIENTLY FAR AWAY FROM THE ROD UNDER TEST SO THAT THE REGIONS IN WHICH THEIR RESISTANCE IS LOCALIZED DO NOT OVERLAP. THE TEST POINT WILL BE GROUND ROD AND WILL CONSIST OF THE THREE POINT FALL OF POTENTIAL MEGGER TEST METHOD, USING THE BIDDLE NULL-BALANCE EARTH TESTER (MEGGER #25020-2 OR EQUIVALENT)
 2. CONTRACTOR TO CONDUCT GROUND RESISTANCE TEST IN THE FORMAT AS FOLLOWS:
 - B. EQUIPMENT PAD
 1. FIRST TEST - SHALL BE WITH FOUR GROUND RODS INSTALLED, ONE AT EACH CORNER OF THE PAD BUT NOT CONNECTED TO THE MAIN GROUNDING BUS. FURNISH WIRE TO CONNECT (TEMPORARY CLAMP) ALL FOUR GROUND RODS TOGETHER TO MAKE A SYSTEM TEST AFTER EACH ROD IS INDIVIDUALLY TESTED. IF ANY INDIVIDUAL ROD TESTS 35 OHMS OR MORE, THE ELECTRICAL CONTRACTOR AND OWNER'S REPRESENTATIVE SHOULD BE NOTIFIED SO THAT THE ROD CAN BE DRIVEN DEEPER UNTIL ALL FOUR RODS HAVE A RESISTANCE OF 10 OHMS OR LESS ON A DRY DAY.
 2. SECOND TEST- SHALL BE WITH THE GROUND RODS CONNECTED, WITH DRY SOIL AND WHEN NO STANDING WATER HAS BEEN PRESENT FOR THE PAST TEN (10) DAYS. THE MAXIMUM ALLOWABLE READING IS 5 OHMS TO GROUND. IF THE RESISTANCE OF THE ENTIRE SYSTEM EXCEEDS 5 OHMS, NOTIFY THE CONTRACTOR AND OWNER'S REPRESENTATIVE SO THAT ADDITIONAL AND/OR DEEPER RODS CAN BE INSTALLED.

C. TOWER

1. FIRST TEST - SHALL BE WITH THREE GROUND RODS INSTALLED (MINIMUM), EQUALLY SPACED AROUND THE TOWER FOUNDATION, BUT NOT CONNECTED TO THE SHELTER PAD EXTERNAL GROUND RING. FURNISH WIRE TO CONNECT (TEMPORARY CLAMP) ALL THREE GROUND RODS TOGETHER TO MAKE A SYSTEM TEST AFTER EACH ROD IS INDIVIDUALLY TESTED. IF ANY INDIVIDUAL ROD TESTS 25 OHMS OR MORE, NOTIFY THE CONTRACTOR AND OWNER'S REPRESENTATIVE SO THAT THE ROD CAN BE DRIVEN DEEPER UNTIL ALL THREE (3) RODS HAVE A RESISTANCE OF 10 OHMS OR LESS ON A DRY DAY.
 2. SECOND TEST - SHALL BE WITH THE GROUND RODS CONNECTED, WITH DRY SOIL AND WHEN NO STANDING WATER HAS BEEN PRESENT FOR THE PAST (10) DAYS, THE MAXIMUM ALLOWABLE READING IS 5 OHMS THE ELECTRICAL CONTRACTOR AND OWNER'S REPRESENTATIVE SHOULD BE NOTIFIED SO THAT EITHER ADDITIONAL AND/OR DEEPER RODS CAN BE INSTALLED.
- D. EQUIPMENT PAD AND TOWER
1. AFTER THE EQUIPMENT PAD AND TOWER GROUND RESISTANCE TEST IS COMPLETED, CONTRACTOR SHALL TIE THE EQUIPMENT PAD EXTERNAL GROUND RING AND TOWER EXTERNAL GROUND RING TOGETHER. AFTER FIRST AND SECOND TEST ALL CONNECTIONS MUST BE MADE USING EXOTHERMIC WELD. NO LUGS OR CLAMPS WILL BE ACCEPTED.
 2. AFTER ALL THE EXTERNAL GROUND RINGS ARE TIED TOGETHER, COMPLETE A MEGGER CHECKER OF THE GROUND SYSTEM SHOULD BE DONE. THE MAXIMUM ALLOWABLE LEADING IS 5 OHMS TO GROUND.

10. GROUNDING RESISTANCE TEST REPORT

UPON COMPLETION OF THE TESTING FOR EACH SITE, A TEST REPORT SHOWING RESISTANCE IN OHMS WITH AUXILIARY POTENTIAL ELECTRODES AT 5 FEET AND 10 FEET INTERVALS UNTIL THE AVERAGE RESISTANCE STARTS INCREASING AND ALSO NOTE THAT 10-15 PHOTOS MUST BE TAKEN TO PROOF ENTIRE EXTERNAL GROUND RING SYSTEM BEFORE BACKFILL. TWO (2) SETS OF TEST DOCUMENTS AREA OF THE INDEPENDENT TESTING SERVICE TO BE BOUND AND SUBMITTED WITHIN ONE (1) WEEK OF WORK COMPLETION.

SECTION 16503 - POLES, POSTS, AND STANDARDS
(SINGLE MAST AND SELF SUPPORTING TOWERS)

1. GENERAL
 - A. LIGHTNING ROD AND EXTENSION PIPE INCLUDING ALL APPURTENANCES, TO BE FURNISHED BY OWNER, IF REQUIRED
 - B. PROVIDE TEMPORARY LIGHTING FOR TOWER AS PER FAA REGULATIONS DURING CONSTRUCTION, IF REQUIRED.
 - C. GROUNDING:
GROUND TOWER WITH A MINIMUM OF #2 AWG TINNED SOLID BARE COPPER CONDUCTOR CADWELDED TO TOWER BASE PLATE. TWO (2) GROUNDING LEADS PER TOWER BASE PLATE.

NO EXOTHERMIC WELDS SHALL BE ATTACHED DIRECTLY TO THE MONOPOLE TOWER SHAFT

SECTION 16745- TELECOMMUNICATIONS WIRING COMPONENT
(COAXIAL ANTENNA CABLE)

- ## 1. GENERAL

- A. ALL MATERIALS, PRODUCTS OR PROCEDURES INCORPORATED INTO WORK SHALL BE NEW AND OF STANDARD COMMERCIAL QUALITY.
- B. CERTAIN MATERIALS AND PRODUCTS WILL BE SUPPLIED BY THE OWNER (REFER TO GENERAL CONDITIONS FOR THE LIST OF OWNER FURNISHED EQUIPMENT, MATERIALS AND SUPPLIES FOR THESE ITEMS). THE CONTRACTOR IS RESPONSIBLE FOR PICKUP AND DELIVERY OF ALL SUCH MATERIALS
- C. ALL OTHER MATERIALS AND PRODUCTS SPECIFIED IN THE CONTRACT DOCUMENTS SHALL BE SUPPLIED BY THE CONTRACTOR.

2. MATERIALS

- a. COAXIAL CABLE:
 1. INSTALL COAXIAL CABLE AND TERMINATIONS BETWEEN ANTENNAS AND EQUIPMENT PER MANUFACTURER'S RECOMMENDATIONS WITH COAXIAL CABLES SUPPORTED AT NO MORE THAN 3'-0" O.C. WEATHERPROOF ALL CONNECTORS BETWEEN THE ANTENNA AND EQUIPMENT PER MANUFACTURER'S REQUIREMENTS. TERMINATE ALL COAXIAL CABLE THREE FEET (3') IN EXCESS OF EQUIPMENT LOCATION UNLESS OTHERWISE STATED.
 2. ALL COAX RUN LENGTHS GREATER THAN 175 FEET SHALL BE 1-5/8", ALL COAX. RUN LENGTH BETWEEN 101 FEET AND 174 FEET SHALL BE 1-1/4", AND IN LENGTH LESS THAN OR EQUAL TO 100 FEET SHALL BE 7/8".
3. ANTENNA AND COAXIAL CABLE GROUNDING
 - a. ALL COAXIAL CABLE GROUNDING KITS ARE TO BE INSTALLED ON STRAIGHT RUNS OF COAXIAL CABLE (NOT WITHIN BENDS)
4. COAXIAL CABLE IDENTIFICATION
 - a. TO PROVIDE EASY IDENTIFICATION AND UNIFORM MARKING OF ANTENNA CABLING, PLASTIC TAGS SHALL BE USED AT THE FOLLOWING LOCATIONS:
 1. FIRST LOCATION IS AT THE END OF THE COAX NEAREST THE ANTENNA (WHERE THE COAXIAL CABLE AND JUMPER ARE CONNECTED).
 2. SECOND LOCATION IS INSIDE THE EQUIPMENT SHELTER NEAR THE WAVEGUIDE ENTRY PORT.
 - b. USE ANDREW CABLE TIES (PT. # 7290) TO SECURE IDENTIFICATION TAGS.
5. TESTING

LESSEE SHALL PROVIDE AN INDEPENDENT TESTING AGENCY TO PERFORM THE COAXIAL SWEEP TEST & REPORT. THE CONTRACTOR IS TO PROVIDE ONE CLIMBER / QUALIFIED PERSONNEL TO ASSIST IN ANY REPAIRS AND WEATHERPROOFING ONCE THE TEST IS COMPLETE. THE CONTRACTOR IS TO PROVIDE LESSEE WITH A MINIMUM OF 48 HOURS NOTICE PRIOR TO THE TIME OF THE SWEEP TEST.

REVISIONS				
NO.	DESCRIPTION	DATE	BY	
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7	ADDITION OF LANDSCAPING PLAN	12/28/17	JTM	
8	UPDATE PER GAS COORDINATION	01/31/18	DMS	
9	REVISED LANDSCAPE PLAN PER VILLAGE	04/05/18	JTM	

LOC. # 311466

W 151ST
& S 80TH

15100 S 80TH AVE
ORLAND PARK, IL 60462

DRAWN BY:	PP
CHECKED BY:	TAZ
DATE:	07/23/15
PROJECT #:	33-1466

SHEET TITLE

SPECIFICATIONS

SHEET NUMBER

SP-2

**CHICAGO
SMSA**
limited partnership
d/b/a VERIZON WIRELESS





1 EXISTING OVERALL SITE
SCALE: N.T.S.



5 EXISTING ACCESS GATE
SCALE: N.T.S.



2 EXISTING ACCESS DRIVE
SCALE: N.T.S.



6 EXISTING TRANSFORMER
SCALE: N.T.S.



3 EXISTING SITE COMPOUND
SCALE: N.T.S.



7 EXISTING GENERATOR
SCALE: N.T.S.



4 EXISTING FENCED COMPOUND
SCALE: N.T.S.



8 EXISTING TOWER FOUNDATION
SCALE: N.T.S.



9 EXISTING TOWER TAG
SCALE: N.T.S.

CHICAGO
SMSA
limited partnership
d/b/a VERIZON WIRELESS



REVISIONS		NO.	DATE	BY
	DESCRIPTION			DMS
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W 151ST
& S 80TH

15100 S 80TH AVE
ORLAND PARK, IL 60462

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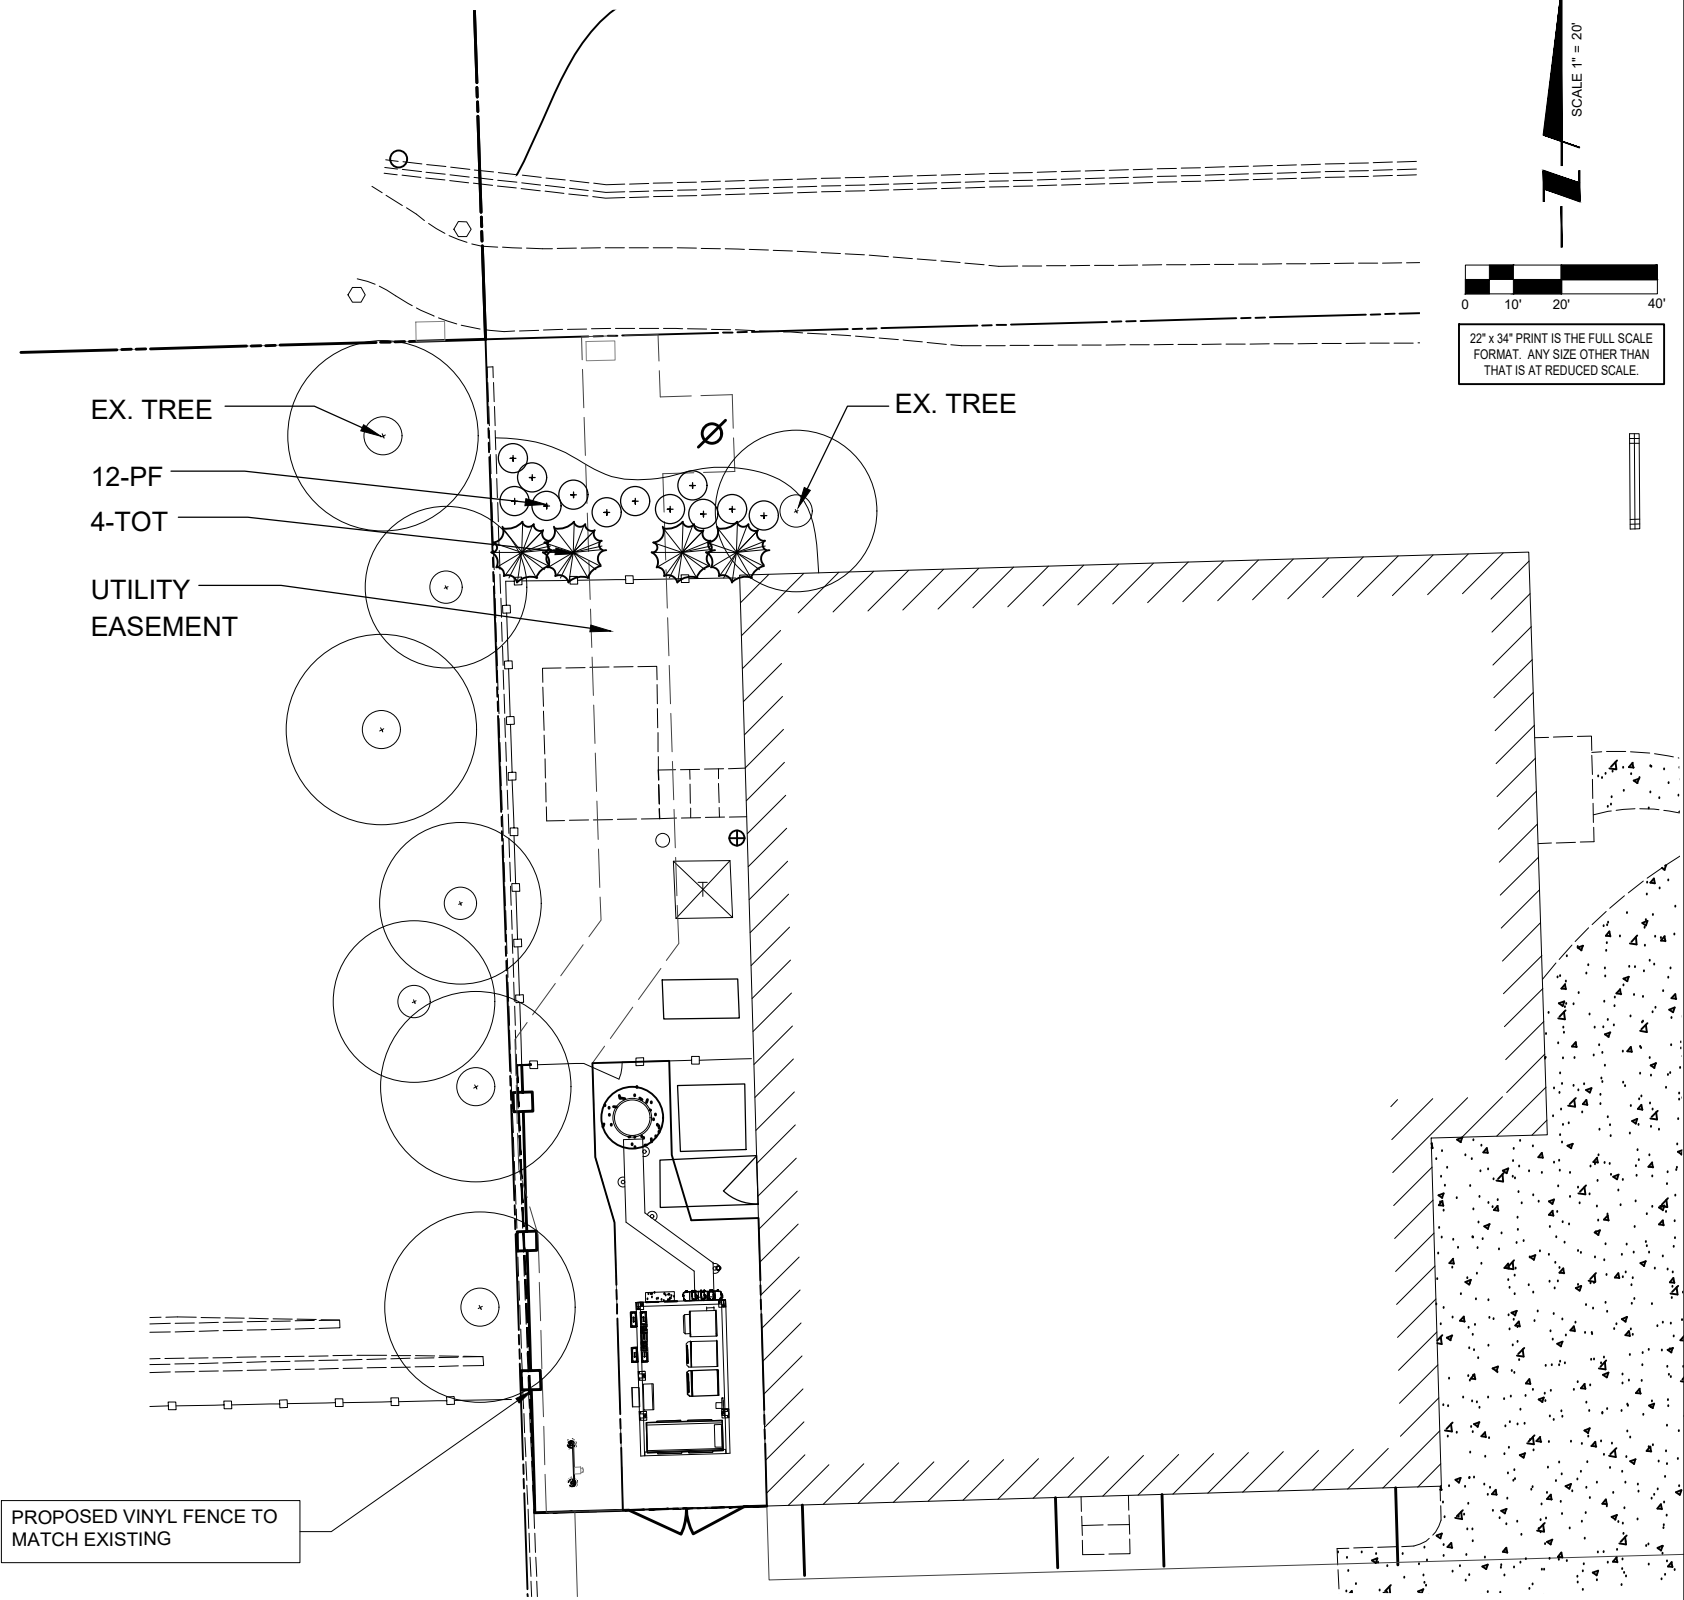
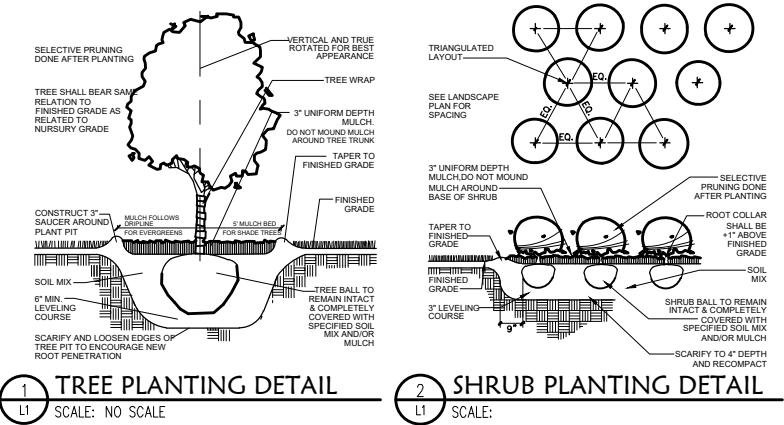
SHEET TITLE
EXISTING SITE PHOTOS

SHEET NUMBER

P-1

Master Plant List					
Symbol	Quantity	Botanical Name	Common Name	Size	Notes
Evergreen Trees					
TOT	4	THUJA OCCIDENTALIS 'TECHNY'	TECHNY ARBORVITAE	6' BB	
Deciduous Shrubs					
PF	12	POTENTILLA FRUITICOSA 'GOLD DROP'	GOLD DROP POTENTILLA	5 GAL	

- GENERAL CONSTRUCTION NOTES**
- REQUIRED LANDSCAPE MATERIAL SHALL SATISFY AMERICAN ASSOCIATION OF NURSERYMEN STANDARDS AND BE STAKED, WRAPPED, WATERED AND MULCHED PER ORDINANCE.
 - BEFORE ANY EXCAVATION ON THE SITE, CALL TO LOCATE ANY EXISTING UTILITIES ON THE SITE. THE CONTRACTOR SHALL FAMILIARIZE HIM/HERSELF WITH THE LOCATIONS OF ALL BURIED UTILITIES IN THE AREAS OF WORK BEFORE STARTING OPERATIONS. THE CONTRACTOR SHALL BE LIABLE FOR THE COST OF REPAIRING OR REPLACING ANY BURIED CONDUITS, CABLES OR PIPING DAMAGED DURING THE INSTALLATION OF THIS WORK.
 - FENCING OR OTHER RIGID MATERIAL IS TO BE ERECTED AROUND THE DRIP-LINE OF ALL TREES TO BE SAVED.
 - CONTRACTOR TO NOTIFY LANDSCAPE ARCHITECT UPON DELIVERY OF PLANT MATERIAL TO THE SITE. LANDSCAPE ARCHITECT RESERVES THE RIGHT TO REJECT ANY PLANT MATERIAL THAT DOESN'T MEET STANDARDS OR SPECIFICATIONS OF THE PROJECT.
 - ALL SPECIFIED LANDSCAPE MATERIAL INDICATED ON THE CONSTRUCTION DOCUMENTS WILL BE REQUIRED TO BE MAINTAINED THROUGHOUT THE LIFE OF THE PROJECT AND MUST BE REPLACED SHOULD IT DIE OR BECOME DAMAGED.
 - ALL PLANT MATERIAL SHALL HAVE A ONE YEAR GUARANTEE FROM SUBSTANTIAL COMPLETION AS DETERMINED BY THE LANDSCAPE ARCHITECT, AND SHALL BE REPLACED SHOULD IT DIE WITHIN THAT PERIOD.
 - PROTECT STRUCTURES, SIDEWALKS, PAVEMENTS AND UTILITIES TO REMAIN FROM DAMAGE CAUSED BY SETTLEMENT, LATERAL MOVEMENT, UNDERMINING, WASHOUTS AND OTHER HAZARDS CAUSED BY SITE IMPROVEMENT OPERATIONS.
 - CAREFULLY MAINTAIN PRESENT GRADE AT BASE OF ALL EXISTING TREES TO REMAIN. PREVENT ANY DISTURBANCE OF EXISTING TREES INCLUDING ROOT ZONES. USE TREE PROTECTION BARRICADES WHERE INDICATED. PROTECT EXISTING TREES TO REMAIN AGAINST UNNECESSARY CUTTING, BREAKING OR SKINNING OF ROOTS, BRUISING OF BARK OR SMOTHERING OF TREES. DRIVING, PARKING, DUMPING, STOCKPILING AND/OR STORAGE OF VEHICLES, EQUIPMENT, SUPPLIES, MATERIALS OR DEBRIS ON TOP THE ROOT ZONES AND/OR WITHIN THE DRIPLINE OF EXISTING TREES OR OTHER PLANT MATERIAL TO REMAIN IS STRICTLY PROHIBITED.
 - THE CONTRACTOR AT ALL TIMES SHALL KEEP THE PREMISES ON WHICH WORK IS BEING DONE, CLEAR OF RUBBISH AND DEBRIS. ALL PAVEMENT AND DEBRIS REMOVED FROM THE SITE SHALL BE DISPOSED OF LEGALLY.
 - ALL WORK AND OPERATIONS SHALL COMPLY WITH ALL APPLICABLE FEDERAL, STATE AND LOCAL CODES AND ORDINANCES.



K M TALTY DESIGN
LANDSCAPE ARCHITECTURE

Winnetka, Illinois 60093
847.612.5154 www.kmtaltydesign.com



CHICAGO SMSA
limited partnership
d/b/a VERIZON WIRELESS



REVISIONS		NO	DATE	BY
DESCRIPTION	UPDATE WITH NEW PLATFORM	2	10/06/16	TJS
	FINAL PENDING FIBER	3	08/21/17	DMS
	UPDATE WITH NEW ECR	4	08/31/17	JTM
	UPDATE WITH NEW LAYOUT	5	09/08/17	DMS
	FINALS WITH FIBER	6	10/20/17	RA
	ADDITION OF LANDSCAPING PLAN	7	12/20/17	JTM
	UPDATED PER GAS ROUTE	8	01/31/18	DMS

LOC. # 311466
W 151ST & S 80TH

15100 S 80TH AVE
ORLAND PARK, IL 60462

DRAWN BY:	PP
CHECKED BY:	TAZ
DATE:	07/23/15
PROJECT #:	33-1466

SHEET TITLE
LANDSCAPE PLAN

SHEET NUMBER
L-1

LEGEND

	Light Post		Found Section Corner Monument
	Power Pole		Found or Set Monument
	Telephone Pedestal		Found or Set Cut Cross
	Manhole		
	Water Valve Vault	59.75'	Measured
	Water Service Valve	(60.00')	Record
	Fire Hydrant	DOC. NO.	Document Number
	Electric Meter		Building
	Gas Meter		Asphalt
	Fence		Concrete
	Centerline		<u>PROPOSED</u> Lease Site Area
	Section Line		Access Easement
	Underground Sanitary Line		Utility Easement
	Underground Electric Line	AGL	Above Ground Level
	Underground Fiber Optic Line	P.O.C.	Point of Commencement
	Underground Gas Line	P.O.B.	Point of Beginning
	Underground Storm Line		
	Underground Water Line		
	Underground Communication Line		

EASEMENTS AND SETBACKS SHOWN HEREON ARE BASED UPON THE RECORDED SUBDIVISION PLAT UNLESS NOTED OTHERWISE.

THE SURVEYOR EXPRESSES NO OPINION AS TO THE ACCURACY OF ANY UNDERGROUND UTILITIES WHEN NOT READILY VISIBLE FROM THE SURFACE. IT IS RECOMMENDED THAT THE APPROPRIATE GOVERNMENTAL AGENCY, MUNICIPALITY AND/OR UTILITY COMPANY BE CONTACTED FOR VERIFICATION.


THE PERMANENT PARCEL INDEX NUMBERS FOR THE PROPERTY
ENCUMBERED BY THE LEASE SITE AND EASEMENT HEREON ARE
27-14-201-010 & 011.

THE FLOOD INSURANCE RATE MAP SHOWS THAT THE PROPERTY DESCRIBED HEREON IS FALLING WITHIN ZONE "X", ACCORDING TO THE COMMUNITY PANEL NUMBER 170140 0702 J, VILLAGE OF ORLAND PARK, MAP NUMBER 17031C0702J, COOK COUNTY, ILLINOIS AND INCORPORATED AREAS, MAP REVISED AUGUST 19, 2008.

ZONE "X" IS AREA DETERMINED TO BE OUTSIDE THE 0.2% ANNUAL CHANCE FLOODPLAIN.

NO WETLAND MARKERS WERE OBSERVED DURING FIELD SURVEY, DATED 1/10/2018.

EASEMENTS AND SERVITUDES SHOWN HEREON ARE BASED UPON A TITLE COMMITMENT ISSUED BY CHICAGO TITLE INSURANCE COMPANY, AND IDENTIFIED AS ORDER NO.: 1401 008962542 D1, WITH AN EFFECTIVE DATE OF JULY 11, 2017.

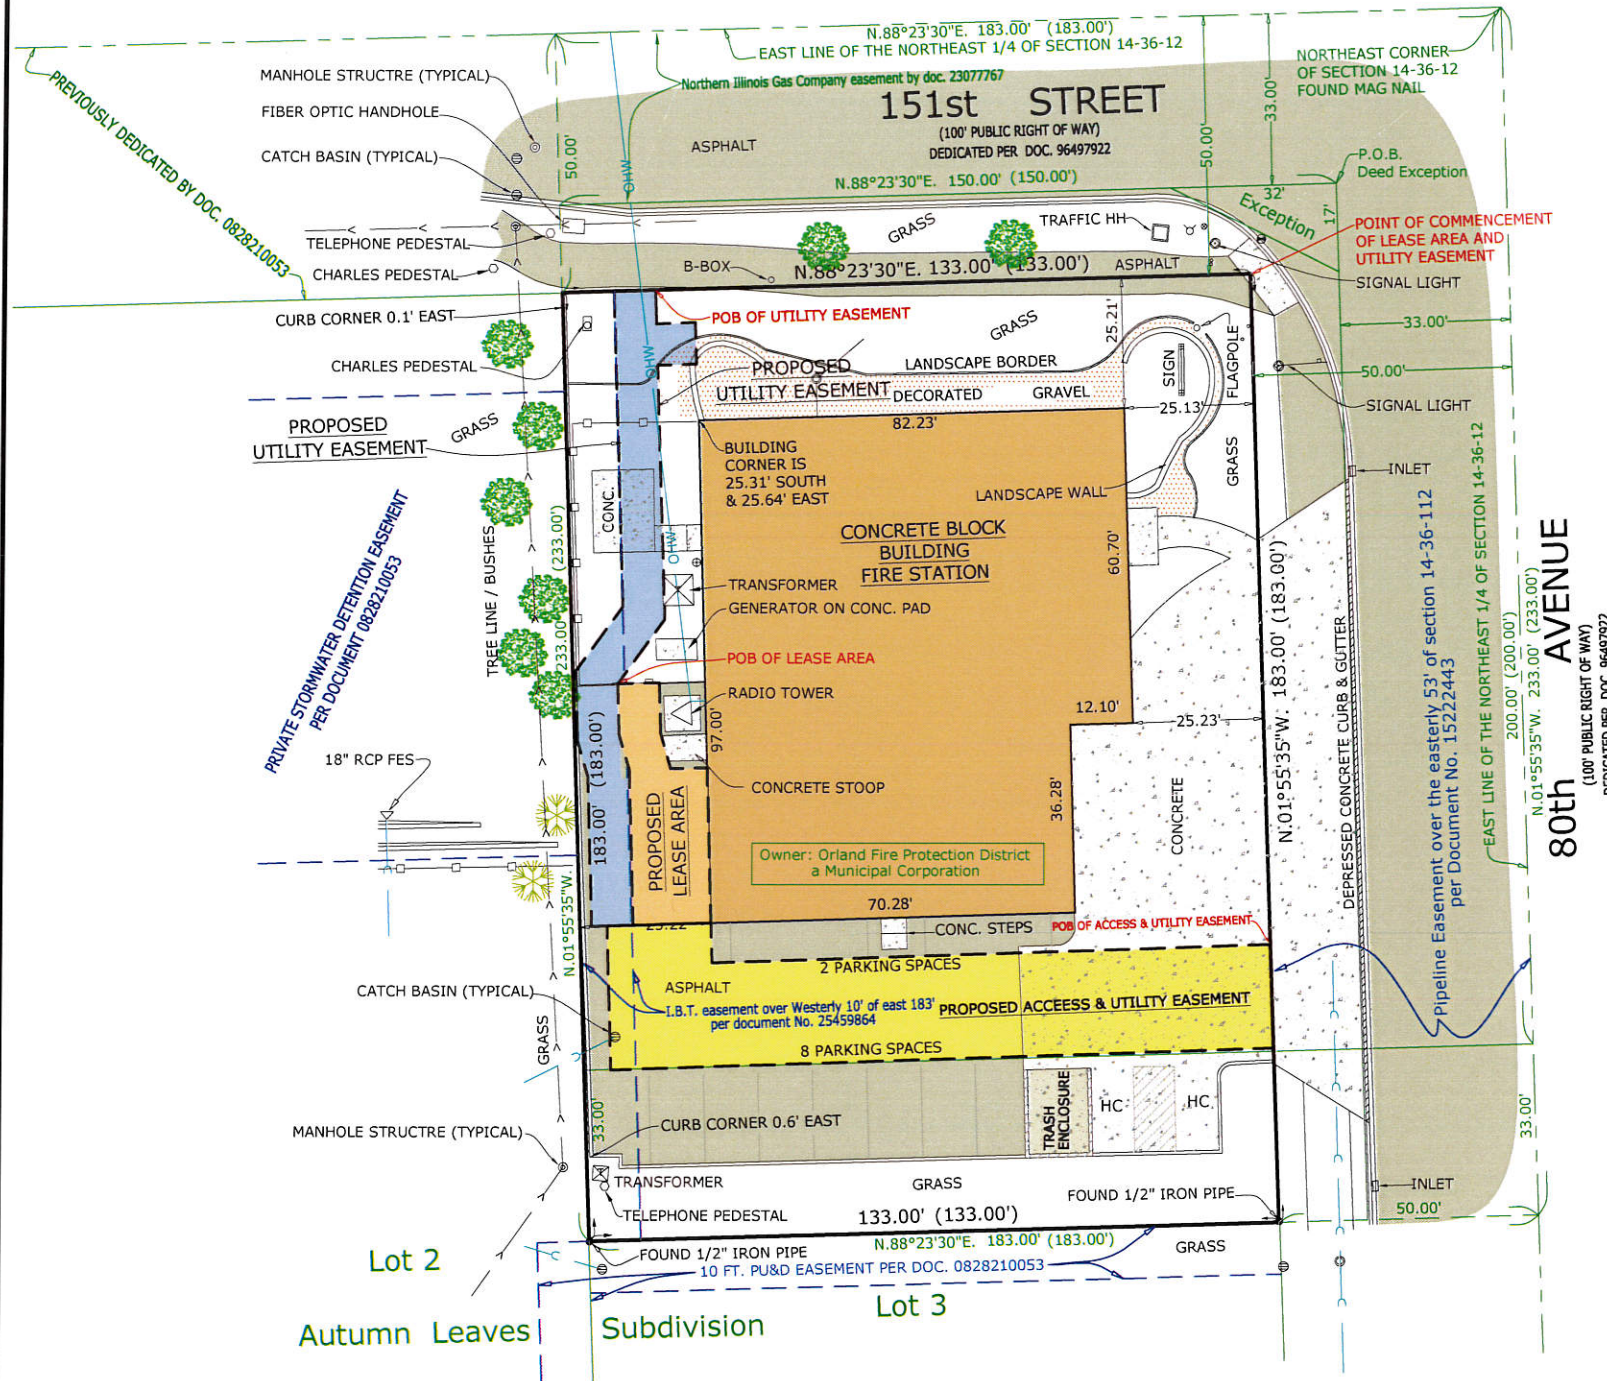

**SEE SHEET L-2 (SHEET 2 OF 2) FOR
LEASE AREA AND EASEMENTS
DETAIL AND LEGAL DESCRIPTIONS**

NUMBER OF PARKING STALLS:

REGULAR	10
HANDICAP	2
TOTAL	12

BEARINGS SHOWN HEREON ARE BASED ON
ILLINOIS STATE PLANE, EAST ZONE, NAD83 (2011)

MEAN MAGNETIC DECLINATION
OBTAINED FROM U.S.G.S.
7 1/2 MINUTE SERIES MAP
TINLEY PARK QUADRANGLE
STATE OF ILLINOIS

LATITUDE: N 41° 36' 58.54"
LONGITUDE: W 087° 48' 53.39"
AT PROPOSED CENTERLINE OF TOWER
COMPLIES WITH F.A.A. 1/A ACCURACY REQUIREMENTS

SCALE : 1" = 40'



11" X 17" PRINT IS THE FULL SCALE FORMAT OF THIS SURVEY.
ANY OTHER SIZE IS AT AN ADJUSTED SCALE.

UTM GRID AND 1993
MAGNETIC NORTH
DECLINATION AT
CENTER OF QUAD MAP

Chicago Title Insurance Company
Order No.: 1401 008962542 D1
Effective date: July 11, 2017
Document Number 25171045, Recorded October 1, 1979)

THE NORTH 233.0 FEET OF THE EAST 183.0 FEET OF THE EAST HALF OF THE
NORTHEAST QUARTER OF SECTION 14, TOWNSHIP 36 NORTH, RANGE 12, EAST OF THE
THIRD PRINCIPAL MERIDIAN (EXCEPT HIGHWAYS), IN COOK COUNTY, ILLINOIS.

STATE OF ILLINOIS

COUNTY OF KANE

TO: Chicago SMSA
and Chicago Title Insurance Company

THIS IS TO CERTIFY THAT THIS MAP OR PLAN AND THE SURVEY ON WHICH IT IS BASED, BEING COMPLETED IN THE FIELD ON 1/10/2018, WERE MADE IN ACCORDANCE WITH THE 2016 MINIMUM STANDARD DETAIL REQUIREMENTS FOR ALTA/NSPS LAND TITLE SURVEYS, JOINTLY ESTABLISHED AND ADOPTED BY THE AMERICAN LAND TITLE ASSOCIATION AND THE NATIONAL SOCIETY OF PROFESSIONAL SURVEYORS, AND INCLUDES ITEMS 2, 3, 4, 7(a), 8, 9, 11, 14 AND 18 OF TABLE A THEREOF. PURSUANT TO THE ACCURACY STANDARDS AS ADOPTED BY ALTA/NSPS, AND IN EFFECT ON THE DATE OF THIS CERTIFICATION, UNDERSIGNED FURTHER CERTIFIES THAT PROPER FIELD PROCEDURES, INSTRUMENTATION AND ADEQUATE SURVEY PERSONNEL WERE EMPLOYED IN ORDER TO ACHIEVE RESULTS COMPARABLE TO THOSE OUTLINED IN THE "MINIMUM ANGLE, DISTANCE AND CLOSURE REQUIREMENTS FOR SURVEY MEASUREMENTS WHICH CONTROL LAND BOUNDARIES FOR ALTA/NSPS LAND TITLE SURVEYS."

DATED AT BATAVIA, ILLINOIS ON
THIS 11TH DAY OF JANUARY, A.D., 2018.



CHARLES S. MARSHALL
ILLINOIS PROFESSIONAL LAND SURVEYOR NO. 3377
LICENSE EXPIRES 11/30/2018



NO.	DATE	REVISION
1.	1/10/2018	FIELD SURVEY COMPLETED
2.	1/11/2018	FINAL SURVEY COMPLETED
3.		

SITE DESIGNATION INFORMATION:

W 151st ST & S 80th AVE

Location No.: 278765

Project No.: 20130972076


15100 S 80th AVE
ORLAND PARK, IL 60462

DRAWN BY: PS
CHECKED BY: CSM

PROJECT NO.
720290B

L-1

SHEET 1 OF 2

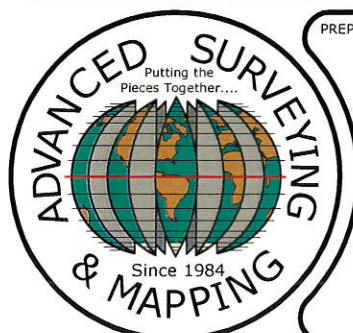

PREPARED BY:



ASM Consultants, Inc.
16 E Wilson St, Batavia IL 60510
Tel (630) 879-0200 Fax (630) 454-3774
advanced@advct.com
Professional Design Firm #184-006014 expires 4/30/2019

PREPARED FOR:


Chicago SMSA

CHICAGO SMSA LIMITED PARTNERSHIP
d/b/a VERIZON WIRELESS
1515 WOODFIELD ROAD, SUITE 1400
SCHAUMBURG, ILLINOIS 60173
PHONE: 847-619-5397 FAX: 847-706-7415



TERRA
Consulting Group, LTD.
600 Busse Highway
Park Ridge, IL 60068
(847) 698-6400

ALTA/NSPS LAND TITLE SURVEY

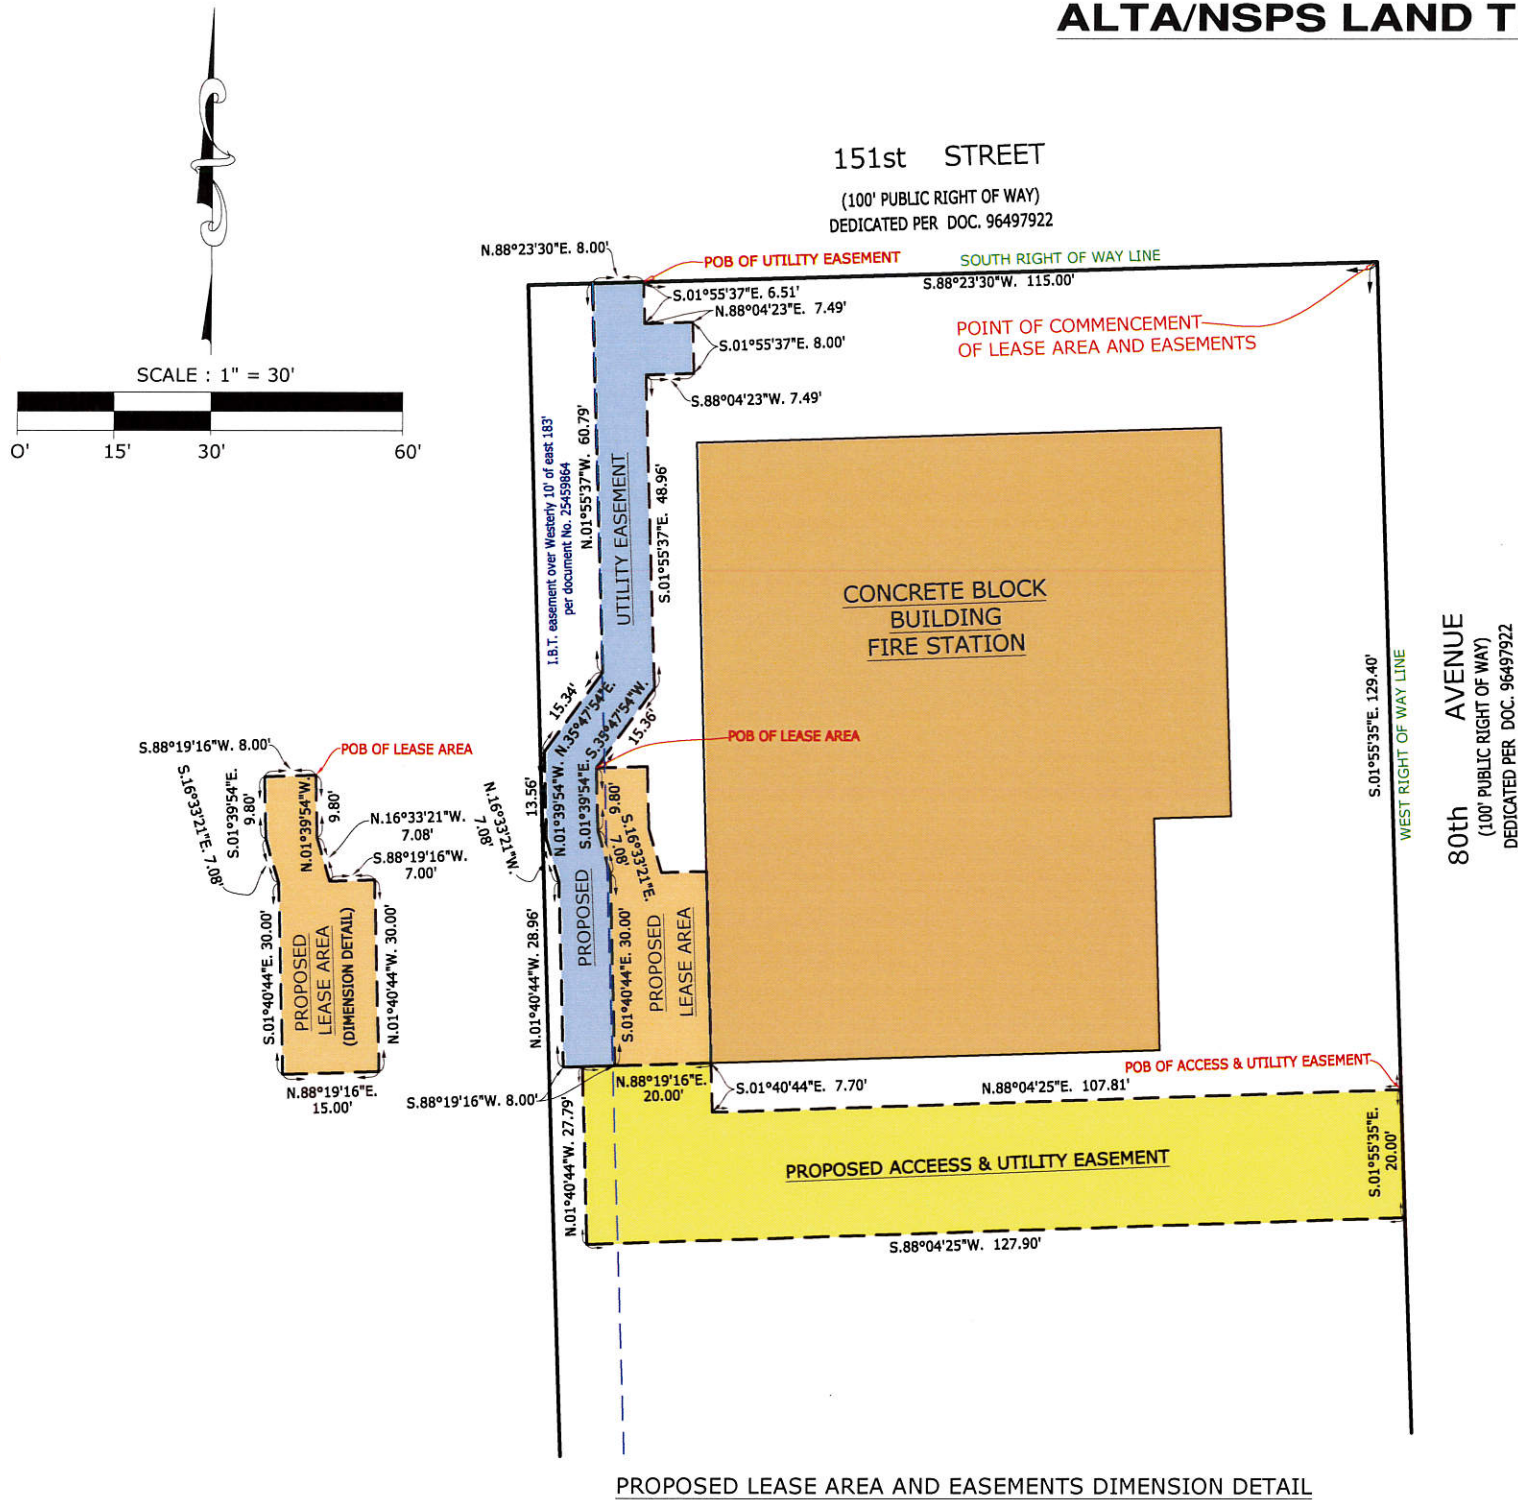

PROPOSED LEASE AREA AND EASEMENTS DIMENSION DETAIL

PROPOSED LEASE AREA LEGAL DESCRIPTION:

A PARCEL OF LAND FOR LEASE AREA PURPOSES, BEING A PART OF THE EAST 1/2 OF THE NORTHEAST 1/4 OF SECTION 14, TOWNSHIP 36 NORTH, RANGE 12, EAST OF THE THIRD PRINCIPAL MERIDIAN, IN COOK COUNTY, ILLINOIS, FURTHER DESCRIBED AS FOLLOWS:

COMMENCING AT THE INTERSECTION OF THE SOUTH LINE OF THE NORTH 50.00 FEET OF SAID NORTHEAST 1/4 WITH THE WEST LINE OF THE EAST 50.00 FEET OF SAID NORTHEAST 1/4, ALSO BEING THE INTERSECTION OF THE SOUTH RIGHT-OF-WAY LINE OF 151ST STREET WITH THE WEST RIGHT-OF-WAY LINE OF 80TH AVENUE; THENCE SOUTH 88 DEGREES 23 MINUTES 30 SECONDS WEST ALONG SAID SOUTH RIGHT-OF-WAY LINE, 115.00 FEET; THENCE SOUTH 01 DEGREES 55 MINUTES 37 SECONDS EAST. 6.51 FEET; THENCE NORTH 88 DEGREES 04 MINUTES 23 SECONDS EAST, 7.49 FEET; THENCE SOUTH 01 DEGREES 55 MINUTES 37 SECONDS EAST, 8.00 FEET; THENCE SOUTH 88 DEGREES 04 MINUTES 23 SECONDS WEST, 7.49 FEET; THENCE SOUTH 01 DEGREES 55 MINUTES 37 SECONDS EAST, 48.96 FEET; THENCE SOUTH 35 DEGREES 47 MINUTES 54 SECONDS WEST, 15.36 FEET FOR A POINT OF BEGINNING; THENCE SOUTH 01 DEGREES 39 MINUTES 54 SECONDS EAST, 9.80 FEET; THENCE SOUTH 16 DEGREES 33 MINUTES 21 SECONDS EAST, 7.08 FEET; THENCE SOUTH 01 DEGREES 40 MINUTES 44 SECONDS EAST, 30.00 FEET; THENCE NORTH 88 DEGREES 19 MINUTES 16 SECONDS EAST, 15.00 FEET; TO THE EXISTING BUILDING; THENCE NORTH 01 DEGREES 40 MINUTES 44 SECONDS WEST, ALONG SAID BUILDING, 30.00 FEET; THENCE SOUTH 88 DEGREES 19 MINUTES 16 SECONDS WEST, 7.00 FEET; THENCE NORTH 16 DEGREES 33 MINUTES 21 SECONDS WEST, 7.08 FEET; THENCE NORTH 01 DEGREES 39 MINUTES 54 SECONDS WEST, 9.80 FEET TO THE POINT OF BEGINNING.

SAID PARCEL CONTAINS 583.1 SQUARE FEET.

PROPOSED UTILITY EASEMENT LEGAL DESCRIPTION:

A PARCEL OF LAND FOR UTILITY EASEMENT PURPOSES, BEING A PART OF THE EAST 1/2 OF THE NORTHEAST 1/4 OF SECTION 14, TOWNSHIP 36 NORTH, RANGE 12, EAST OF THE THIRD PRINCIPAL MERIDIAN, IN COOK COUNTY, ILLINOIS, FURTHER DESCRIBED AS FOLLOWS:

COMMENCING AT THE INTERSECTION OF THE SOUTH LINE OF THE NORTH 50.00 FEET OF SAID NORTHEAST 1/4 WITH THE WEST LINE OF THE EAST 50.00 FEET OF SAID NORTHEAST 1/4, ALSO BEING THE INTERSECTION OF THE SOUTH RIGHT-OF-WAY LINE OF 151ST STREET WITH THE WEST RIGHT-OF-WAY LINE OF 80TH AVENUE; THENCE SOUTH 88 DEGREES 23 MINUTES 30 SECONDS WEST ALONG SAID SOUTH RIGHT-OF-WAY LINE, 115.00 FEET FOR A POINT OF BEGINNING; THENCE SOUTH 01 DEGREES 55 MINUTES 37 SECONDS EAST. 6.51 FEET; THENCE NORTH 88 DEGREES 04 MINUTES 23 SECONDS EAST, 7.49 FEET; THENCE SOUTH 01 DEGREES 55 MINUTES 37 SECONDS EAST, 8.00 FEET; THENCE SOUTH 88 DEGREES 04 MINUTES 23 SECONDS WEST, 7.49 FEET; THENCE SOUTH 01 DEGREES 55 MINUTES 37 SECONDS EAST, 48.96 FEET; THENCE SOUTH 35 DEGREES 47 MINUTES 54 SECONDS WEST, 15.36 FEET; THENCE SOUTH 01 DEGREES 39 MINUTES 54 SECONDS EAST, 9.80 FEET; THENCE SOUTH 16 DEGREES 33 MINUTES 21 SECONDS EAST, 7.08 FEET; THENCE SOUTH 01 DEGREES 40 MINUTES 44 SECONDS EAST, 30.00 FEET; THENCE SOUTH 88 DEGREES 19 MINUTES 16 SECONDS WEST, 8.00 FEET; THENCE NORTH 01 DEGREES 40 MINUTES 44 SECONDS WEST, 28.96 FEET; THENCE NORTH 16 DEGREES 33 MINUTES 21 SECONDS WEST, 7.08 FEET; THENCE NORTH 01 DEGREES 39 MINUTES 54 SECONDS WEST, 13.56 FEET; THENCE NORTH 35 DEGREES 47 MINUTES 54 SECONDS EAST, 15.34 FEET; THENCE NORTH 01 DEGREES 55 MINUTES 37 SECONDS WEST, 60.79 FEET TO THE AFOREMENTIONED SOUTH RIGHT-OF-WAY LINE; THENCE NORTH 88 DEGREES 23 MINUTES 30 SECONDS EAST, ALONG SAID RIGHT OF WAY LINE, 8.00 FEET TO THE POINT OF BEGINNING.

SAID PARCEL CONTAINS 1,065.7 SQUARE FEET.

PROPOSED ACCESS & UTILITY EASEMENT LEGAL DESCRIPTION:

A PARCEL OF LAND FOR ACCESS & UTILITY EASEMENT PURPOSES, BEING A PART OF THE EAST 1/2 OF THE NORTHEAST 1/4 OF SECTION 14, TOWNSHIP 36 NORTH, RANGE 12, EAST OF THE THIRD PRINCIPAL MERIDIAN, IN COOK COUNTY, ILLINOIS, FURTHER DESCRIBED AS FOLLOWS:

COMMENCING AT THE INTERSECTION OF THE SOUTH LINE OF THE NORTH 50.00 FEET OF SAID NORTHEAST 1/4 WITH THE WEST LINE OF THE EAST 50.00 FEET OF SAID NORTHEAST 1/4, ALSO BEING THE INTERSECTION OF THE SOUTH RIGHT-OF-WAY LINE OF 151ST STREET WITH THE WEST RIGHT-OF-WAY LINE OF 80TH AVENUE; THENCE SOUTH 01 DEGREES 55 MINUTES 35 SECONDS EAST ALONG SAID WEST RIGHT-OF-WAY LINE, 129.40 FEET FOR THE POINT OF BEGINNING; THENCE CONTINUING SOUTH 01 DEGREES 55 MINUTES 35 SECONDS EAST, 20.00 FEET; THENCE SOUTH 88 DEGREES 04 MINUTES 25 SECONDS WEST, 127.90 FEET; THENCE NORTH 01 DEGREES 40 MINUTES 44 SECONDS WEST, 27.79 FEET; THENCE NORTH 88 DEGREES 19 MINUTES 16 SECONDS EAST, 20.00 FEET; THENCE SOUTH 01 DEGREES 40 MINUTES 44 SECONDS EAST, 7.70 FEET; THENCE NORTH 88 DEGREES 04 MINUTES 25 SECONDS EAST, 107.81 FEET TO THE POINT OF BEGINNING.

SAID PARCEL CONTAINS 2,712.1 SQUARE FEET.



PREPARED BY:



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16 E Wilson St, Batavia IL 60510
Tel (630) 879-0200 Fax (630) 454-3774
advanced@advct.com
Professional Design Firm #184-006014 expires 4/30/2019

LEASE AREA & EASEMENTS DETAIL

PREPARED FOR:

Chicago SMSA

CHICAGO SMSA LIMITED PARTNERSHIP
d/b/a VERIZON WIRELESS
1515 WOODFIELD ROAD, SUITE 1400
SCHAUMBURG, ILLINOIS 60173
PHONE: 847-619-5397 FAX: 847-706-7415



TERRA
Consulting Group, LTD.
600 Busse Highway
Park Ridge, IL 60068
(847) 698-6400

NO.	DATE	REVISION
1.	1/10/2018	FIELD SURVEY COMPLETED
2.	1/11/2018	FINAL SURVEY COMPLETED

SITE DESIGNATION INFORMATION:

W 151st ST & S 80th AVE
Location No.: 278765
Project No.: 20130972076
15100 S 80th AVE
ORLAND PARK, IL 60462

DRAWN BY: PS
CHECKED BY: SLF

PROJECT NO.
720290B

L-2