



SHEET NUMBER

L2.2

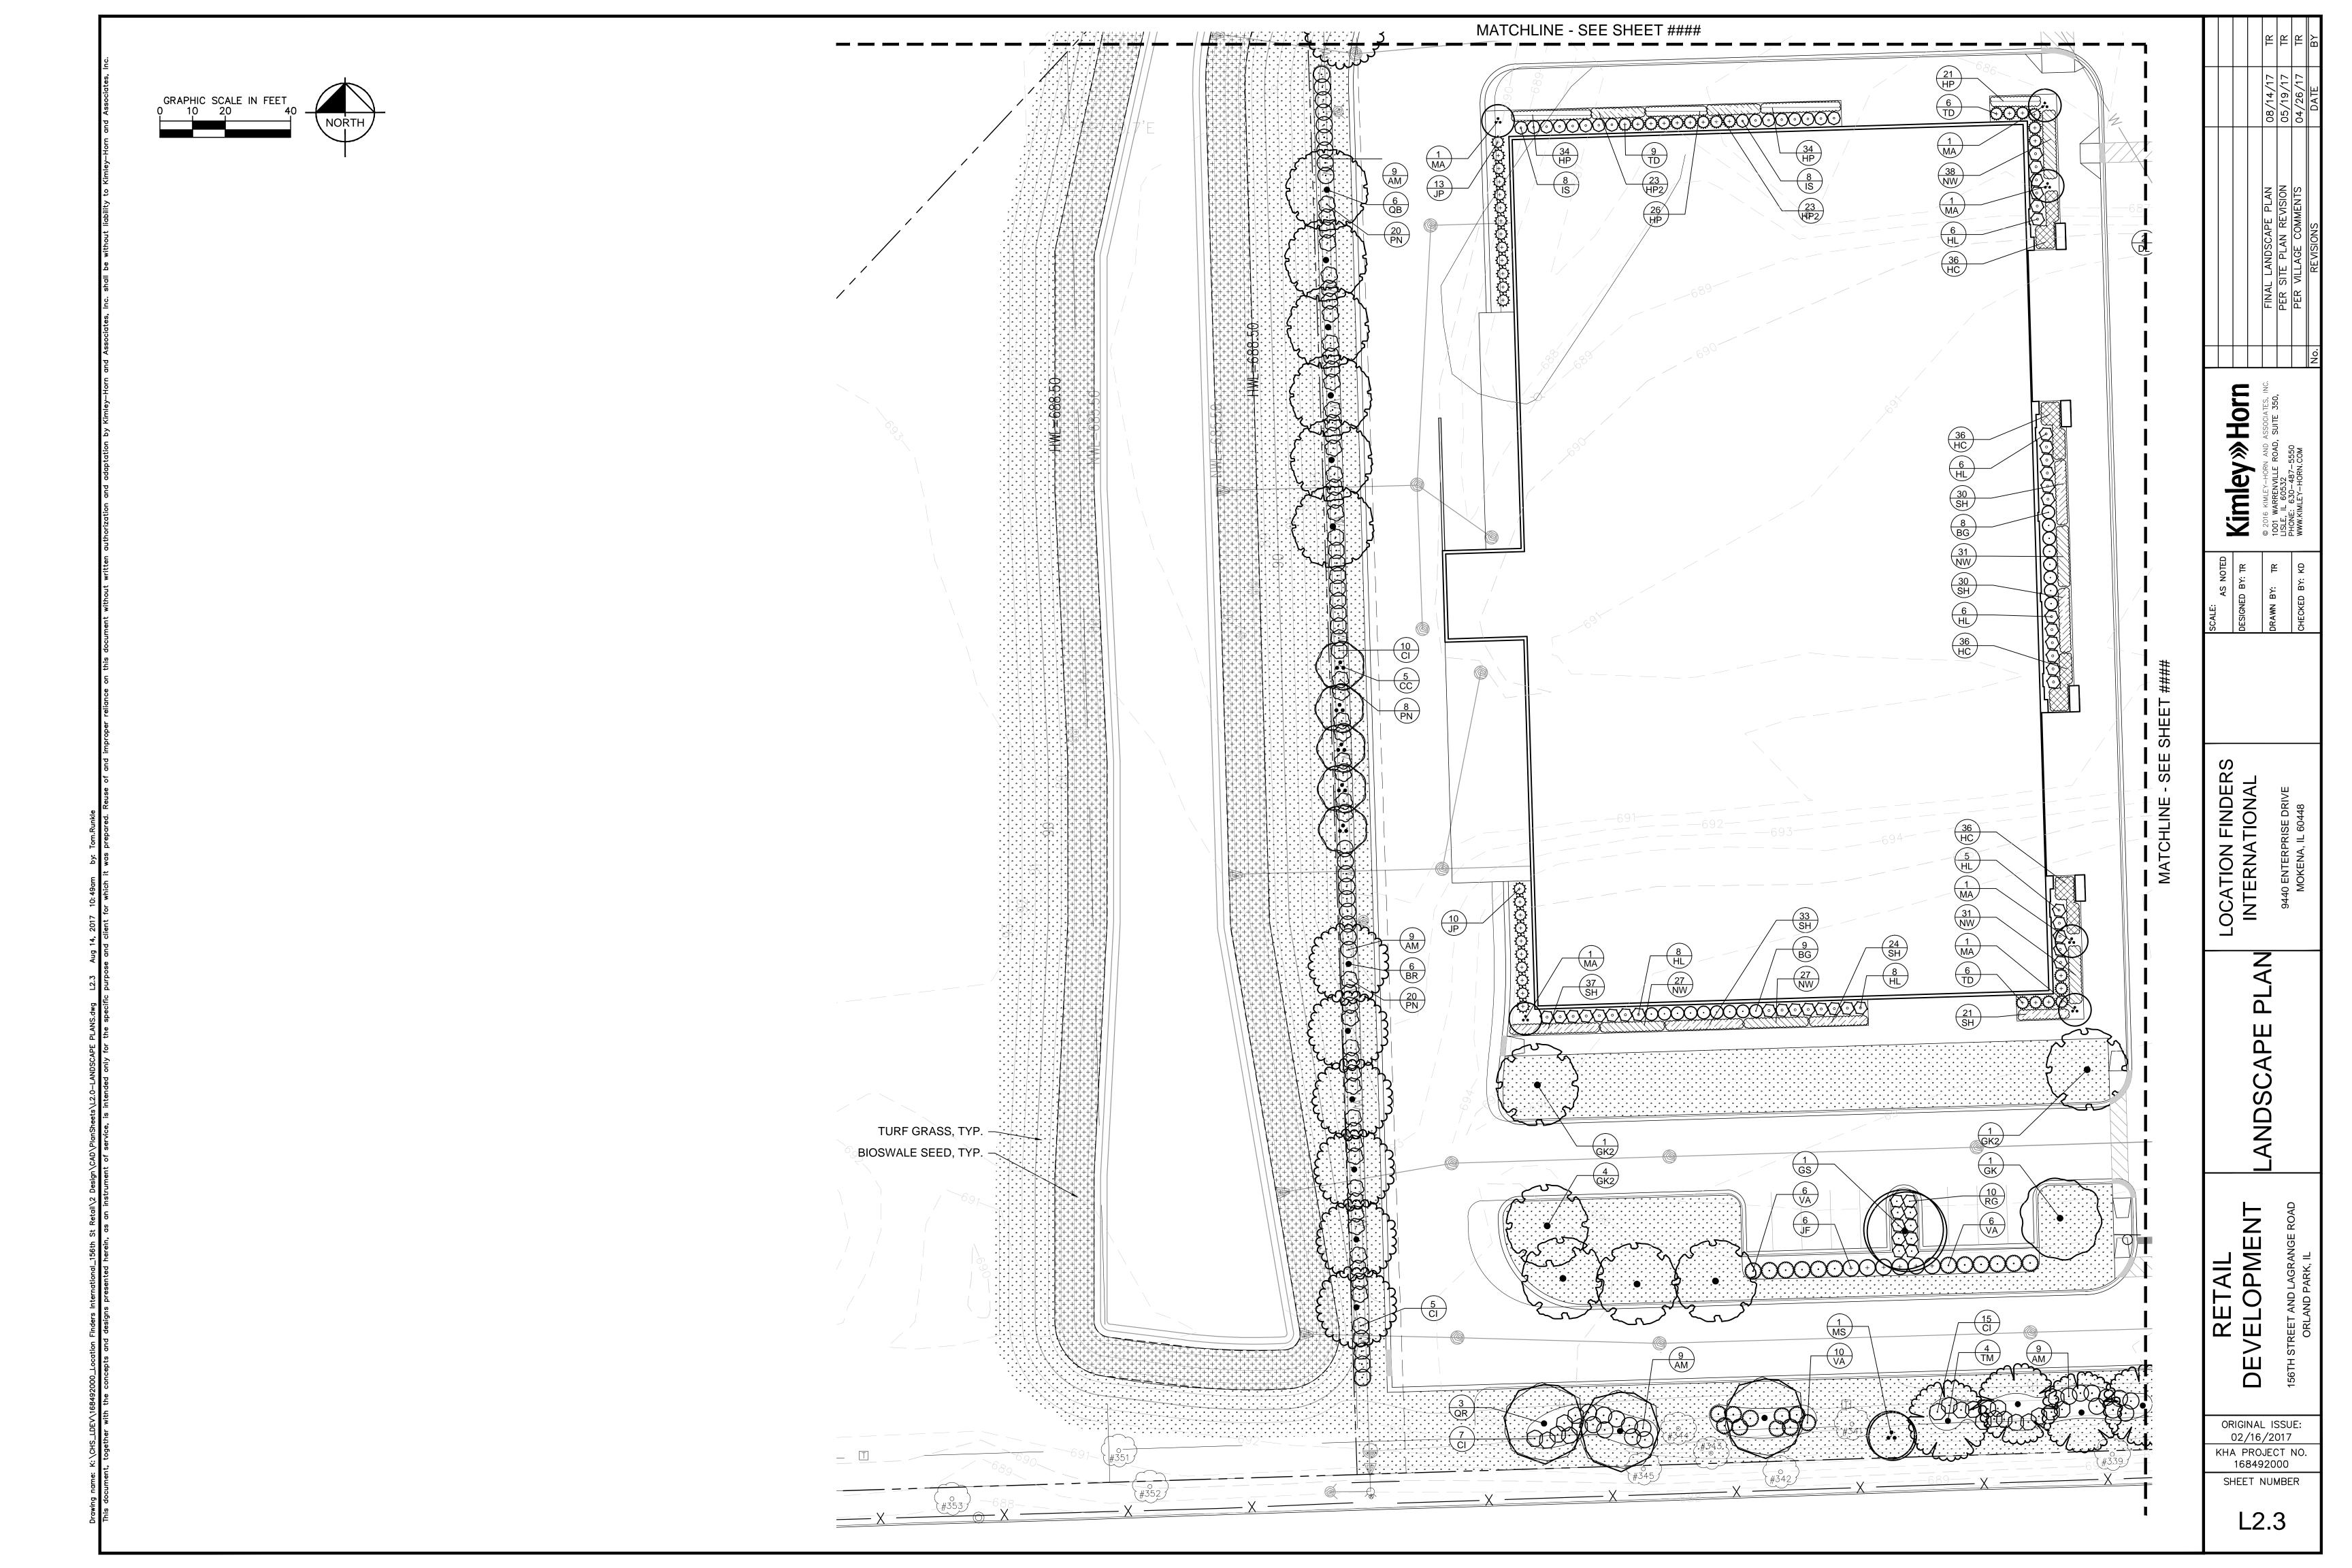

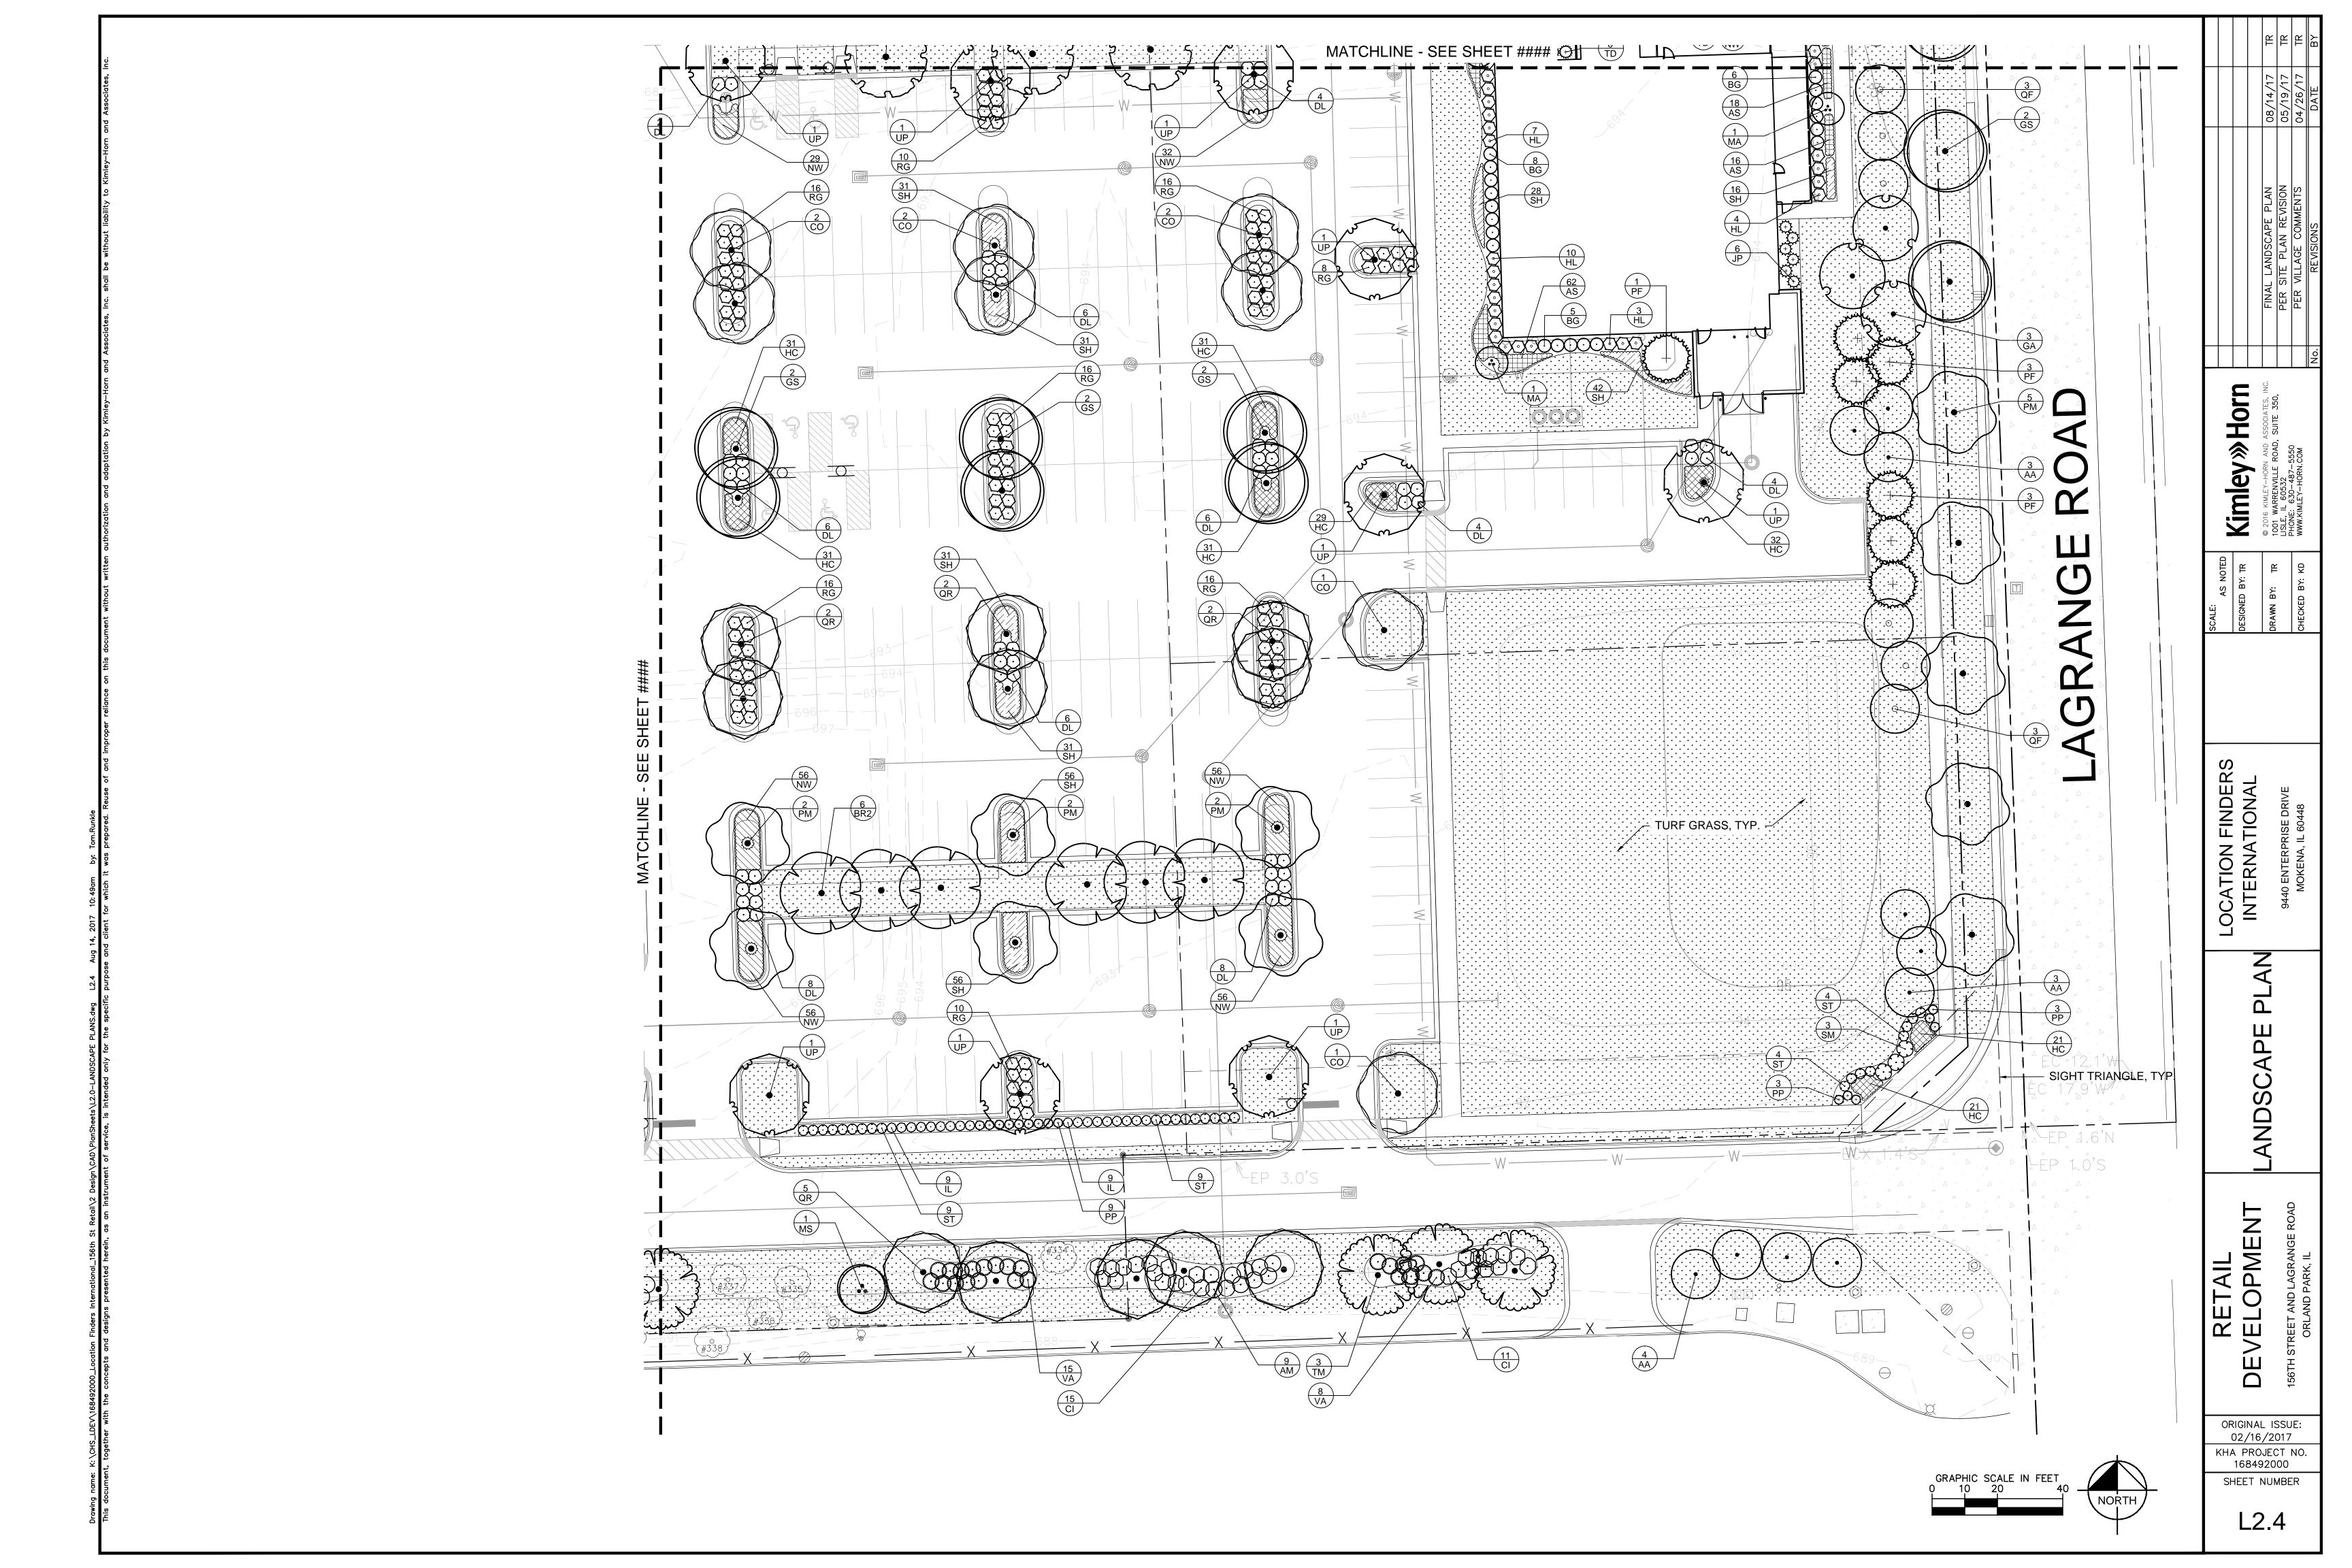

PLANT SCHEDULE

	PLANT SCHED	ULE						
	CANOPY TREES	CODE	QTY	BOTANICAL NAME	COMMON NAME	CONT	CAL	SIZE
KKK		AA	29	ACER X FREEMANII `ARMSTRONG`	ARMSTRONG FREEMAN MAPLE	B & B	2.5" CAL MIN	SINGLE STEM
£ •	wy A	BR	10	BETULA NIGRA	RIVER BIRCH	B & B	2.5" CAL MIN	SINGLE STEM
_	$\left\{ \cdot \right\}$	BR2	16	BETULA NIGRA	RIVER BIRCH	B & B	4" CAL MIN	SINGLE STEM
		СО	18	CELTIS OCCIDENTALIS	COMMON HACKBERRY	B & B	2.5" CAL MIN	SINGLE STEM
		GA	16	GINKGO BILOBA `AUTUMN GOLD` TM	AUTUMN GOLD MAIDENHAIR TREE	B & B	2.5" CAL MIN	SINGLE STEM
		GK	5	GYMNOCLADUS DIOICA	KENTUCKY COFFEE TREE	B & B	2.5" CAL MIN	SINGLE STEM
		GK2	11	GYMNOCLADUS DIOICA	KENTUCKY COFFEE TREE	B & B	4" CAL MIN	SINGLE STEM
		GS	19	GLEDITSIA TRIACANTHOS `SKYLINE`	SKYLINE HONEY LOCUST	B & B	2.5" CAL MIN	SINGLE STEM
,,,		PM	23	PLATANUS X ACERIFOLIA `MORTON CIRCLE`	EXCLAMATION LONDON PLANE TREE	B & B	2.5" CAL MIN	SINGLE STEM
€.		QB	11	QUERCUS BICOLOR	SWAMP WHITE OAK	B & B	2.5" CAL MIN	SINGLE STEM
٧.	$\left(\begin{array}{c} \circ \end{array}\right)$	QF	9	QUERCUS ROBUR `FASTIGIATA`	PYRAMIDAL ENGLISH OAK	B & B	2.5" CAL MIN	SINGLE STEM
		QR	22	QUERCUS RUBRA	RED OAK	B & B	2.5" CAL MIN	SINGLE STEM
	£.3	TM	15	TILIA AMERICANA `MCKSENTRY`	MCKSENTRY LINDEN	B & B	2.5" CAL MIN	SINGLE STEM
		UP	23	ULMUS AMERICANA `PRINCETON`	PRINCETON ELM	B & B	2.5" CAL MIN	SINGLE STEM
7	EVERGREEN TREES	CODE	QTY	BOTANICAL NAME	COMMON NAME	CONT	CAL	SIZE
	+	PF	7	PINUS FLEXILIS `VANDERWOLF`S PYRAMID`	VANDERWOLF`S PYRAMID PINE	B & B		6` HT MIN
	ORNAMENTAL TREES	CODE	QTY	BOTANICAL NAME	COMMON NAME	CONT	CAL	SIZE
	\.\.\.\.\.\.\.\.\.\.\.\.\.\.\.\.\.\.\.	AG	3	AMELANCHIER X GRANDIFLORA `AUTUMN BRILLIANCE`	`AUTUMN BRILLIANCE` SERVICEBERRY	B & B	MULTI-TRUNK	6` HT MIN
		CC	7	CERCIS CANADENSIS	EASTERN REDBUD	B & B	MULTI-TRUNK	6` HT MIN
	(.)	CV	3	CRATAEGUS CRUS-GALLI INERMIS TM	THORNLESS COCKSPUR HAWTHORN	B & B	MULTI-TRUNK	6` HT MIN
		MA	14	MALUS X `ADIRONDACK`	ADIRONDACK CRABAPPLE	B & B	MULTI-TRUNK	6` HT MIN
	(\cdot)	MS	5	MALUS X `SNOWDRIFT`	SNOWDRIFT CRAB APPLE	B & B	MULTI-TRUNK	6` HT MIN
(:		SI	3	SYRINGA RETICULATA 'IVORY SILK'	IVORY SILK JAPANESE TREE LILAC	B & B	MULTI-TRUNK	6` HT MIN
	DECIDUOUS SHRUBS	CODE		BOTANICAL NAME	COMMON NAME	CONT	SPACING	SIZE
	\odot	AM	61	ARONIA MELANOCARPA	BLACK CHOKEBERRY	-	SEE PLAN	24" HT MIN
	\odot	CI	78	CORNUS SERICEA 'ISANTI'	ISANTI REDOSIER DOGWOOD	-	SEE PLAN	24" HT MIN
	\odot	DL	107	DIERVILLA LONICERA	DWARF BUSH HONEYSUCKLE	-	SEE PLAN	18" HT MIN
	\bigcirc	HL	88	HYDRANGEA PANICULATA `LITTLE LIME`	LITTLE LIME HYDRANGEA	-	SEE PLAN	24" HT MIN
	\odot	IL	31	ITEA VIRGINICA `LITTLE HENRY` TM	LITTLE HENRY VIRGINIA SWEETSPIRE	-	SEE PLAN	18" HT MIN
	(·)	IS	29	ITEA VIRGINICA `SCARLET BEAUTY`	SCARLET BEAUTY SWEETSPIRE	-	SEE PLAN	24" HT MIN
	\bigcirc	PN	48	PHYSOCARPUS OPULIFOLIUS	NINEBARK	-	SEE PLAN	24" HT MIN
	$\langle \cdot \rangle$	RG	313	RHUS AROMATICA `GRO-LOW`	GRO-LOW FRAGRANT SUMAC	-	SEE PLAN	18" HT MIN
	\bigcirc	SM	28	SYRINGA PATULA `MISS KIM`	MISS KIM LILAC	-	SEE PLAN	24" HT MIN
		ST	58	SPIRAEA BETULIFOLIA `TOR`	TOR BIRCHLEAF SPIREA	-	SEE PLAN	18" HT MIN
	\odot	VA	52	VIBURNUM DENTATUM `CHRISTOM`	BLUE MUFFIN VIBURNUM	-	SEE PLAN	24" HT MIN
	EVERGREEN SHRUBS O	CODE BG	<u>QTY</u> 68	BOTANICAL NAME BUXUS X `GLENCOE`	COMMON NAME CHICAGOLAND GREEN BOXWEED	CONT -	SPACING SEE PLAN	SIZE 18" HT MIN
	→	JF	22	JUNIPERUS CHINENSIS `SEA GREEN`	SEA GREEN JUNIPER	-	SEE PLAN	24" HT MIN
	(†)	JP	33	JUNIPERUS CHINENSIS `KALLAYS COMPACT`		_	SEE PLAN	24" SPREAD
	↔	PP	50	PINUS MUGO `PUMILIO`	PUMILIO MUGO PINE	_	SEE PLAN	18" HT MIN
	(+)	TD	52	TAXUS X MEDIA `DENSIFORMIS`	DENSE YEW	-	SEE PLAN	24" SPREAD
	mrt	יטי	<u> </u>		SEINGE LEVV		SEE I LAIN	2. SINEAD

PERENNIALS AND GRASSE	S CODE	<u>QTY</u>	BOTANICAL NAME	COMMON NAME	CONT	<u>SPACING</u>	<u>SIZE</u>	<u>SPACING</u>
	AS	245	ALLIUM X `SUMMER BEAUTY`	SUMMER BEAUTY ALLIUM	1 GAL	18" OC		18" o.c.
	НС	786	HEMEROCALLIS X `CHICAGO FIRE`	CHICAGO FIRE DAYLILY	1 GAL	18" OC		18" o.c.
	HP	136	HOSTA X `PATRIOT`	PATRIOT HOSTA	1 GAL	18" OC		18" o.c.
	HP2	69	HEUCHERA X `PALACE PURPLE`	PALACE PURPLE CORAL BELLS	1 GAL	18" OC		18" o.c.
	NW	794	NEPETA X FAASSENII `WALKERS LOW`	WALKERS LOW CATMINT	1 GAL	18" OC		18" o.c.
	SH	1,063	SPOROBOLUS HETEROLEPIS	PRAIRIE DROPSEED	1 GAL	18" OC		18" o.c.
GROUND COVERS	CODE	QTY	BOTANICAL NAME	COMMON NAME	SPACING			
		139,096 SF		TURF SEED				
++++++ ++++++ ++++++ ++++++ ++++++ +++++	BS	21,803 SF		BIOSWALE SEED MIX				

AVAILABLE AS "DRY BOTTOM DETENTION BASIN SEED MIX" FROM PIZZO NATIVE PLANT NURSERY 10729 PINE ROAD LELAND, IL 60531

BIOSWALE SEED MIX 815.981.8000 OR EQUAL

BOTANICAL NAME	COMMON NAME	OZ/ ACRE	LBS/ ACRE	% OF MIX BY WEIGHT	% OF MIX SEED COUNT
GRASSES, SEDGES, & RU	JSHES				
ANDROPOGON GERARDII	BIG BLUESTEM GRASS	64.0000	4.00	13.99%	5.05%
CAREX BEBBII	BEBB'S OVAL SEDGE	2.0000	0.13	0.44%	0.54%
CAREX BREVIOR	PLAINS OVAL SEDGE	4.0000	0.25	0.87%	0.92%
CAREX HYSTERICINA	PORCUPINE SEDGE	4.0000	0.25	0.87%	0.95%
CAREX VULPINOIDEA	BROWN FOX SEDGE	6.0000	0.38	1.31%	4.74%
ELEOCHARIS ACICULARIS	NEEDLE SPIKE RUSH	1.0000	0.06	0.22%	0.55%
ELEOCHARIS ERYTHROPODA	RED-ROOTED SPIKE RUSH	2.0000	0.13	0.44%	1.23%
ELYMUS CANADENSIS	CANADA WILD RYE	32.0000	2.00	6.99%	1.31%
ELYMUS VIRGINICUS	VIRGINIA WILD RYE	48.0000	3.00	10.49%	1.59%
JUNCUS DUDLEYI	DUDLEY'S RUSH	1.0000	0.06	0.22%	25.26%
PANICUM VIRGATUM	SWITCH GRASS	80.000	5.00	17.49%	8.84%
SCHIZACHYRIUM SCOPARIUM	LITTLE BLUESTEM GRASS	64.0000	4.00	13.99%	7.58%
SORGHASTRUM NUTANS	INDIAN GRASS	16.0000	1.00	3.50%	1.52%
	GRAS	S/SEDGE SUBTOTALS	20.25	70.82%	60.07%
FLOWERS AND OTHER BI	ROADLEAVES ——				
ALLIUM CERNUUM	NODDING WILD ONION	4.0000	0.25	0.87%	0.24%
ASCLEPIAS INCARNATA	SWAMP MILKWEED	10.0000	0.63	2.19%	0.2470
CHAMAECRISTA FASCICULATA	PARTRIDGE PEA	16.0000	1.00	3.50%	0.34%
COREOPSIS TRIPTERIS	TALL COREOPSIS	4.0000	0.25	0.87%	0.44%
DESMODIUM CANADENSE	SHOWY TICK TREFOIL	4.0000	0.25	0.87%	0.17%
ECHINACEA PURPUREA	PURPLE CONEFLOWER	16.0000	1.00	3.50%	0.83%
ERYNGIUM YUCCIFOLIUM	RATTLESNAKE MASTER	8.0000	0.50	1.75%	0.47%
EUPATORIUM PERFOLIATUM	COMMON BONESET	1.0000	0.06	0.22%	1.26%
EUTHAMIA GRAMINIFOLIA	COMMON GRASS-LEAVED GOLDE		0.06	0.22%	2.76%
EUTROCHIUM MACULATUM	SPOTTED JOE PYE WEED	2.0000	0.13	0.44%	1.50%
HELENIUM AUTUMNALE	SNEEZEWEED	3.0000	0.19	0.66%	3.08%
KUHNIA EUPATORIOIDES CORYMBULOSA	FALSE BONESET	4.0000	0.25	0.87%	1.01%
MONARDA FISTULOSA	WILD BERGAMOT	4.0000	0.25	0.87%	2.21%
PENSTEMON DIGITALIS	FOXGLOVE BEARD TONGUE	4.0000	0.25	0.87%	4.10%
PYCNANTHEMUM VIRGINIANUM	COMMON MOUNTAIN MINT	2.0000	0.13	0.44%	3.47%
RUDBECKIA FULGIDA VAR. SULLIVANTII	SHOWY BLACK-EYED SUSAN	6.0000	0.38	1.31%	1.28%
RUDBECKIA HIRTA	BLACK-EYED SUSAN	8.0000	0.50	1.75%	5.81%
RUDBECKIA SUBTOMENTOSA	SWEET BLACK-EYED SUSAN	4.0000	0.25	0.87%	1.36%
RUDBECKIA TRILOBA	BROWN-EYED SUSAN	3.0000	0.19	0.66%	0.81%
SILPHIUM LACINIATUM	COMPASS PLANT	1.0000	0.06	0.22%	0.01%
SOLIDAGO RIDDELLII	RIDDELL'S GOLDENROD	1.0000	0.06	0.22%	0.73%
SOLIDAGO RIGIDA	STIFF GOLDENROD	1.5000	0.09	0.33%	0.49%
SYMPHYOTRICHUM NOVAE-ANGLIAE	NEW ENGLAND ASTER	4.0000	0.25	0.87%	2.05%
THALICTRUM DASYCARPUM	PURPLE MEADOW RUE	4.0000	0.25	0.87%	0.35%
VERNONIA FASCICULATA	COMMON IRONWEED	6.0000	0.38	1.31%	1.14%
VERBENA HASTATA	BLUE VERVAIN	4.0000	0.25	0.87%	2.94%
ZIZIA AUREA	GOLDEN ALEXANDERS	8.0000	0.50	1.75%	0.69%
	BRO	DADLEAF SUBTOTALS	8.34	29.18%	39.93%
NOTES:		SEED MIX TOTALS	28.59	100.00%	100.00%

- INSTALL A MYCORRHIZAL INOCCULANT WITH SEED MIX AT 40 LBS/ACRE
 FOR SPRING PLANTING, INSTALL A COVER CROP OF SEED OATS (AVENA SATIVA) WITH SEED MIX AT 40 LBS/ACRE
 FOR FALL PLANTING, INSTALL A COVER CROP OF REGREEN (A WINTER WHEAT X WHEATGRASS STERILE HYBRID) WITH SEED MIX AT 50 LBS/ACRE
 AT NO TIME SHOULD ANNUAL OR PERENNIAL RYE (LOLIUM MULTIFLORUM OR PERENNE) BE UTILIZED AS A COVER CROP.

	KIMIey»HOL	© 2016 KIMLEY—HORN AND ASSOCIATES, 1001 WARRENVILLE ROAD, SUITE 350, LISLE, IL 60532	WWW.KIMLEY-HORN.COM
SCALE: AS NOTED	DESIGNED BY: TR	DRAWN BY: TR	СНЕСКЕD ВҮ: КD

CATION FINDERS	NTERNATIONAL	9440 ENTERPRISE DRIVE	MOKENA, IL 60448

RETAIL DEVELOPMENT

ORIGINAL ISSUE: 02/16/2017 KHA PROJECT NO. 168492000

SHEET NUMBER

LANDSCAPE NOTES

- 1. THE LANDSCAPE CONTRACTOR SHALL BE RESPONSIBLE FOR INSTALLING MATERIALS AND PLANTS SHOWN ON THE LANDSCAPE PLAN. THE CONTRACTOR IS RESPONSIBLE FOR THE COST TO REPAIR UTILITIES, ADJACENT LANDSCAPE, PUBLIC AND PRIVATE PROPERTY THAT IS DAMAGED BY THE CONTRACTOR OR THEIR SUBCONTRACTOR'S OPERATIONS DURING INSTALLATION OR DURING THE SPECIFIED MAINTENANCE PERIOD. CALL FOR UTILITY LOCATIONS PRIOR TO ANY EXCAVATION.
- 2. THE CONTRACTOR SHALL REPORT ANY DISCREPANCY IN PLAN VS. FIELD CONDITIONS IMMEDIATELY TO THE LANDSCAPE ARCHITECT, PRIOR TO CONTINUING WITH THAT PORTION OF WORK.
- 3. THE CONTRACTOR SHALL BE RESPONSIBLE FOR THE REPAIR OF ANY OF THEIR TRENCHES OR EXCAVATIONS THAT
- 4. ALL NURSERY STOCK SHALL BE WELL BRANCHED, HEALTHY, FULL, PRE-INOCULATED AND FERTILIZED. DECIDUOUS TREES SHALL BE FREE OF FRESH SCARS. TRUNKS WILL BE WRAPPED IF NECESSARY TO PREVENT SUN SCALD AND INSECT DAMAGE. THE LANDSCAPE CONTRACTOR SHALL REMOVE THE WRAP AT THE PROPER TIME AS A PART OF THIS CONTRACT.
- 5. ALL NURSERY STOCK SHALL BE GUARANTEED, BY THE CONTRACTOR, FOR ONE YEAR FROM DATE OF FINAL INSPECTION.
 6. AMENDED SOIL SHALL BE PROVIDED AND GRADED BY THE GENERAL CONTRACTOR UP TO 6 INCHES BELOW FINISHED
- GRADE IN TURF AREAS AND 18 INCHES IN PLANTING AREAS.

 7. PLANTING AREA SOIL SHALL BE AMENDED WITH 25% SPHANGUM PEATMOSS, 5% HUMUS AND 65% PULVERIZED SOIL
- TOPSOIL.
 8. SEED LIMIT LINES ARE APPROXIMATE. CONTRACTOR SHALL SEED ALL AREAS WHICH ARE DISTURBED BY GRADING WITH

FOR ALL SHRUB, ORNAMENTAL GRASS, PERENNIAL AND ANNUAL BEDS. AMENDED TURF AREA SOIL SHALL BE STANDARD

- THE SPECIFIED SEED MIXES.

 9. CONTRACTOR SHALL INSTALL SHREDDED HARDWOOD MULCH AT A 3" DEPTH TO ALL TREES, SHRUB, PERENNIAL, AND GROUNDCOVER AREAS. TREES PLACED IN AREA COVERED BY TURF SHALL RECEIVE A 4 FT WIDE MAXIMUM TREE RING WITH 3" DEPTH SHREDDED HARDWOOD MULCH. A SPADED BED EDGE SHALL SEPARATE MULCH BEDS FROM TURF OR
- SEEDED AREAS. A SPADED EDGE IS NOT REQUIRED ALONG CURBED EDGES.

 10. INSTALLATION OF TREES WITHIN PARKWAYS SHALL BE COORDINATED IN THE FIELD WITH LOCATIONS OF UNDERGROUND UTILITIES. TREES SHALL NOT BE LOCATED CLOSER THAN 5' FROM UNDERGROUND UTILITY LINES AND NO CLOSER THAN 10' FROM UTILITY STRUCTURES.
- 11. DO NOT DISTURB THE EXISTING PAVING, LIGHTING, OR LANDSCAPING THAT EXISTS ADJACENT TO THE SITE UNLESS OTHERWISE NOTED ON PLAN.
- 12. PLANT QUANTITIES SHOWN ARE FOR THE CONVENIENCE OF THE OWNER AND JURISDICTIONAL REVIEW AGENCIES. THE CONTRACTOR IS RESPONSIBLE FOR VERIFYING ALL PLANT QUANTITIES AS DRAWN.
- 13. THE OWNER'S REPRESENTATIVE MAY REJECT ANY PLANT MATERIALS THAT ARE DISEASED, DEFORMED, OR OTHERWISE NOT EXHIBITING SUPERIOR QUALITY.

BIOSWALE NATIVE PLANTING NOTES

- 1. ALL WORK DEEMED NATURAL AREA TO BE SEEDED OR PLANTED SHALL BE PERFORMED BY A NATURALS AREA CONTRACTOR WITH AT LEAST 5 YEARS OF DOCUMENTED EXPERIENCE IN SELECTIVE BRUSH CLEARING, PLANTING OF NATIVE SPECIES, AND NATURAL AREAS MANAGEMENT FOR THE PURPOSE OF ECOLOGICAL RESTORATION, AND SHALL BE ABLE TO DEMONSTRATE THERE KNOWLEDGE THROUGH REFERENCES AND IN THE FIELD.
- 2. SEED LIMIT LINES ARE APPROXIMATE. THE NATURAL AREAS CONTRACTOR SHALL SEED ALL AREAS WHICH ARE DISTURBED BY GRADING WITH THE SPECIFIED SEED MIXES. SEED MIXES ARE TO BE SOURCED RESPECTIVELY THROUGH THE SPECIFIED COMPANY ON PLANS. REQUESTS FOR COMPARABLE SEED MIXES ARE TO BE APPROVED BY THE LANDSCAPE ARCHITECT.
- 3. SEED SHALL BE OBTAINED FROM SOURCES SPECIALIZING IN NATIVE SPECIES. SEED AND PLANT STOCK SHALL BE SOURCED NO MORE THAN 350 MILES FROM THE JOB SITE.
- 4. ALL SEED MIXES SHALL BE INSTALLED WITH A GRANULAR FORM OF ENDOMYCORRHIZAL INOCULUM PER THE SUPPLIERS SPECIFICATIONS. COVER CROP IS TO BE APPLIED TO ALL SEED MIXES CONSISTING ONLY OF AVENA SATIVA (SEED OATS) FOR SPRING INSTALLATIONS OR REGREEN (WHEAT HYBRID) FOR FALL PLANTINGS. NO OTHER COVER CROP IS TO BE USED ON SITE.
- 5. STANDARD EROSION CONTROL BLANKET SHALL BE APPLIED TO ALL SEEDED AREAS WITH SINGLE TO DOUBLE NET STRAW AND DOUBLE NET STRAW/COCONUT BLANKET HYDROSEEDING IS UNACCEPTABLE.
- 6. STEWARDSHIP OF THE NATURAL AREA SHALL BE CONDUCTED BY A NATURAL AREAS CONTRACTOR TO BEGIN IMMEDIATELY AFTER INSTALLATION FOR THREE YEARS.

BIOSWALE MINIMUM MAINTENANCE REQUIREMENTS

MAINTENANCE PROGRAMS SHALL BE SITE SPECIFIC AND COORDINATED WITH THE NATURAL AREAS CONTRACTOR AND VILLAGE OF ORLAND PARK FOR ADEQUATE MAINTENANCE PROCEDURES. A FIVE YEAR STEWARDSHIP PROGRAM IS RECOMMENDED FOR THE SITE WITH A MINIMUM THREE TO FIVE MAN CREW AND AT LEAST SIX VISITS PER YEAR. AFTER THE FIFTH GROWING SEASON MAINTENANCE PROGRAMS MAY BE REDUCED TO FOUR TO TWO VISITS PER YEAR DEPENDANT UPON SITE CONDITIONS WITH COORDINATING PRESCRIBED BURNS EVERY OTHER YEAR.

FIRST YEAR

SPRING:

-INSTALLATION PERFORMED IN THE SPRING REQUIRE 6-8 WEEKS OF THOROUGH TEMPORARY IRRIGATION TO MAINTAIN CONSISTENT SOIL MOISTURE.

-CONDUCT MOWING AS SOON AS THE SEEDED AREA REACH 4-8 INCHES IN HEIGHT.

SUMMER:

-CONTROL INVASIVE WOODY AND HERBACEOUS FLORA THOROUGH PHYSICAL REMOVAL OR SPOT HERBICIDE TREATMENTS.

-CONDUCT MOWING ATLEAST TWICE DURING THE GROWING SEASON, KEEPING NEWLY SEEDED AREAS 4-8 INCHES IN HEIGHT.

FALL:

-CONTROL INVASIVE WOODY AND HERBACEOUS FLORA THROUGH SPOT HERBICIDE TREATMENTS. IN AREAS LEFT BARE FROM HERBICIDE TREATMENT HAND SEED WITH THE RESPECTIVE SEED MIX.
-CONDUCT MOWING ATLEAST TWICE, KEEPING THE SEEDED AREAS 8 INCHES IN HEIGHT.

SECOND YEAR

SPRING:

-HAND CUT OR MOW DEAD STALKS AND SEED HEADS FROM THE PREVIOUS GROWING SEASON.
-CONTROL INVASIVE WOODY AND HERBACEOUS FLORA WITH ATLEAST ONE TO TWO SPOT HERBICIDE TREATMENTS.

-PLANT SUPPLEMENTAL NATIVE SEED AND/OR LIVE PLUGS AT OWNERS DISCRETION TO INCREASE COMPETITION AND BIO-DIVERSITY.

SUMMER:

-DEAD HEAD OR MOW SPENT COVER CROP TO KEEP NEAT APPEARANCE AND REDUCE SELF-SEEDING. -CONDUCT MOWING ATLEAST TWICE DURING THE GROWING SEASON KEEPING VEGETATION AT 6-8 INCHES IN HEIGHT.

FALL.

-CONTROL INVASIVE WOODY AND HERBACEOUS FLORA WITH SPOT HERBICIDE TREATMENTS. IN AREAS LEFT BARE FROM HERBICIDE TREATMENT HAND SEED WITH THE RESPECTIVE SEED MIX.
-CONDUCT MOWING ATLEAST TWICE, KEEPING THE SEEDED AREAS 8 INCHES IN HEIGHT.

THIRD YEAR SPRING:

-CONDUCT A PRESCRIBED BURN TO DETER INVASIVE WOODY AND HERBACEOUS FLORA. IF A BURN IS NOT PLAUSIBLE CONTROL INVASIVE WOODY AND HERBACEOUS FLORA THROUGH PHYSICAL REMOVAL OR SPOT HERBICIDE TREATMENTS.

-CONDUCT MOWING IF TARGETED INVASIVE WOODY SPECIES ARE PREVALENT.

-CONTROL INVASIVE WOODY AND HERBACEOUS FLORA WITH ATLEAST ONE TO TWO SPOT HERBICIDE TREATMENTS.

FALL:

-CONDUCT A PRESCRIBED BURN IF A SPRING BURN WAS UNFEASIBLE

-CONTROL INVASIVE WOODY AND HERBACEOUS FLORA WITH ATLEAST ONE TO TWO SPOT HERBICIDE TREATMENTS.

FOURTH AND FIFTH YEAR

SPRING:

-CUT AND REMOVE DEAD STALKS AND SEED HEADS FROM PREVIOUS SEASON

-CONTROL INVASIVE WOODY AND HERBACEOUS FLORA WITH AT LEAST ONE TO TWO SPOT HERBICIDE TREATMENTS.
SUMMER:

NEK: DUCT MOWING IF TARGETED INVASIVE WOODY SPECIES ARE PREVALE!

-CONDUCT MOWING IF TARGETED INVASIVE WOODY SPECIES ARE PREVALENT.
-CONTROL INVASIVE WOODY AND HERBACEOUS FLORA WITH ATLEAST ONE TO TWO SPOT HERBICIDE TREATMENTS.

-COLLECT SEEDS FROM NATIVE SPECIES TO DISPERSE IN MOWN OR HERBICIDE TREATED AREAS FOR THE FOLLOWING SPRING.

MONTH	VISITS BY CREW	HERBICIDE	BRUSH CLEARING	MOW	COLLECT & DISPERSE	PRESCRIBED BURN	MONITORING
APRIL	0-1	Х	Х			Х	
MAY	1-2	Х	Х	Х	Х	Х	Х
JULY	1-2	Х		Х	Х		Х
AUGUST	1-2	Х		Х			Х
SEPTEMBER	0-1	Х		Х			Х
OCTOBER	1-2	Х	Х	Х	Х		Х
NOVEMBER	0-1	Х	Х		Х	Х	Х
DECEMBER - MARCH	0-1	Х	Х		Х	Х	

FINAL LANDSCAPE PLAN 08/14/17
PER SITE PLAN REVISION 05/19/17
PER VILLAGE COMMENTS 04/26/17
REVISIONS DATE

께뭐뭐뭐

Kimley >>> Horn
© 2016 KIMLEY—HORN AND ASSOCIATES, INC.
1001 WARRENVILLE ROAD, SUITE 350,
LISLE, IL 60532
PHONE: 630—487—5550
WWW.KIMLEY—HORN.COM

DESIGNED BY: TR
DRAWN BY: TR
CHECKED BY: KD

OCATION FINDERS
INTERNATIONAL
9440 ENTERPRISE DRIVE

ANDSCAPE NOTES

VELOPMENT STREET AND LAGRANGE ROAD

TAIL

RE

ORIGINAL ISSUE: 02/16/2017 KHA PROJECT NO. 168492000

SHEET NUMBER

L2.6