

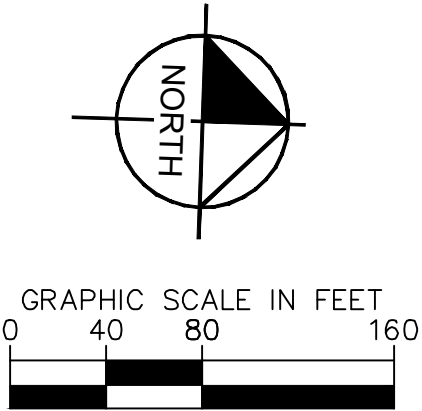
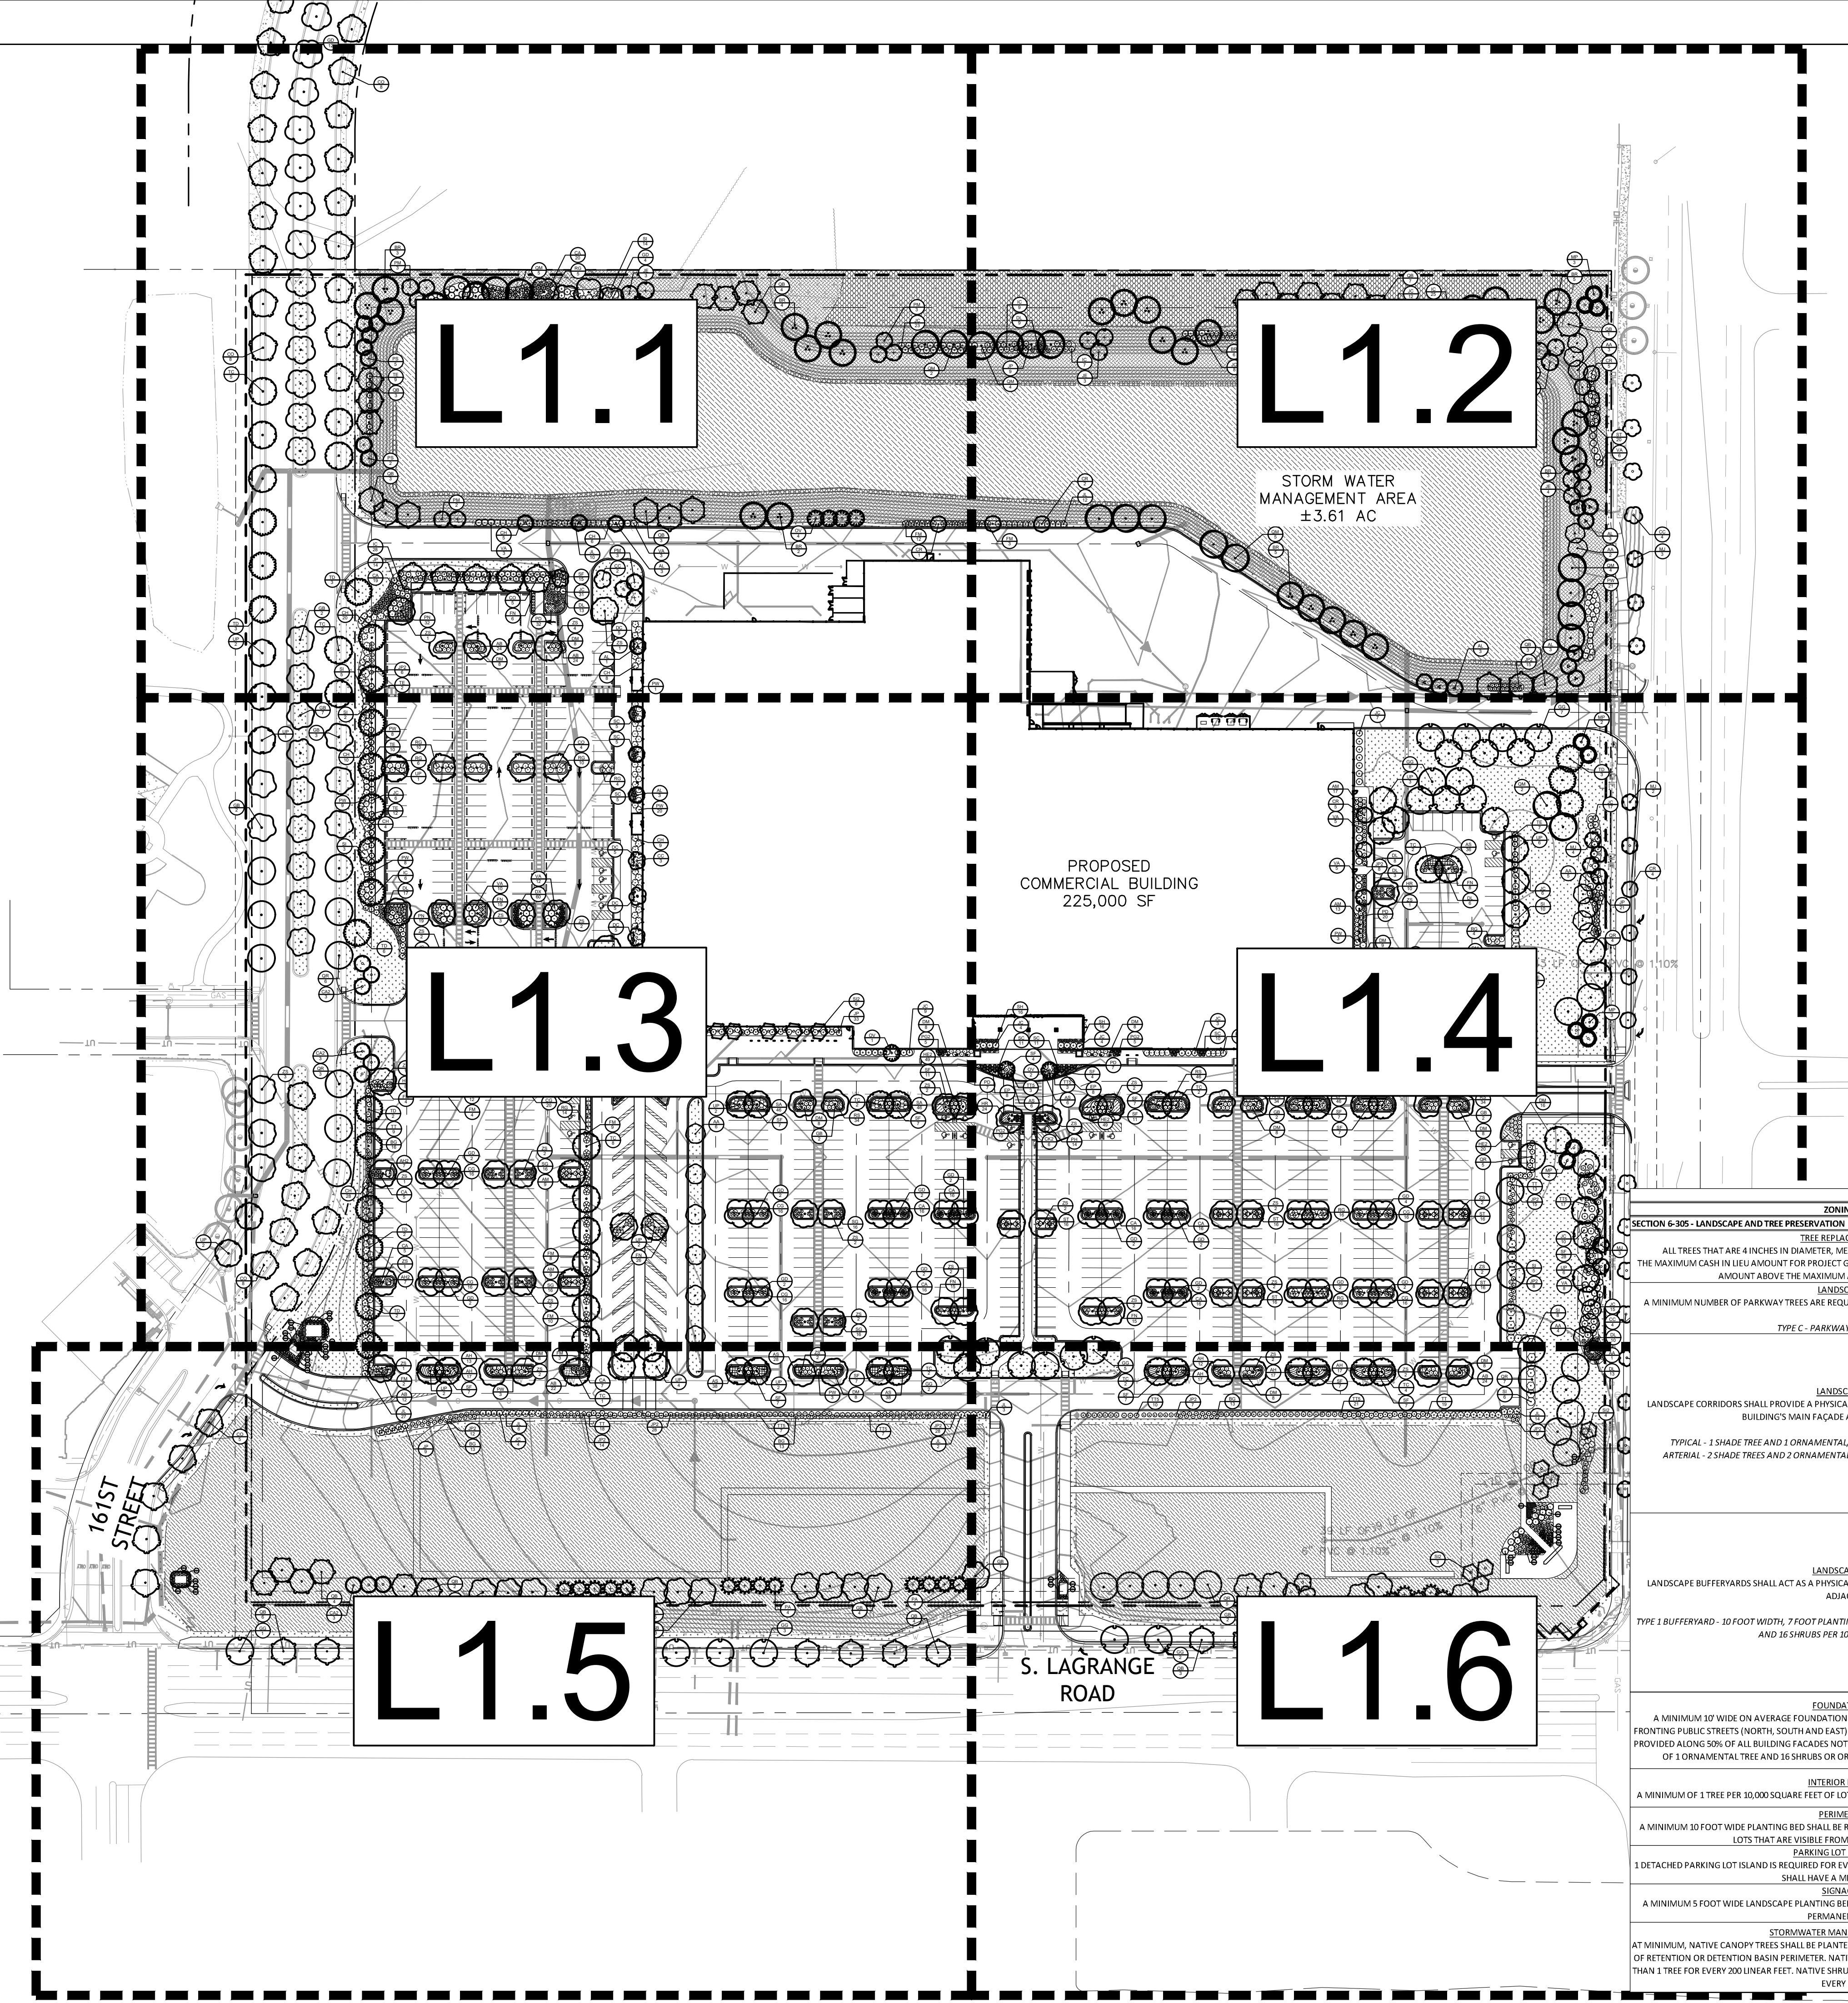


This document, together with the concepts and designs presented herein, is intended only for the specific purpose and client for which it was prepared. Reuse of and improper reliance on this document without written authorization and adaptation by Kimley-Horn and Associates, Inc. shall be without liability to Kimley-Horn and Associates, Inc.

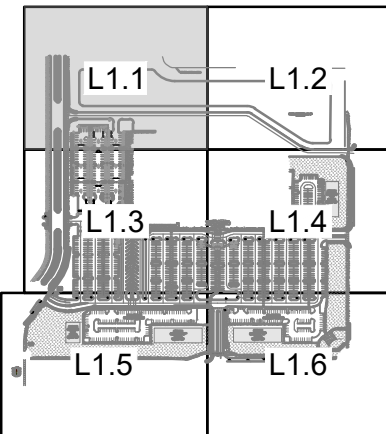

ORLAND PARK, IL - LANDSCAPE CODE REQUIREMENTS		
ZONING ORDINANCE	REQUIRED	PROPOSED
SECTION 6-305 - LANDSCAPE AND TREE PRESERVATION		
TREE REPLACEMENT STANDARDS: ALL TREES THAT ARE 4 INCHES IN DIAMETER, MEASURED 4 FEET FROM THE GROUND, SHALL BE REPLACED. THE MAXIMUM CASH IN LIEU AMOUNT FOR PROJECT GREATER THAN 10 ACRES IN AREA IS \$100,000, ANY CASH IN LIEU AMOUNT ABOVE THE MAXIMUM AMOUNT WILL BE WAIVED BY THE VILLAGE.	* SEE SHEETS TP1.0-TP2.0 FOR TREE PRESERVATION PLAN *	TOTAL SITE ACREAGE: 35.1 AC TOTAL FEE IN LIEU: \$127,050 \$100,000 FEE IN LIEU TO BE PROVIDED
LANDSCAPE PARKWAYS: A MINIMUM NUMBER OF PARKWAY TREES ARE REQUIRED PER LINEAL FEET OF FRONTAGE FOR ALL DEVELOPMENT.	PARKWAY TREES REQUIRED ALONG LA GRANGE ROAD, W 159TH STREET AND W 161ST STREET	PARKWAY TREES PLANTED 40 FEET O.C. PROVIDED ALONG LA GRANGE ROAD, W 159TH STREET AND W 161ST STREET
TYPE C - PARKWAY TREES 40 FEET ON CENTER	ARTERIAL CORRIDOR: LENGTH OF LA GRANGE ROAD = 1,362 LF 1,362 LF / 100 LF = 13.62 13.62 x 2 TREES = 27.24 27 SHADE TREES & 27 ORNAMENTAL/EVERGREEN TREES REQUIRED ALONG LA GRANGE ROAD	27 SHADE TREES, 9 ORNAMENTAL TREES AND 18 EVERGREEN TREES PROVIDED ALONG LA GRANGE ROAD
LANDSCAPE CORRIDORS: LANDSCAPE CORRIDORS SHALL PROVIDE A PHYSICAL AND VISUAL CONNECTION BETWEEN THE PARKWAY AND A BUILDING'S MAIN FAÇADE AND FOUNDATION PLANTING AREA.	ARTERIAL CORRIDOR: LENGTH OF 159TH STREET = 997 LF 997 LF / 100 LF = 9.97 9.97 x 2 TREES = 19.94 20 SHADE TREES & 20 ORNAMENTAL/EVERGREEN TREES REQUIRED ALONG 159TH STREET	20 SHADE TREES AND 30 ORNAMENTAL TREES PROVIDED ALONG 159TH STREET
TYPICAL - 1 SHADE TREE AND 1 ORNAMENTAL/EVERGREEN TREE PER 100 FEET OF CORRIDOR LENGTH ARTERIAL - 2 SHADE TREES AND 2 ORNAMENTAL/EVERGREEN TREES PER 100 FEET OF CORRIDOR LENGTH	TYPICAL CORRIDOR: LENGTH 161ST STREET = 1,265 LF 1,265 LF / 100 LF = 12.65 13 SHADE TREES & 13 ORNAMENTAL/EVERGREEN TREES REQUIRED ALONG 161ST STREET	13 CANOPY TREES, 6 ORNAMENTAL TREES AND 7 EVERGREEN TREES PROVIDED ALONG 161ST STREET
LANDSCAPE BUFFERYARDS: LANDSCAPE BUFFERYARDS SHALL ACT AS A PHYSICAL AND VISUAL EYE BETWEEN THE SIDE AND REAR YARDS OF ADJACENT PARCELS.	TYPE 1 BUFFERYARD: NORTH PROPERTY LINE = 1,287 LF 1,287 LF / 100 LF = 12.87 12.87 x 3 SHADE TREES = 38.61 = 39 SHADE TREES REQUIRED 12.87 x 1 ORNAMENTAL/EVERGREEN TREE = 12.87 = 13 ORNAMENTAL/EVERGREEN TREES REQUIRED 12.87 x 16 SHRUBS = 205.92 = 206 SHRUBS REQUIRED	39 SHADE TREES, 9 ORNAMENTAL TREES, 4 EVERGREEN TREES AND 206 SHRUBS PROVIDED ALONG THE NORTH PROPERTY LINE
TYPE 1 BUFFERYARD - 10 FOOT WIDTH, 7 FOOT PLANTING BED AND 3 SHADE TREES, 1 ORNAMENTAL/EVERGREEN TREE AND 16 SHRUBS PER 100 FEET OF BUFFERYARD LENGTH	TYPE 1 BUFFERYARD: WEST PROPERTY LINE = 1,245.82 LF 1,245.82 LF / 100 LF = 12.46 12.46 x 3 SHADE TREES = 37.38 = 37 SHADE TREES REQUIRED 12.46 x 1 ORNAMENTAL/EVERGREEN TREE = 12.46 = 12 ORNAMENTAL/EVERGREEN TREES REQUIRED 12.46 x 16 SHRUBS = 199.36 = 199 SHRUBS REQUIRED	41 SHADE TREES, 8 EVERGREEN TREES AND 199 SHRUBS PROVIDED ALONG THE WEST PROPERTY LINE
FOUNDATION LANDSCAPE: A MINIMUM 10' WIDE ON AVERAGE FOUNDATION LANDSCAPE AREA ALONG 100% OF ALL BUILDING FAÇADES FRONTING PUBLIC STREETS (NORTH, SOUTH AND EAST), A MINIMUM 7' WIDE FOUNDATION LANDSCAPE AREA SHALL BE PROVIDED ALONG 50% OF ALL BUILDING FAÇADES NOT FRONTING A PUBLIC STREET (WEST). ON AVERAGE, A MINIMUM OF 1 ORNAMENTAL TREE AND 16 SHRUBS OR ORNAMENTAL GRASSES FOR EVERY 100' OF BUILDING FACE.	TOTAL LENGTH OF BUILDING FACE = 2,201.93 LF 2,201.93 LF / 100 LF = 22.02 22.02 x 1 ORNAMENTAL TREE = 22.02 = 23 ORNAMENTAL TREES REQUIRED 22.02 x 16 SHRUBS/GRASSES = 352.32 = 352 SHRUBS/GRASSES REQUIRED	22 ORNAMENTAL TREES AND 352 SHRUBS/ORNAMENTAL GRASSES PROVIDED ALONG THE BUILDING FAÇADE
INTERIOR LOT LANDSCAPING: A MINIMUM OF 1 TREE PER 10,000 SQUARE FEET OF LOT AREA FOR COMMERCIAL/OFFICE DEVELOPMENT IS REQUIRED.	TOTAL AREA OF DEVELOPMENT = 1,527,310.29 SQ.FT 1,527,310.29 SQ.FT / 10,000 SQ.FT = 152.73 153 TREES REQUIRED	153 CANOPY AND EVERGREEN TREES PROVIDED THROUGHOUT THE SITE
PERIMETER SCREENING: A MINIMUM 10 FOOT WIDE PLANTING BED SHALL BE REQUIRED AROUND THE PERIMETER OF ALL REQUIRED PARKING LOTS THAT ARE VISIBLE FROM ADJACENT PROPERTIES AND STREETS.	PARKING LOT PERIMETER SCREENING REQUIRED ALONG LA GRANGE ROAD, 159TH STREET AND 161ST STREET	PARKING LOT PERIMETER SCREENING PROVIDED ALONG LA GRANGE ROAD, 159TH STREET AND 161ST STREET
1 DETACHED PARKING LOT ISLAND IS REQUIRED FOR EVERY 10 PARKING SPACES PROVIDED. EACH PARKING LOT ISLAND SHALL HAVE A MINIMUM OF 1 SHADE TREE.	TOTAL NUMBER OF PARKING SPACES = 857 SPACES 857 SPACES / 10 SPACES = 85.7 86 PARKING LOT TREES REQUIRED	86 TREES PROVIDED WITHIN PARKING LOT ISLANDS
SIGNAGE LANDSCAPE: A MINIMUM 5 FOOT WIDE LANDSCAPE PLANTING BED SHALL BE INSTALLED AROUND THE ENTIRE BASE OF ALL NEW PERMANENT GROUND SIGNS.	SIGNAGE LANDSCAPE REQUIRED AROUND ALL NEW SIGNS	SIGNAGE LANDSCAPE PROVIDED AROUND ALL NEW SIGNS
STORMWATER MANAGEMENT AREA LANDSCAPE: AT MINIMUM, NATIVE CANOPY TREES SHALL BE PLANTED AT A RATIO NOT LESS THAN 1 TREE FOR EVERY 100 LINEAR FEET OF RETENTION OR DETENTION BASIN PERIMETER. NATIVE UNDERSTORY TREES SHALL BE PLANTED AT A RATIO NOT LESS THAN 1 TREE FOR EVERY 200 LINEAR FEET. NATIVE SHRUBS SHALL BE PLANTED AT A RATIO NOT LESS THAN 3 SHRUBS FOR EVERY 500 LINEAR FEET.	TOTAL BASIN PERIMETER LENGTH = 2,535.05 LF 2,535.05 LF / 100 LF = 25.35 = 1 SHADE TREE = 25.35 = 25 SHADE TREES REQUIRED 2,535.05 LF / 200 LF = 12.68 = 12.68 x 1 ORNAMENTAL TREE = 12.68 = 13 ORNAMENTAL TREES REQUIRED 2,535.05 LF / 50 LF = 50.70 x 3 SHRUBS = 153.10 = 153 SHRUBS REQUIRED	25 SHADE TREES, 13 ORNAMENTAL TREES AND 152 SHRUBS PROVIDED AROUND THE DETENTION POND PERIMETER

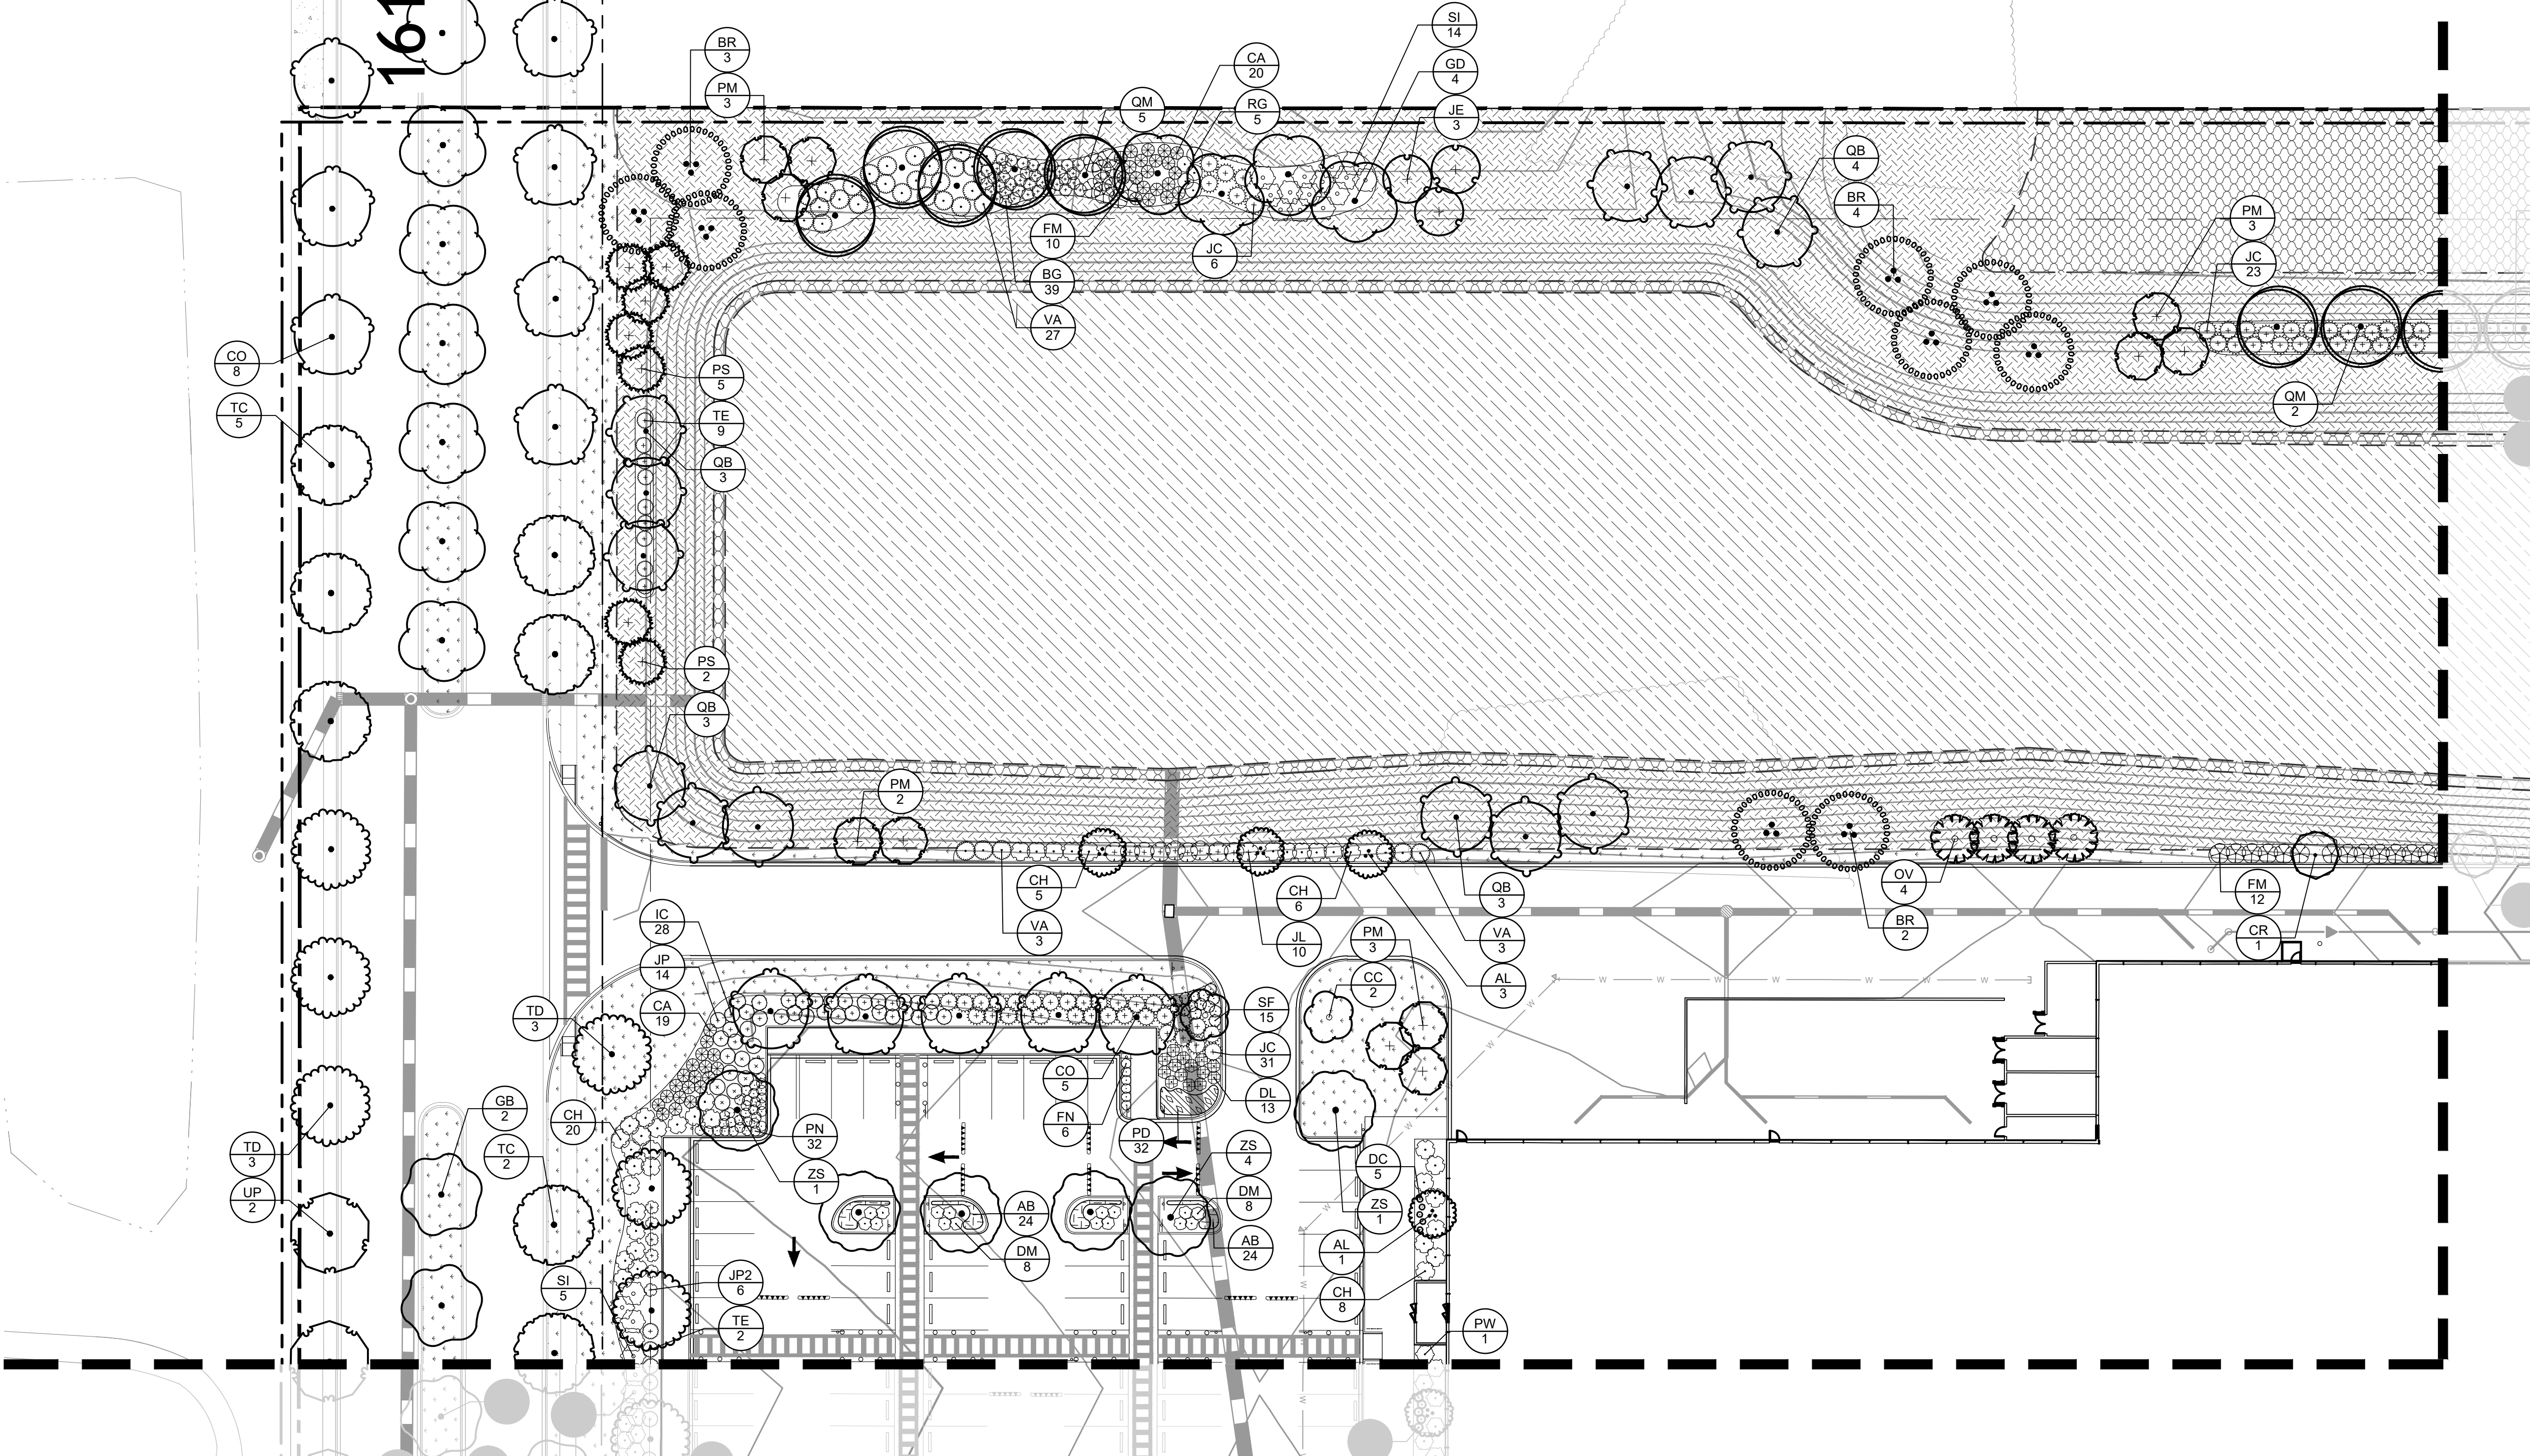


KEY MAP:
1" = 800'

CONCEPT PLANT SCHEDULE



EXISTING TREE

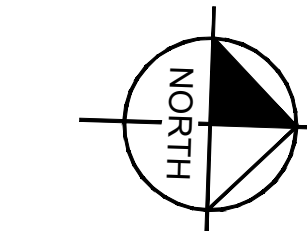

GRAPHIC SCALE IN FEET

A horizontal line with tick marks at 0, 15, 30, and 60. The segment between 0 and 15 is white, 15 and 30 is black, 30 and 45 is white, and 45 and 60 is black.

PLANT SCHEDULE

SYMBOL	CODE	ITALIAN / COMMON NAME
	AA	ACER F. FREEMAN / ARMSTRONG / ARMSTRONG FREEMAN MAPLE
	CO	CELTIS OCCIDENTALIS / COMMON HACKBERRY
	GB	GINO BO BULBAIN GOLD / AUTUMN GOLD GINKGO - MALE ONLY
	GS	GLEDITSIA TRACANTHOS NERNES / GREEN GLORY / GREEN GLORY HONEY LOCUST
	GY	GYMNOCLADUS DIOICUS / KENTUCKY COFFEETREE
	ZK	NYSSA SYRIACA BLACK PLETO
	QB	QUERCUS BICOLOR / SWAMP WHITE OAK
	QM	QUERCUS MACROCARPA / BLUR OAK
	QR	QUERCUS RUBRA / RED OAK
	TD	TAXODIUM DISTICHUM / BALD CYPRESS
	TL	TELLA AMERICANA / SICKENTREE / SICKENTREE SINGLE STEM
	UP	ULMUS AMERICANA / PRINCETON / PRINCETON AMERICAN ELM
DISCOGNITIVE TREES		
	JE	JUNIPERUS VIRGINIANA / EASTERN REDCEDAR
	PA	POEA ABIES / NORWAY SPRUCE
	PS	PNUS STROBUS / WHITE PINE
	PM	PIUEDOTODA MENZIESI / DOUGLAS FIR
	EH	TSUGA CANADENSIS / EASTERN HEMLOCK
ORIENTAL TREES		
	AL	AMELANCHIER LAEVIS / ALLEGHENY SERVICEBERRY - MULTI STEM
	BR	BETULA LAURNA / RIVER BIRCH - MULTISTEM
	CA2	CARPINUS CAROLINIANA / AMERICAN HORNBEAM - SINGLE STEM
	CC	CERCIS CANADENSIS / EASTERN REDBUD - SINGLE STEM
	CR	CRATAEGUS CRUS-GALLI VAR. INERMIS / COCKSPUR HAWTHORN - SINGLE STEM
	MJ	MALUS X JEWELCOLE / RED JEWEL™ CRABAPPLE - SINGLE STEM
	MP	MALUS X WAFFLEIR / WAFFLEPIRE CRABAPPLE - SINGLE STEM
	SV	SYRTIA VIRGINIANA / AMERICAN HOPHORNBEAM - SINGLE STEM
	OZ	OSTRYA PETIOLATA / HORYS BUL / HORYS SILK JAPANESE LLAC - SINGLE STEM

AM	ARONA MELANCAURA MONTONI / TROUSERS BEAUTY BLACK CHOKERSKY
ALB	ARONA MELANCAURA UCCOMINI / T / LOW SCAP MOUND BLACK CHOKERSKY
CA	CEROTHUS AMERICUS / NEW JERSEY TEE
CH	CEUNTHA ABAL BALHAI / T / IVORY HAD DOGGED
CG	COGRO SANQUINA / CANTO / ARTIC / BORN BLOODING DOGGED
CD	DEUTZA X NADEN / T / KUO SNOWFLAKE DEUTZA
DL	DERIVILLA LONGERA / DWAIF BUSH HONEYDEW
FM	FORTHYSTA INTEREDIA NADUR / SHOW OFFICE FORTHYSTA
FN	FORTHYSTA INTEREDIA NADUR / SHOW OFFICE SUGAR BAYN DWAIF FORTHYSTA
PH	PHYCOSAPUS CHULIFULUS DONAY / T / LITTLE DEW DWAIF NINEKAK
PM	PHYCOSAPUS CHULIFULUS TENARD / SUMMER WINE NINEKAK
PN	POTENTIAL FRUITFULOSA GLOW DROP / GOLD DROP BUSH CINQUEFOIL
RG	RUBS AROMATICA GLOWLOW / GLOWLOW FRAGRANT SUMOW
ST	SPINREA BETULIFOLIA TOR GOLD / T / GLOW GOR BRICHLAF SPREEA
SG	SPINREA ANONICA NEW FLAY / DOUBLE FLAY GOLD SPREEA
SI	SPINREA ANONICA NEON FLAY / NEON FLAY ANONICA SPREEA
SI	SYRINGA MYRTES PALDEN / DWAIF KOREAN LALC
VB	VERBENA DENDRANTICA CHRISTOM / T / BLUE MUFFIN AROMWOODW VERBENA

✓	BG	BULUS X GREEN VELVET / GREEN VELVET BOWWOOD
✓	IC	LE E. MERRIVALE CHINA ROY / CHINA BOYHOLLY
✓	JG	JUNIPERUS CHINENSIS SEA GREEN / SEA GREEN JAVANICA
✓	A	JUNIPERUS CHINENSIS SOLD LACE / GOLD LACE JAVANICA
✓	JP	JUNIPERUS CHINENSIS KALLAYS COMPACT / KALLAY COMPACT FITZGER JAVANICA
✓	JP2	JUNIPERUS COMMUNIS HORIZONTALIS / HORIZONTAL JAVANICA
✓	TS	FINUS MUO PUN. PUMILO / DWARF MUGGINE
✓	TT	TAKEA NODA EVER/DOW / EVER/DOW ANGLO-JAPANESE YEW
✓	TT	TAXUS X MEDA TAIKUNO / TAIKUNO ANGLO-JAPANESE YEW
GRASSES		
✓	OK4	ANDROPOGON GERARDI BLACKWATER / BLACKWATER BIG BLUESTEM
✓	AK	ANDROPOGON GERARDI RED BLOOMER / RED BLOOMER BIG BLUESTEM
✓	OK	CALAMAGOSTIS X AUFUTED HAWK FORESTIER / HAWK FORESTIER FEATHER REED
✓	DC	DESCOMBESIA CUSPIDATA / TUFTED GRASS
✓	PH	PANICUM VIRGATUM HEAVY METAL / HEAVY METAL SWITCH GRASS
✓	PQ2	PANICUM VIRGATUM NORTHWARD / NORTHWARD SWITCH GRASS
✓	FP	PENETSETIA ALDOPEDICEDS POULET / POULET DWARF MOUNTAIN GRASS
✓	SC	SCHENCHLIANUS SCOPARIUM CAROUSEL / CAROUSEL LITTLE BLUESTEM
✓	SH	SPOROBOLUS HETEROPHYLLS / FRAMME DROPPED

	AH	ACHILLEA MILEFOLIUM 'STRAWBERRY SELECTION' / STRAWBERRY SELECTION COMMON YARROW
	AS	ALLIUM X 'SUMMER BEAUTY' / SUMMER BEAUTY ORNAMENTAL ONION
	AW	ARISMA TARNAMENTANUM 'BLUE ICE' / BLUE ICE EASTERN BLUESTAR
	AH2	ASPIDISTRA FURGOSIA 'YELLOW VIBRO' / YELLOW VIBRO BUTTERFLY MILKWED
	EP	HEMICALIX X 'PICA BELLA' / PICA BELLA CORNFLOWER
	HE	EREMOCALIX S 'HAPPY RETURN' / HAPPY RETURN DELVAY
	HE2	NORITA PASSERINI 'WANDERS' LOW / WANDERS LOW CANTARY
	FD	PENSTEMON DIGITALIS / BEARDTONGUE
	RS	RUBRODIA FLUGIDA 'LITTLE GOLDSTAR' / LITTLE GOLDSTAR BLACKEYED JOY
	SA	SEDUM X 'AUTUMN JOY' / AUTUMN JOY SEDUM

[illegible]

Kimley»»Horn

© 2025 KIMLEY-HORN AND ASSOCIATES, INC.
4201 WINFIELD ROAD, SUITE 600
WARRENVILLE, IL 60555
630-487-5550
WWW.KIMLEY-HORN.COM

LICENSED PROFESSIONAL

XXX

ILLINOIS LICENSE NUMBER

XXX

TE: 11/14/2025

KHA PROJECT
149621089

149621089

DATE
11/14/2025

FE AS SHO

DESIGNED BY X

CKED BY X



LANDSCAPE PLAN

159TH & LAGRANGE
RETAIL

ILLINOIS

CITY OF ORLAND PARK

SHEET NUMBER
L1.1

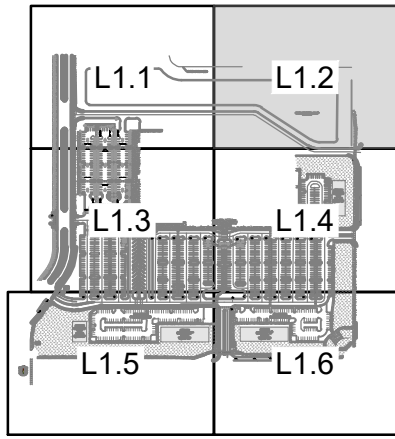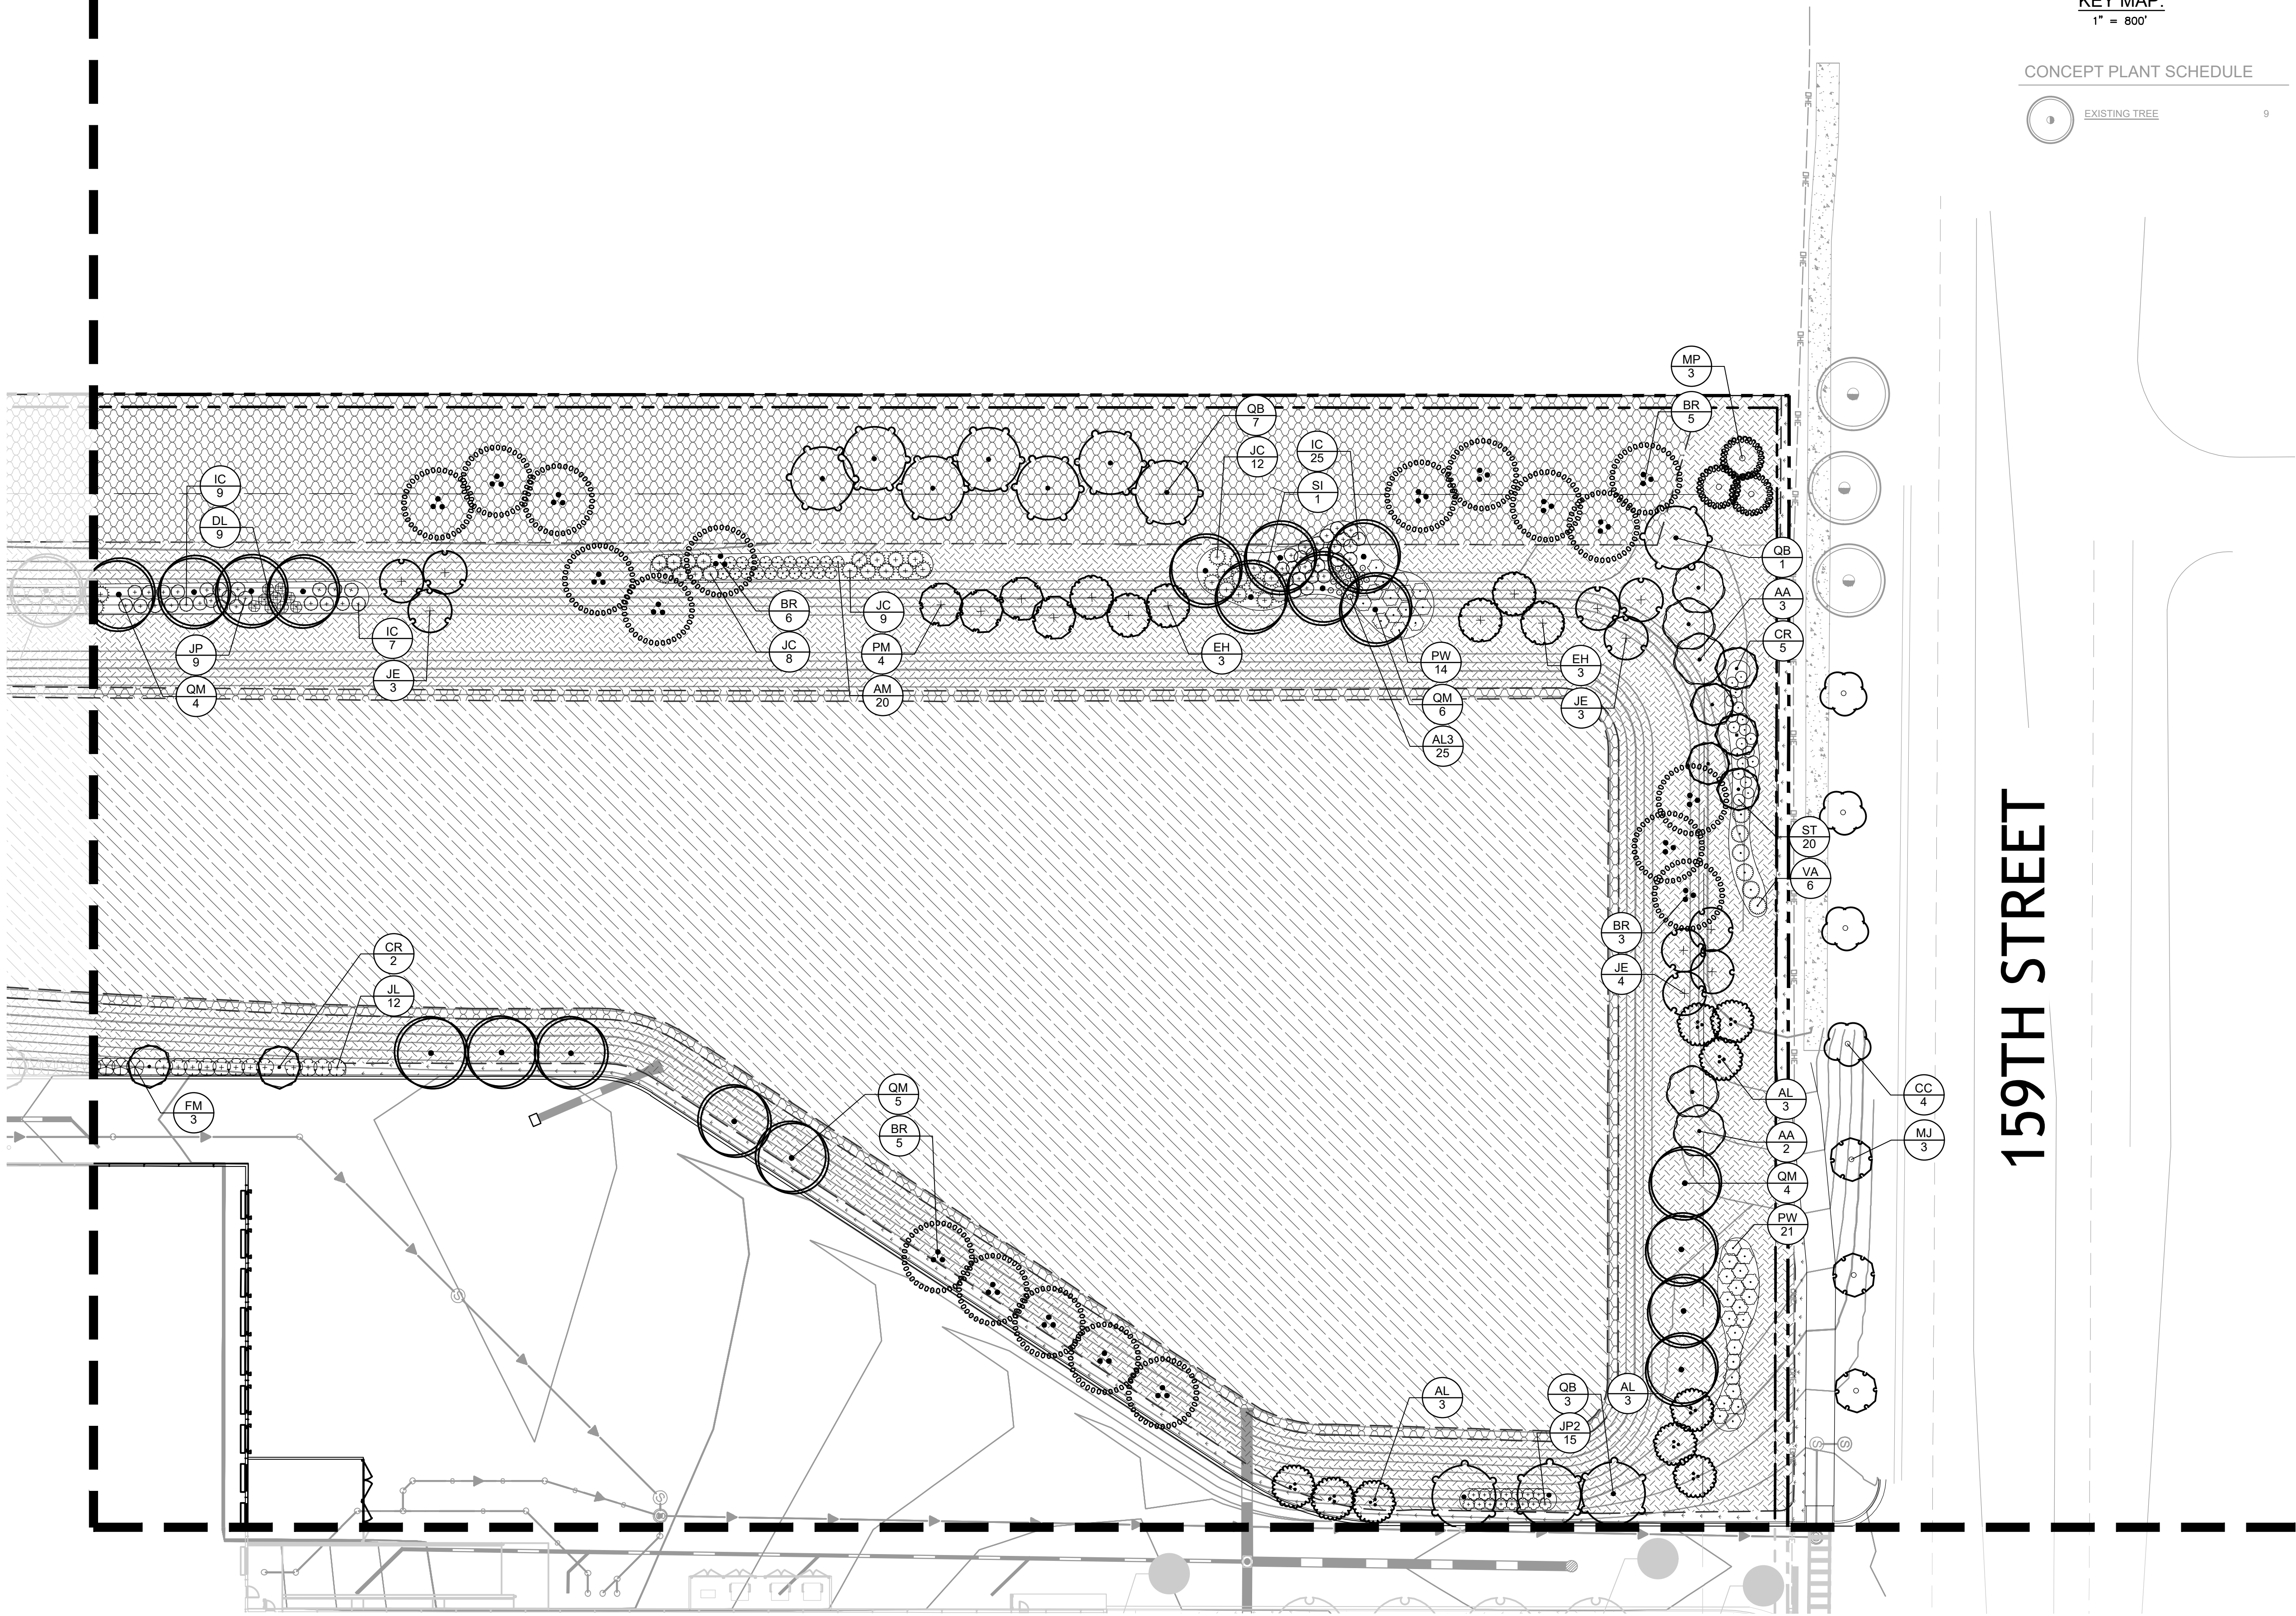


KEY MAP:
1" = 800'

CONCEPT PLANT SCHEDULE



EXISTING TREE

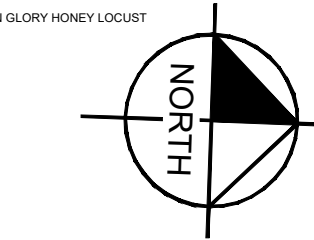

GRAPHIC SCALE IN FEET




0 15 30 60

SYMBOL	CODE	SYMBOL	COMMON NAME
TRIANGLES			
	AC	ACER X FREEMANII	AMERICAN
	CO	CELTIS OCCIDENTALIS	COMMON
	GR	GRAPIS BLOOMI	PUTNAM GUM
	GL	GLEDITSIA TRIACANTHOS	THORN
	GP	GYNOCARDIUM DODGEI	HEAVY
	NS	NYSSA FLAVATICA	BLACK FLAT
	QR	QUERCUS BICOLO	R. HAMPA
	QM	QUERCUS MACROCARPA	R. BUR
	QR	QUERCUS RUBRA	RED OAK
	TD	TAXODIUM DISTICHUM	BALD
	TC	TELLIA AMERICANA	MODICUM
	LP	ULMUS AMERICANA	PRINCECTO
QUADRANGULARS			
	JE	JUNIPERUS VIRGINIANA	EAST
	PC	PICA AERIS	NORMAN SPRUCE
	PN	PRINUS SPINOSA	WHITE PINE
	PD	PRINUS DUMETORUM	ROSE
	EH	TEUGA CANADENSIS	DOUGL
PENTAGONALS			
	AL	AMELANCHIER ALBIS	VALDES
	BE	BETULA NIGRA	RIVER BIRCH
	CA	CAMPNUS CAROLINIANUS	AMAR
	CC	CEDRUS CANADENSIS	EASTERN
	CR	CRATAEGUS CRIS-GALLI	VAR
	ML	MALLUS X ZWEIFELI	DOUGL
	PH	PHILODENDRON	FRAGRANS
	OV	QUERCUS VIRGINIANA	NORTH
	SI	SYMPLOCARUS RETICULATA	VIOXY
HEXAGONS			
	AM	ARALIA MONTANA	NORTH
	AL	ARUNDO CANADENSIS	COMMON
	CA	CELANANDELES AMERICANA	HEAVY
	CH	CONIUS ALBA	WALNUT TREE
	CS	CONIUS SARGENTII	DOUGL
	DE	DEUTZIA X NUTTI	YUKON BIRCH
	DM	DIKELLIA LANCEOLATA	OWENS
	FM	FOETIDUS X KENTWEDDA	NORTH
	FM	FOETIDUS X KENTWEDDA	NORTH
	QM	PHYSCOCARPUS OPULIFOLIS	DOUGL
	PM	PHYSCOCARPUS OPULIFOLIS	DOUGL
	PN	POTENTILLA PRATENSIS	COMMON
	RG	RHUS AMERICANA	DOUGL
	SP	SPHRAE JAPONICA	TORUS
	SP	SPHRAE JAPONICA	TORUS
	SP	SPHRAE JAPONICA	TORUS
	VA	VERBENA DENTATUM	CHERRY
OCTAGONALS			
	BU	BUXUS X GREENEVELT	CRIST
	CH	CLEX X MEDICINALE	CHINA BIRCH
	CH	CHAMAECIPARUS	SEA
	A	JANPHERUS CHINENSIS	DOUGL
	J	JANPHERUS CHINENSIS	DOUGL
	J2	JANPHERUS CHINENSIS	DOUGL
	TS	TRIS PINGUS MEDIO	PABLO DOUGL
	TG	TALUS X MEDIA	EVLIN DOUGL
	TG	TALUS X MEDIA	TANFONY
NONAGONALS			
	OK	ANDROPHEUM HERABARDI	REAR
	OK	ANDROPHEUM HERABARDI	REAR
	OK	CALAMAGOSTIS X ACUTIFOLIA	DOUGL
	OK	DECHAMPDIA CESTRIFLOA	TORUS
	PA	PANACOL VIRGINIANA	HEAVY
	P2	PANACOL VIRGINIANA	NORTH
	PN	PERNITENTIA APOTHECIS	DOUGL
	SC	SCHOCHEPHYLLUM SCOPARIUM	DOUGL
	SH	SPHROLELLUM RETICULATUM	DOUGL
DECAGONS			
	AS	ACHILLEA MELLEOLLOA	STRON
	AL	ALLIUM X SUMMERA	BEAUTY
	A2	ALLIUM SUMMERA	WALKERS
	AR	ARTEMESIA TUBEROSA	HEAVY
	AR	ARTEMESIA TUBEROSA	HEAVY
	EP	EPHEDRA X VICA	BELLA
	HE	HEMERICALLUS X NAPPY	HEAVY
	NE	NETEPA BENTHAMIS	WALKERS
	PE	PENTSTEMON DISTICUS	REAR
	RB	RUBRODIA PALLIDA	LETTLE
	SE	SEDA X NUTTII	YUK. AUTUM
UNDULATED			
		EMERGENT WETLAND PLANT	
		NO MOW TURF SEED MIX	
		POZZI NATIVE PLANT NURSERY	
		TURF SEED	
		WET MEADOW MIX	

[illegible]



[illegible]

This document, together with the concepts and designs presented herein, as an instrument of service, is intended only for the specific purpose and client for which it was prepared. Reuse of and improper reliance on this document without written authorization and adaptation by Kinney-Horn and Associates, Inc. shall be without liability to Kinney-Horn and Associates, Inc.

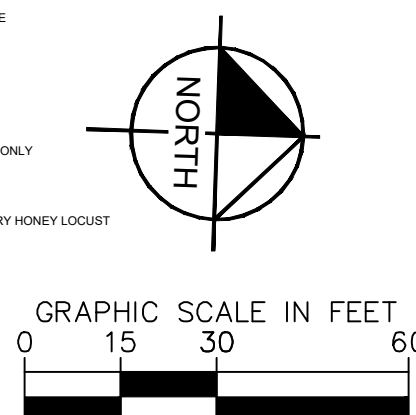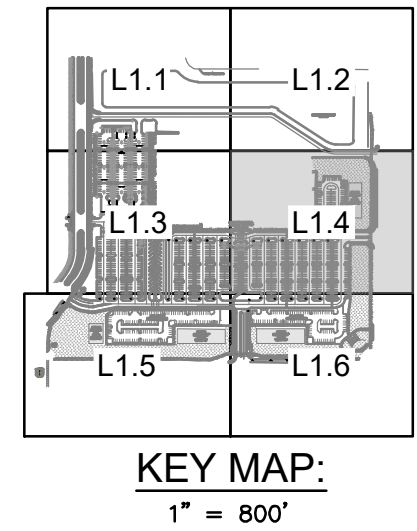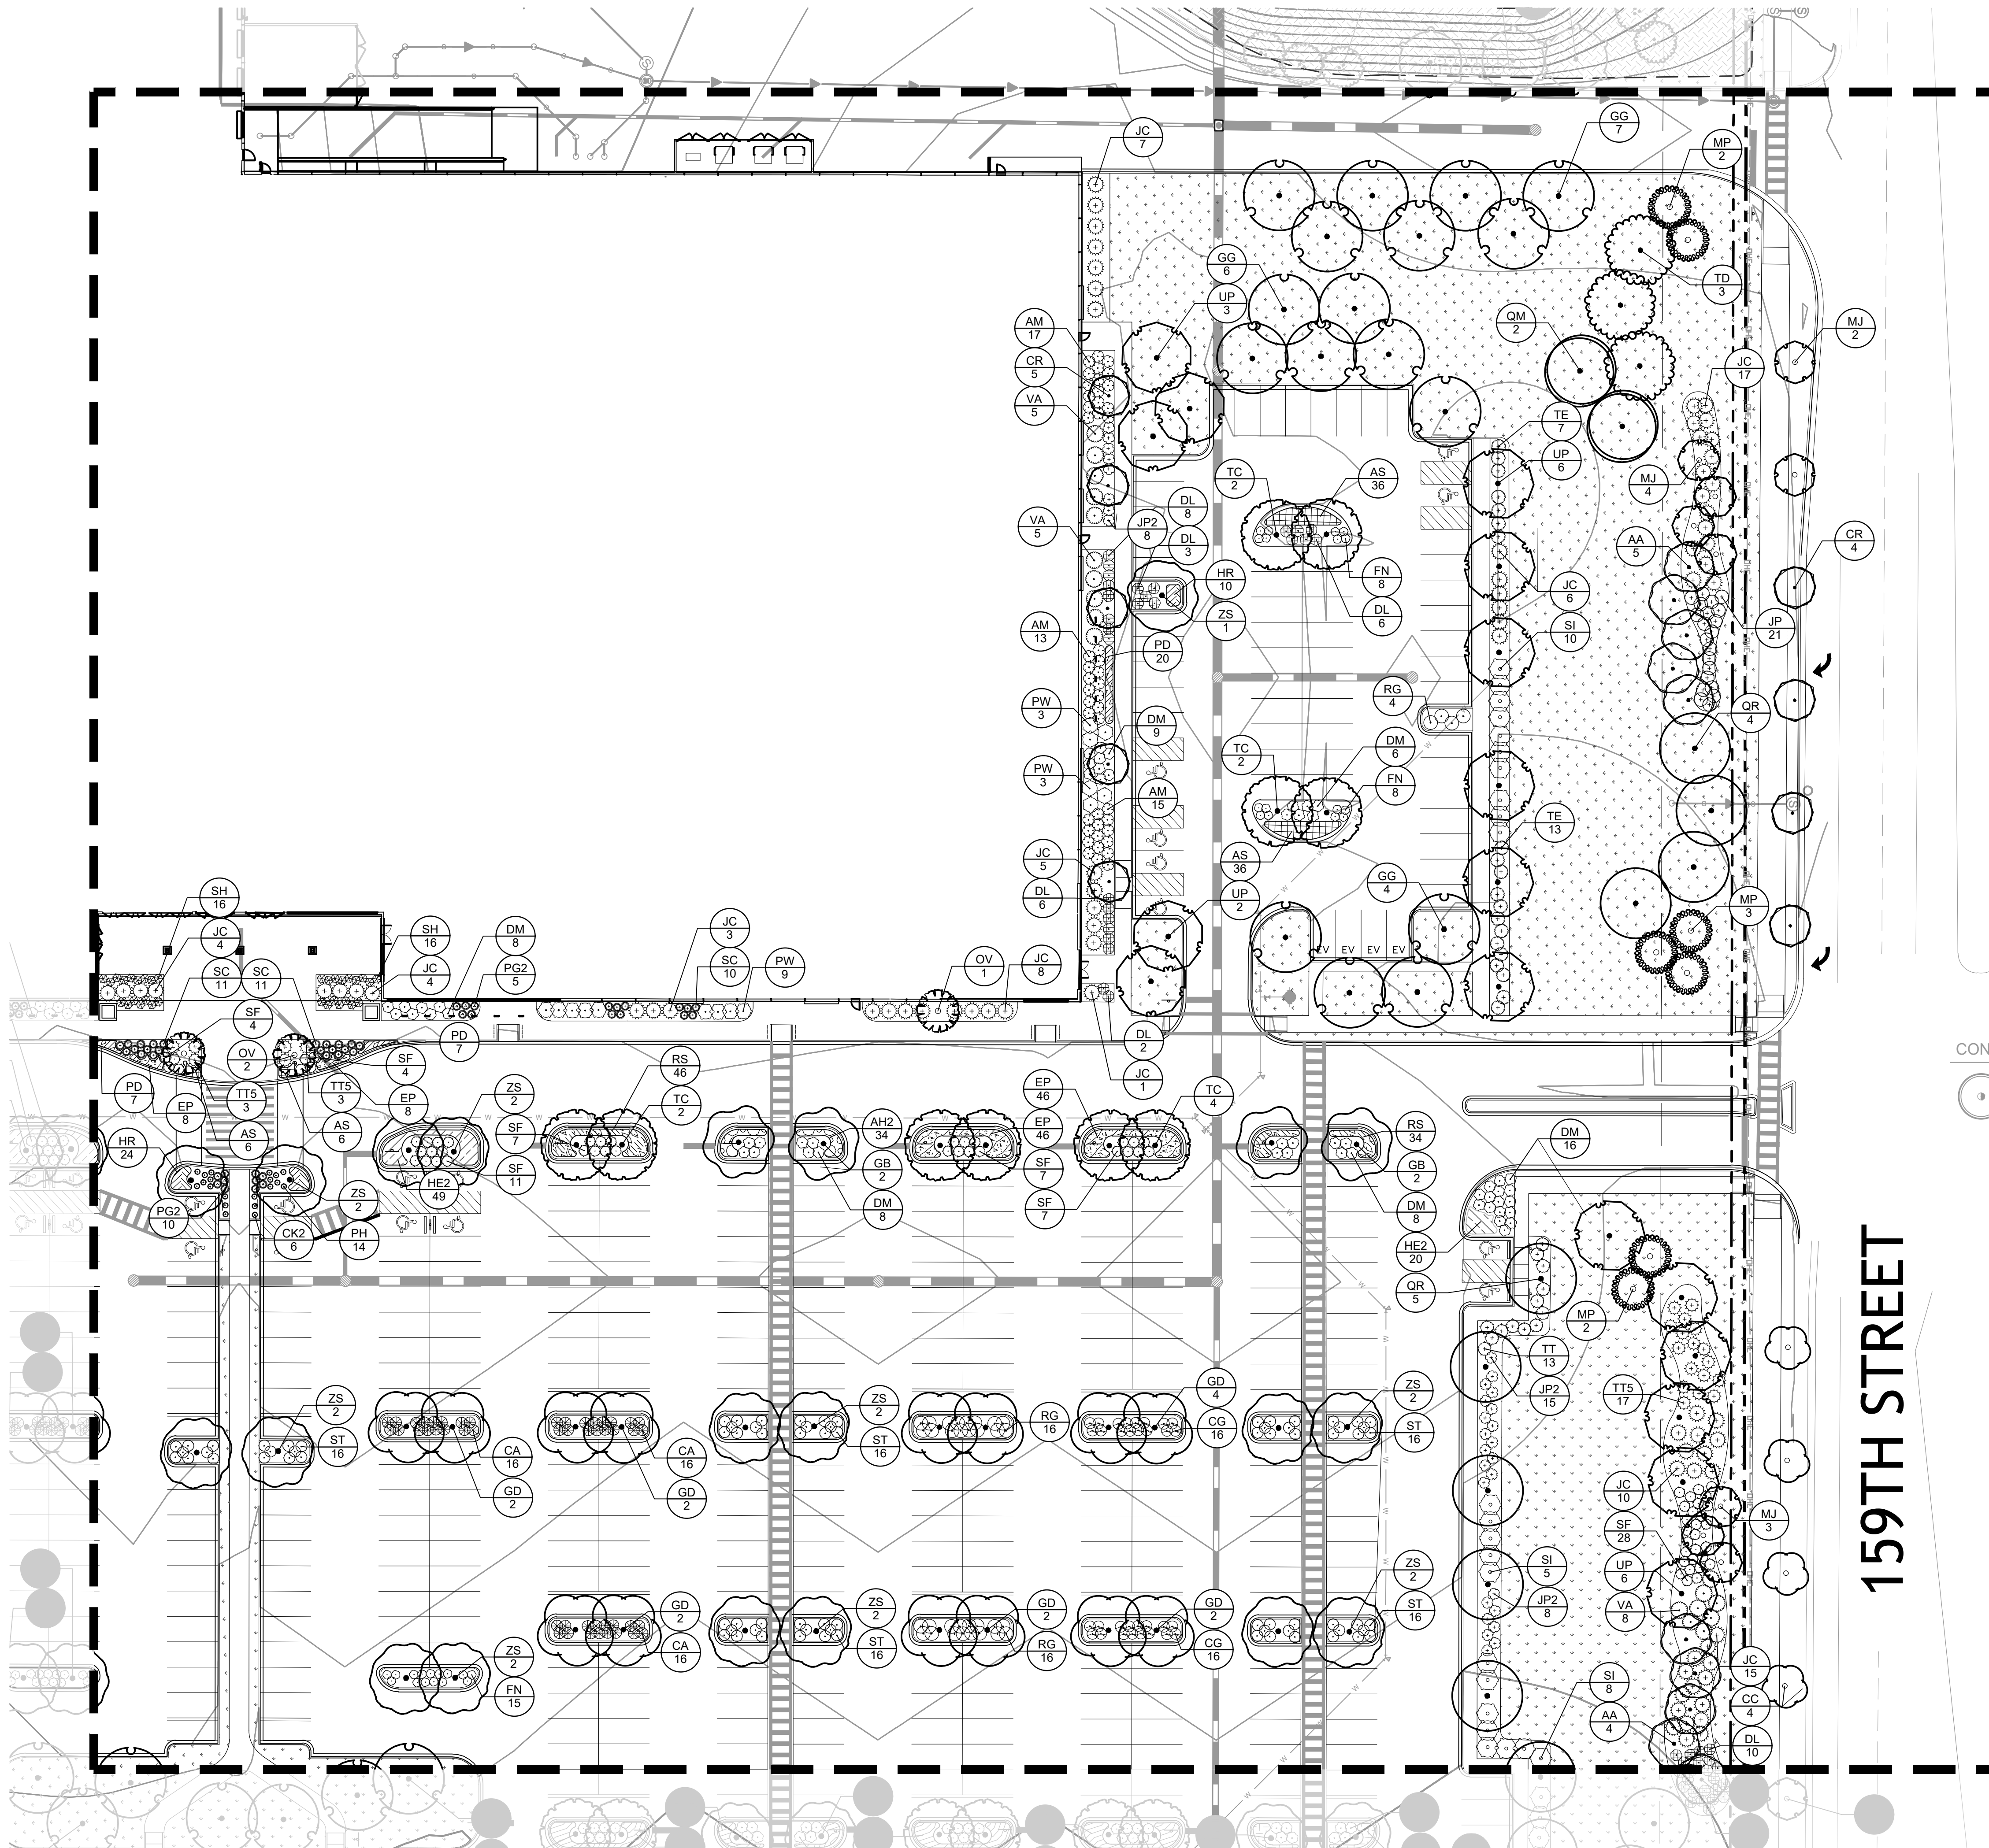

PLANT SCHEDULE		
SYMBOL	CODE	BOTANICAL / COMMON NAME
TREES		
	1A	ACER X FREEMAN/ ARMSTRONG/ ARMSTRONG FREEMAN MAPLE
	1D	CELTIS OCCIDENTALIS / COMMON HACKBERRY
	1B	GINSEO BLOBA AUTUMN GOLD / AUTUMN GOLD GINKGO - MALE ONLY
	1G	GLEDITSIA TRACANTHOSA INERMIS / GREEN GLORY / GREEN GLORY HONEY LOCUST
	1O	GYMNOCODIUM DIOGUS / KENTUCKY COFFEE TREE
	2S	NYSSA SYLVATICA / BLACK Tupelo
	1B	QUERCUS BICOLOR / SWAMP WHITE OAK
	1M	QUERCUS MACROCARPA / BURR OAK
	1R	QUERCUS RUBRA / RED OAK
	1D	TAXODIUM DISTICHUM / BALD CYPRESS
	1C	TILIA AMERICANA MOENCHTERRY / MOENCHTERRY LINDEN
	1P	ULMUS AMERICANA PRINCEYOT / PRINCEYOT AMERICAN ELM
SHRUBS / TREES		
	1E	JUNIPERUS VIRGINIANA / EASTERN REDCEDAR
	1A	PICEA ABIES / NORWAY SPRUCE
	1S	PNUS STROBUS / WHITE PINE
	1M	PRUNUS SP. MENZIES / DOUGLAS FR
	1H	QUERCUS CANADENSIS / EASTERN HEMLOCK
ORNAMENTAL TREES		
	1A	AMELANCHIER LAEVIS / ALLEGHENY SERVICEBERRY - MULTISTEM
	1R	BETULA NIGRA / RIVER BIRCH - MULTISTEM
	1A	CARULUS CAROLINIANA / AMERICAN HORNBEAM - SINGLE STEM
	1C	CERCIS CANADENSIS / EASTERN REDBUD - SINGLE STEM
	1R	CRATAEGUS CRUGS GALL VAR. NERIES / COCKSPOUR Hawthorn - SINGLE STEM
	1M	MALUS X JEWELCREEP / RED JEWEL™ CRABAPPLE - SINGLE STEM
	1P	MALUS X PRINCEYOT / PRINCEYOT CRABAPPLE - SINGLE STEM
	1O	OSTRYA VIRGINIANA / AMERICAN HYPHOCYPRESS - SINGLE STEM
	1S	SYRINGA RETICULATA / VIOLET SILEX / VIOLET SILK JAPANESE LILAC - SINGLE STEM
SHRUBS		
	1A	ARONIA MELANOCARPA MORTON TM / IRIDIOLUS BEAUTY BLACK CHOKERBERRY
	1A	ARONIA MELANOCARPA LUDWIGIANUS TM / LOW SPREAD MOUND BLACK CHOKERBERRY
	1C	CLETHRA ALABAMAENSIS / NEW JERSEY TEA
	1H	CORNUS ALBA BALMULHO TM / HOPF HALL DOGWOOD
	1G	COGONIS SANGUINATA / YAK / ARCTIC SNOW BLOOMING DOGWOOD
	1D	DEUTZIA X NEXITY™ / YUKI SNOW LANCES DEUTZIA
	1M	DIERVILLA LINDENIA / DWARF SHIBUYA HONEY SUEDE
	1F	FOESTYTHIA X INTERMEDIA MANDOR / SHOW OFFS FOESTYTHIA
	1F	FOESTYTHIA X INTERMEDIA MANDOR / SHOW OFFS SUGAR BABY DWARF FOESTYTHIA
	1P	PHYSCOCARPUS GRULIFOLUS DONNA MAY TM / LITTLE SEVIL DWARF NINEBARK
	1W	PHYSCOCARPUS OPHULIFOLUS SEWARD / SUMMER WINE NINEBARK
	1N	POTENTILLA FRUTICOSA GOLD DROP / GOLD DROP SHUB CHINESE POT
	1R	RAUBA ARIMATICA VIOLET TM / GROUND FRAGRANT RUWAC
	1S	SPIRAEA BETULIFOLIA TORI GOLD TM / GLOW GIRL BIRCHLEAF SPIREA
	1A	SPRAEA JAPONICA YAK / DREAMS PLAYS GOLD SPIREA
	1F	SPRAEA JAPONICA NEON FLASH / NEON FLASH JAPANESE SPIREA
	1M	SPRAEA MYERS / TALBIN / DWARF KOREAN LILAC
	1A	VERBUNUM DENTATUM CHRISTIN TM / BLUE MISTY FERN ARROWWOOD VERBUNUM
SHRUBS / TREES		
	1B	BUXUS X GREEN VELVET / GREEN VELVET BOWWOOD
	1C	ILEX X NERSENAE / CHINA BAY / CHINA ROSE HOLLY
	1D	JANPERUS CHENSIS / SEA GREEN / SEA GREEN JAMPER
	1A	JANPERUS CHENSIS GOLD LACE / GOLD LACE JAMPER
	1P	JANPERUS CHENSIS WALLAYS COMPACT / KALAY COMPACT JAMPER
	1J	JANPERUS CHENSIS WALLAYS COMPACT / HORIZONTAL JAMPER
	1S	PNUS MUGO VAR. PUMULO / DWARF MUGO PINE
	1T	TAUS X MEDIA ENTLOFF / ENTLOFF ARGOLO-JAPANESE YEW
	1T	TAUS X MEDIA TALINTON / TALINTONS ARGOLO-JAPANESE YEW
ORNAMENTAL		
	1C	ANDROPOGON GRAMEN / BLACK GRASS / BLACK GRASS BLUESTEM
	1R	ANDROPOGON GRAMEN / RED OCTOBER / RED OCTOBER BUD BUSTEM
	1C	CLAMAGRODYS X ACUTIFOLIA KARL FORSTER / KARL FORSTER FEATHER REED OR
	1H	DIENCAHIA CESTRIFOLIA / TUFTED HANGGRASS
	1P	PANICUM VIRGATUM HEAVY METAL / HEAVY METAL SWITCH GRASS
	1P	PANICUM VIRGATUM NORTHWARD / NORTHWARD SWITCH GRASS
	1S	PENNSYLVANIA ALONGRODINGS / PIGTAIL / INGLETS DWARF FOXTAIL GRASS
	1C	SCHIZACHYRIUM SCOPARIUM CAROUSEL / CAROUSEL LITTLE BLUESTEM
	1B	SPORODIOLUS HETEROPHYLLUS / PRAIRIE DROPSIDE
PERENNIALS		
	1A	ACHILLEA MILEFOLIUM STRAWBERRY SEDUCTION / STRAWBERRY SEDUCTION COMBO
	1H	ALLIUM X SUMMER BEAUTY / SUMMER BEAUTY ORNAMENTAL ORION
	1A	ARISMA TABERNAMONTANA BLUE ICE / BLUE ICE EASTERN BLUESTAR
	1M	ACELEPNA TURBOSA YELLOW VELLO / HELLO VELLO DWARF BUTTERFLY MILKWEED
	1P	ECORINCA X PICA BELLA / PICA BELLA COMEFLOR
	1H	HEPHERCOCALIS X WAPPY RETURNS / WAPPY RETURNS DAYLILY
	1R	NETEMTA FASSENII WALKERS LOW / WALKERS LOW CATANT
	1D	PESTEMONT DIGITALIS / BEARTONTOE
	1S	ROBERTIA PULGOSA LITTLE GOLD STARLET / LITTLE GOLDSTAR BLACK-EYED SUSAN
	1A	SEDUM X AUTUMN JUTZ / AUTUMN



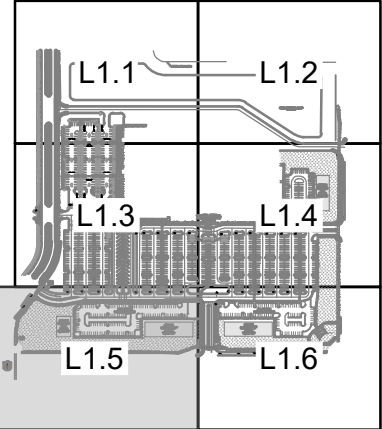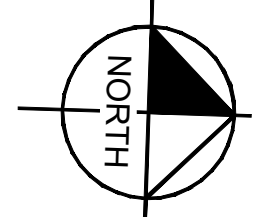














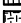







SHEET NUMBER L1.4		159TH & LAGRANGE RETAIL		ILLINOIS CITY OF ORLAND PARK		LANDSCAPE PLAN		<div>KHA PROJECT 149621089</div> <div>DATE 11/14/2025</div> <div>SCALE AS SHOWN</div> <div>DESIGNED BY ###</div> <div>DRAWN BY ###</div> <div>CHECKED BY ###</div>		<div>LICENSED PROFESSIONAL</div> <div>XXXX</div> <div>ILLINOIS LICENSE NUMBER XXXX</div> <div>DATE: 11/14/2025</div>		<div>Kimley»»Horn</div> <div>© 2025 KIMLEY-HORN AND ASSOCIATES, INC. 4201 WINFIELD ROAD, SUITE 600 WARRENVILLE, IL 60555 TEL: 630-399-1387 WWW.KIMLEY-HORN.COM</div>		<div>No.</div> <div>REVISIONS</div> <div>DATE</div> <div>BY</div>									
-----------------------------	--	--	--	--	--	-----------------------	--	---	--	--	--	---	--	---	--	--	--	--	--	--	--	--	--

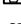


KEY MAP:
 $1'' = 800'$

FM	PIUEDOTOGUA MENZIESII (DOUGLAS FIR)
DH	TSUGA CANADENSIS / EASTERN HEMLOCK
ORNAMENTAL TREES	
AL	AMELANCHIER LAEVIS / ALLEDENTED SERVICEBERRY - MULTI STEM
BR	BETULA NIDRA / RIVER BIRCH - MULTISTEM
CA2	CARPINUS CAROLINIANA / AMERICAN HORNBEAM - SINGLE STEM
CC	CERCIS CANADENSIS / EASTERN REDBUD - SINGLE STEM
CR	CRATAEGUS CRUG-SLAW / NERISSE / COCKSPUR Hawthorn - SINGLE STEM
MJ	MALLUS X JEVENSKEOLE / RED JEWEL™ CRABAPPLE - SINGLE STEM
MP	MALLUS X 'PIRAIRIE' / 'PIRAIRIE' CRABAPPLE - SINGLE STEM
OV	OSTRYA VIRGINIANA / AMERICAN HORNBEAM - SINGLE STEM
S2	SYRINGA RETICULATA 'VORY SL' / VORY SL JAPANESE LILAC - SINGLE STEM
SHRUBS	
AM	ARONIA MELANOCARPA 'MORTON' / 'PIRAIRIE' BEAUTY BLACK CHERRYBERRY
AL3	ARONIA MELANOCARPA 'L'COONAH' / 'L'COON' LOW SPREAD MOULD BLACK CHERRYBERRY
CA	CEANOTHUS AMERICANS / NEW JERSEY TEA
GH	ORNIS ALBA 'BAHAI' / 'T' / 'VORY' HALO DOORWOOD
GS	CORUNUS SARGATA 'CATO' / ARCTIC SNOW BLOSSOM DOORWOOD
DK	DEUTZIA X 'NOXI' / 'VORY' SNOWFLAKE DEUTZIA
DL	DERFYLIA LONCEA / DWARF SHAW-HONEYLOCUST
FM	FORESYTHIA X 'KENTENDEA' MANDOR / SHAW OFFICE FORESYTHIA
FN	FORESYTHIA X 'KENTENDEA' MANDOR / SHAW OFFICE SUGAR BAYN'S DWARF FORESYTHIA
PH	PHYSCOCARPUS OPULIFOLUS 'DONNA MAY' / 'LITTLE DEB' DWARF ANEMONE

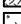PN	PW	PHYSOCALYPSA (HYALIS) SEMINUS / SUMMER WINE MARIKAK
PN	PH	PHYTOLACCA FRUTICOSA / GOLD DROP / GOLD DROP BUSH CINCQUEFO
PN	RG	PHYS. ARISTATA / GROUNDLOW / GROUNDLOW FRAGRANT SUMAC
ST	ST	SPINEA RETICULATA / TORO GOLD / GOLD ORG. BRICKFACE / SPINEA
ST	ST	SPINEA RETICULATA / YN / DOUBLE BLUE PLANT
ST	ST	SPINEA JAPONICA / NEON FLAME / NEON FLAME JAPANESE PLANT
ST	ST	SPINEA JAPONICA / NEON FLAME / NEON FLAME JAPANESE PLANT
ST	ST	STRONGA METERA / FALLEN / DOWNEY KOREAN LILAC
ST	VA	VERBENA DENTATA / CHRISTOM / BLUE HUFFERS / ARROWWOOD VERBENA
VERBENA SPECIES		
BO	BO	BUXUS X GREEN VELVET / GREEN VELVET BOWWOOD
IC	IC	ILEX X MESSERBEE / CHINA BOY / CHINA BOY HOLLY
JC	JC	JUNIPERUS CHINENSIS / SEA GREEN / SEA GREEN JUNIPER
J	J	JUNIPERUS CHINENSIS / GOLD LACE / GOLD LACE JUNIPER
J	J	JUNIPERUS CHINENSIS / KALLAYS COMPACT / KALLAY COMPACT PRITCHER JUNIPER
JF2	J	JUNIPERUS COMPLANIS / HORIZONTALIS / HORIZONTAL JUNIPER
TE	TE	PAKUS MUO / PUNK / DUMK / DUMK PINE
TE	TE	TAUSU X MEDIA VEILANTO / EVERLON ANGLO-JAPANESE VEIL
TE	TE	TAUSU X MEDIA / TAUNTON / TAUNTONS ANGLO-JAPANESE VEIL
VERBENA		
DA	DA	DIKAK (VERBENA GRAMINI) BLACKWICK / BLACKWICK SB. BLUESTEM
DA	DA	ANDROPOGON GRAMINI / RED OCTOBER / RED OCTOBER GR. BLUESTEM
DA	DA	CHALMERSGOTT X ACUTIFLORA / NAIL FOEBSTER / NAIL FOEBSTER FEATHER RB
DA	DA	DESCHAMPSIA CERGASTA / TWISTED HANGGRASS
PN	PN	PHANICUM VIRGINIANA / HEAVY METAL / HEAVY METAL SWITCH GRASS
PN	PN	PHANICUM VIRGINIANA / NORTHSTAR / NORTHSTAR SWITCH GRASS
PN	PN	POENICESTAL (ALLEGRO) POCKET / POCKET DUMK / DUMK

	SC	ICHANGZHONG BOORHUA CAROUSEL / CAROUSEL LITTLE BLUESTEM
	SP	SPOROBOLUS HETEROPHYLLUS / PRAIRIE DOGPOD
	4H1	ACHILLEA MILEFOLIUM / STRAWBERRY SEDUCTION / STRAWBERRY SEDUCTION
	4H	ALLIUM X SUMMER BEAUTY / SUMMER BEAUTY ORNAMENTAL ONION
	4H	AMONIA TAYBENKANTONIA BLUE ICE / BLUE ICE EASTERN BLUESTAR
	4H2	ACHILLEA TUBEROSA HELLO YELLOW / HELLO YELLOW BUTTERFLY MILKWEED
	BP	ESCHOLARIA X PICA BELLA / PICA BELLA CONFLUNDER
	BP	ESCHOLARIA X HAPPY RETURN / HAPPY RETURN ONLY
	HC1	NETTIA PASSERIS NEROLARIUS LOOF / WALKERS LOW GARNET
	PD	PENSTEMON DIGITALIS / ICEARDONIA
	RD	RUDECKIA FLUGIA LITTLE GOLDSTAR / LITTLE GOLDSTAR BLACK-EYED SUSAN
	SA	SC. AUTUMN JOY / AUTUMN JOY SEEDUM
		
		
		
		
		
		
		
		
		
		
		
		
		


CONCEPT PLANT SCHEDULE

 EXISTING TREE 9


Kimley»»Horn

KHA PROJECT 149621089	DATE 11/14/2025	SCALE AS SHOWN	DESIGNED BY ###	DRAWN BY ###	CHECKED BY ###	KHA PROJECT 149621089
			DATE: 11/14/2025			
			ILLINOIS LICENSE NUMBER XXXX			
			XXXX			
			LICENSED PROFESSIONAL			

<p>159TH & LAGRANGE RETAIL</p>	<p>ILLINOIS</p>	<p>LANDSCAPE PLAN</p>
<p>SHEET NUMBER L1.5</p>	<p>CITY OF ORLAND PARK</p>	

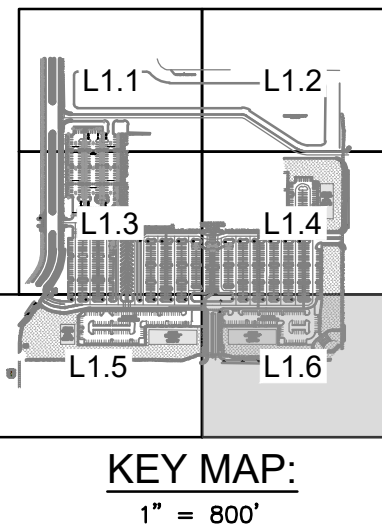

TEARS	CODE	BOTANICAL COMMON NAME
	AC	ACER X FREEMAN VIRESTRIS
	CO	CELTIS OCCIDENTALIS X COMPTON
	OW	OWIKO BILBOA AITUNO GLO
	OL	OLESTRA THACANTON KERN
	DI	DYMOLOLOUS DUCUS VENT
	NY	NYSTA PISCALIA BLACK TOP
	QU	QUERCUS BICOLOR X PRINCEP
	QU	QUERCUS MACROCARPA X BUR
	QU	QUERCUS RUBRA RED OAK
	TA	TAXODIA DISTICHA M
	TL	TLIA AMERICAN MOCCENT
	UL	ULMUS AMERICAN PRINCEPS
SUNSHINE TEARS		
	VI	VIRGATIFUS VIRGINIANA X EAST
	PI	PICEA ABIES NORWAY PRINCE
	PI	PINUS STROBUS WHITE PINE
	PR	PRINCEPSIA MENZIESII X EAST
	TA	TALIGA CANADENSIS X EASTERN
CONCENTRIC TEARS		
	AR	ARILANDER LARLEY X EASTERN
	BE	BETULA NIGRA HONEY BIRCH
	CA	CARPULUS CAROLINENSIS X EAST
	CE	CECIS CAROLINENSIS AMERICAN
	CR	CRINAEUS CRUS-GALLI VARY
	MA	MAIUS X ZHELCOLO X RED JEW
	MA	MAIUS X PRINCEP X PRINCEP
	ST	STYRIA VIRGINICA X EASTERN
	TR	TRINCA RETICULATA VARY
SQUARES		
	AL	ALONIA MELANOCARPA NORTH
	AL	ALONIA MELANOCARPA X CON
	CE	CEANOUS THALASSIA NORTH
	CO	CONUS ABAS BALWAL THIN
	CS	CONUS AMERICAN GLO
	DE	DELTA X NIGRA X VARY
	DE	DELTA X NIGRA X VARY
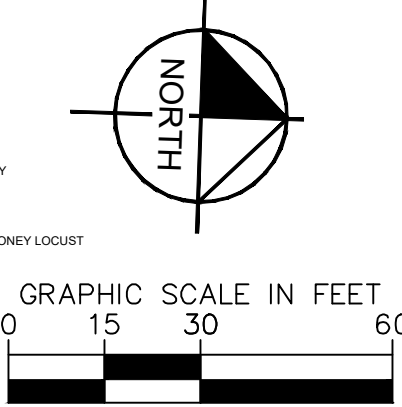

159TH STREET

S. LAGRANGE ROAD

Kimley»»Horn

© 2025 KIMLEY-HORN AND ASSOCIATES, INC.
4201 WINFIELD ROAD, SUITE 600
WARRENVILLE, IL 60555
630-487-5550
WWW.KIMLEY-HORN.COM

LICENSED PROFESSIONAL

XXXX
ILLINOIS LICENSE NUMBER

TE: 11/14/2025

LANDSCAPE PLAN

159TH & LAGRANGE
RETAIL

ILLINOIS


CITY OF ORLAND PARK

SHEET NUMBER
L1.6


This document, together with the concepts and designs presented herein, as an instrument of service, is intended only for the specific purpose and client for which it was prepared. Reuse of and improper reliance on this document, without written authorization and adaptation by Kinley-Horn and Associates, Inc., shall be without liability to Kinley-Horn and Associates, Inc.




MONUMENT SIGN LANDSCAPE ENLARGEMENT "A"

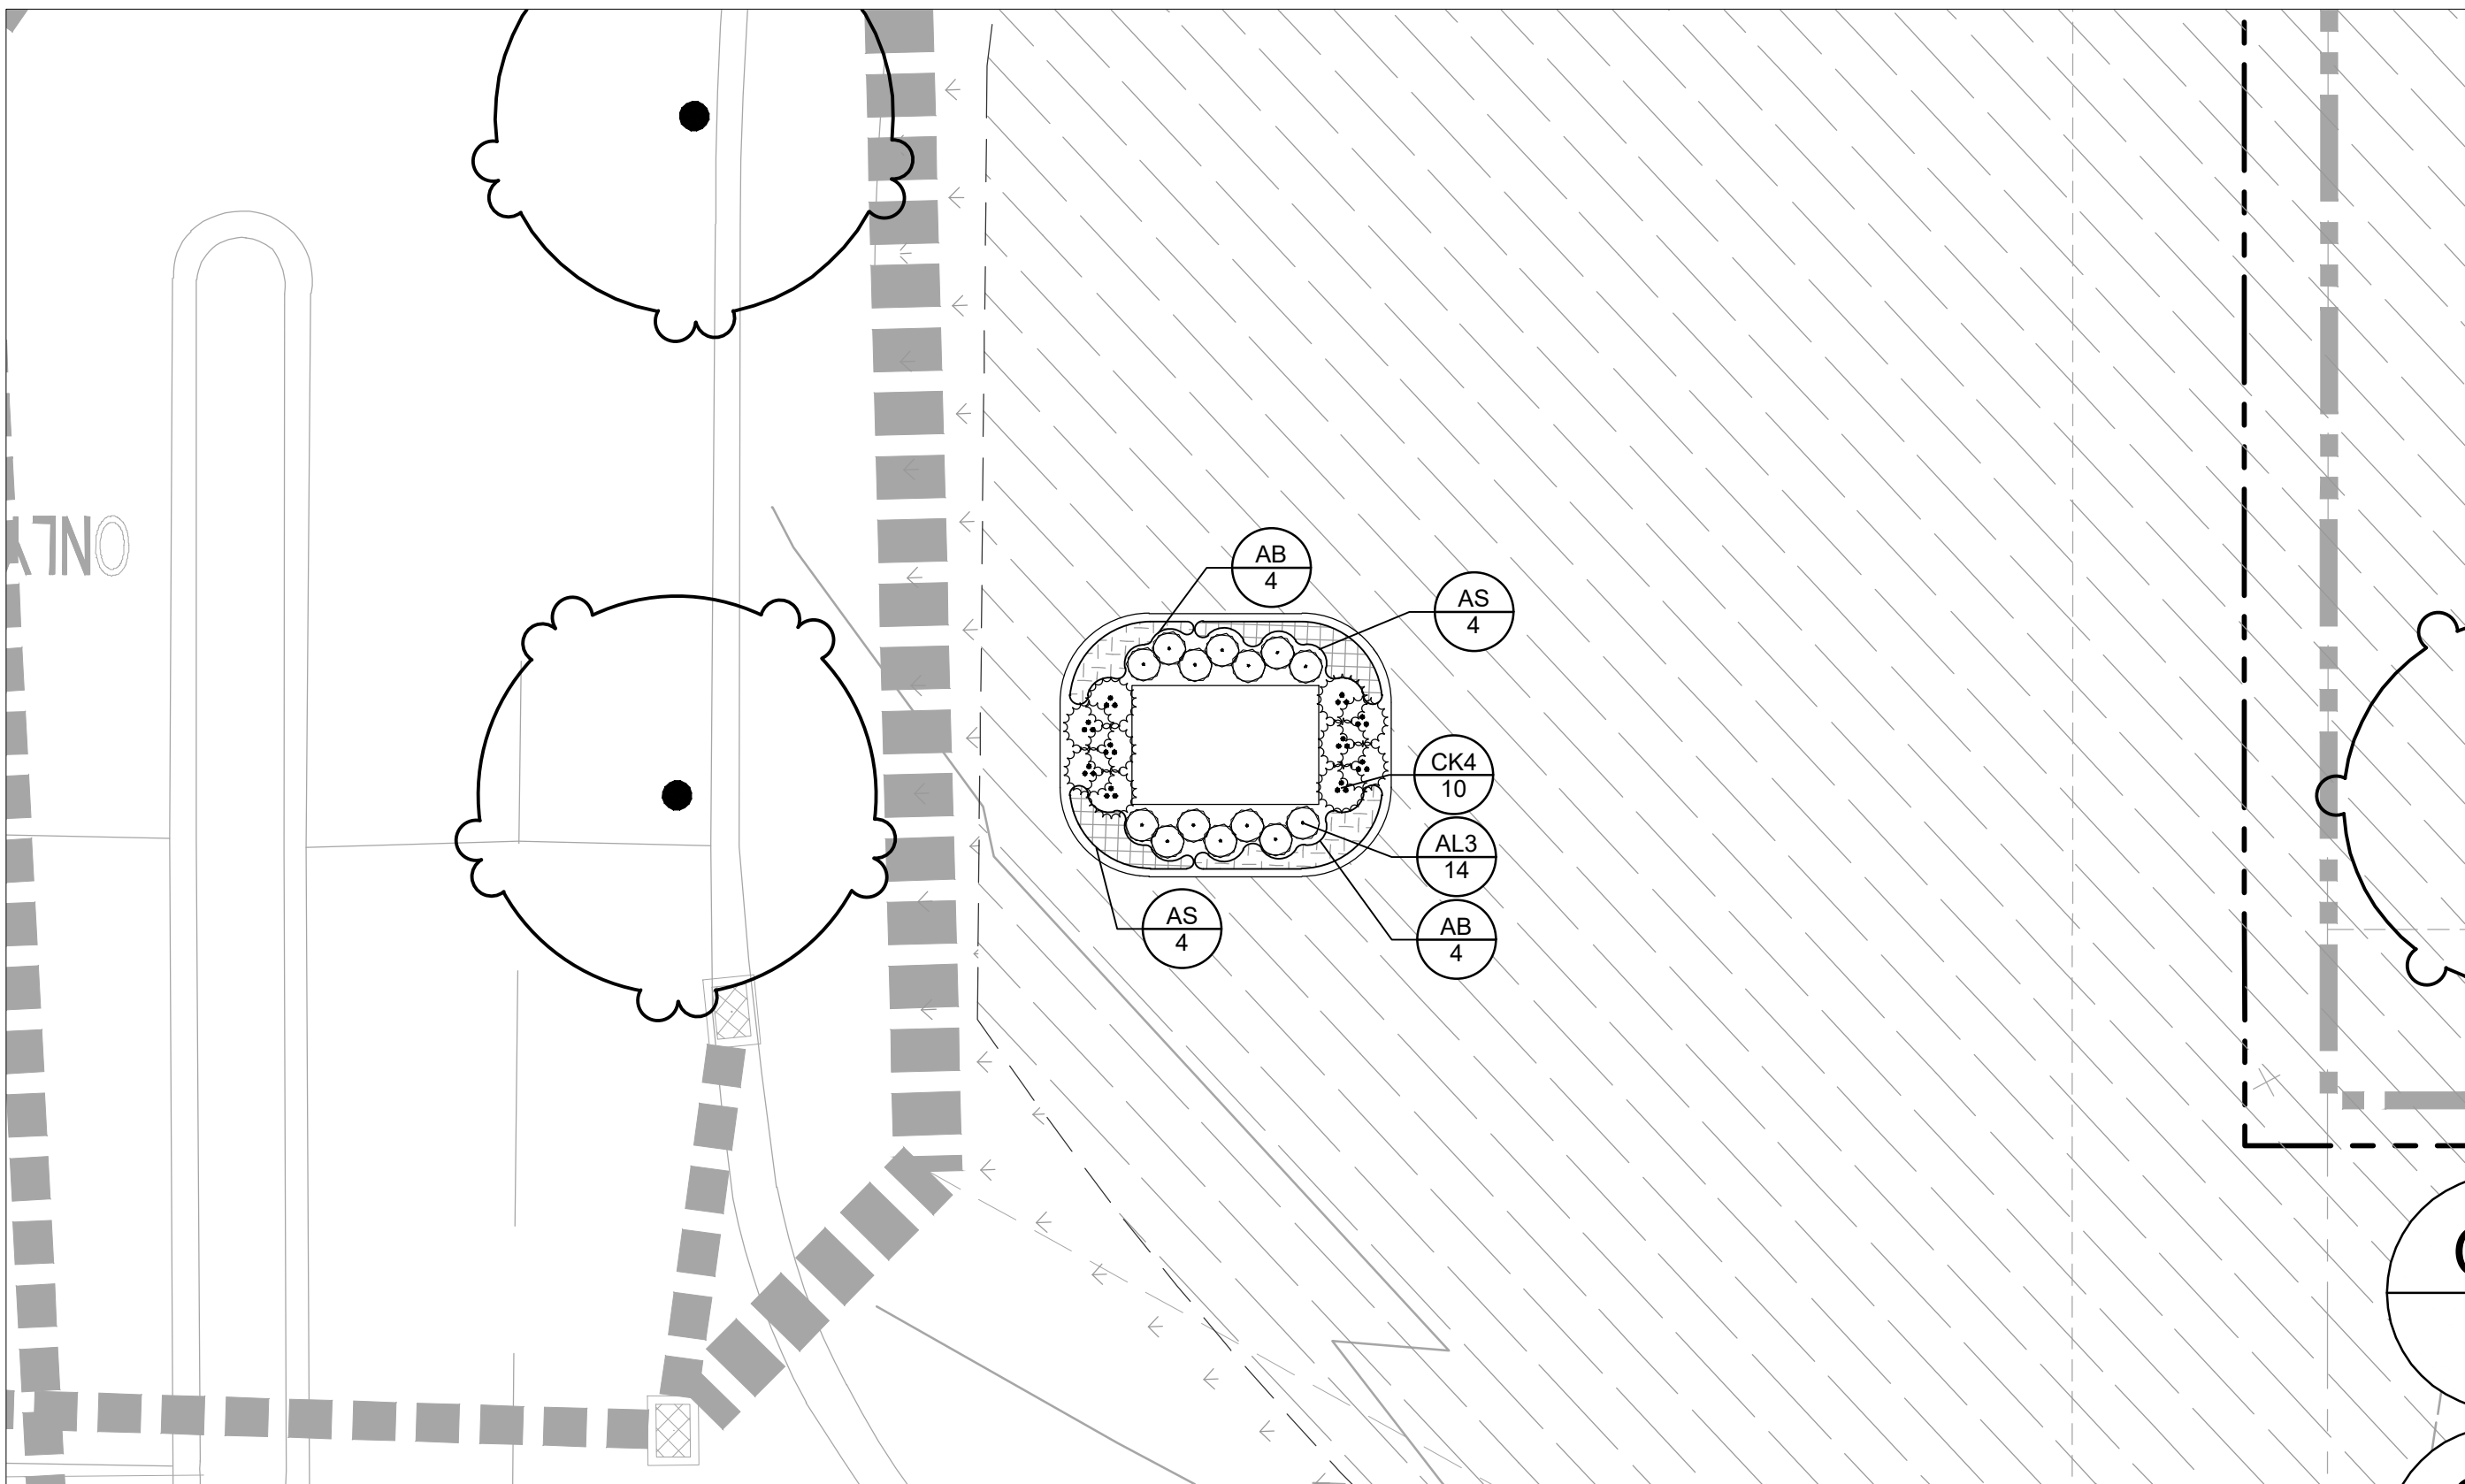 $1'' = 10$ 

MONUMENT SIGN LANDSCAPE ENLARGEMENT "B"

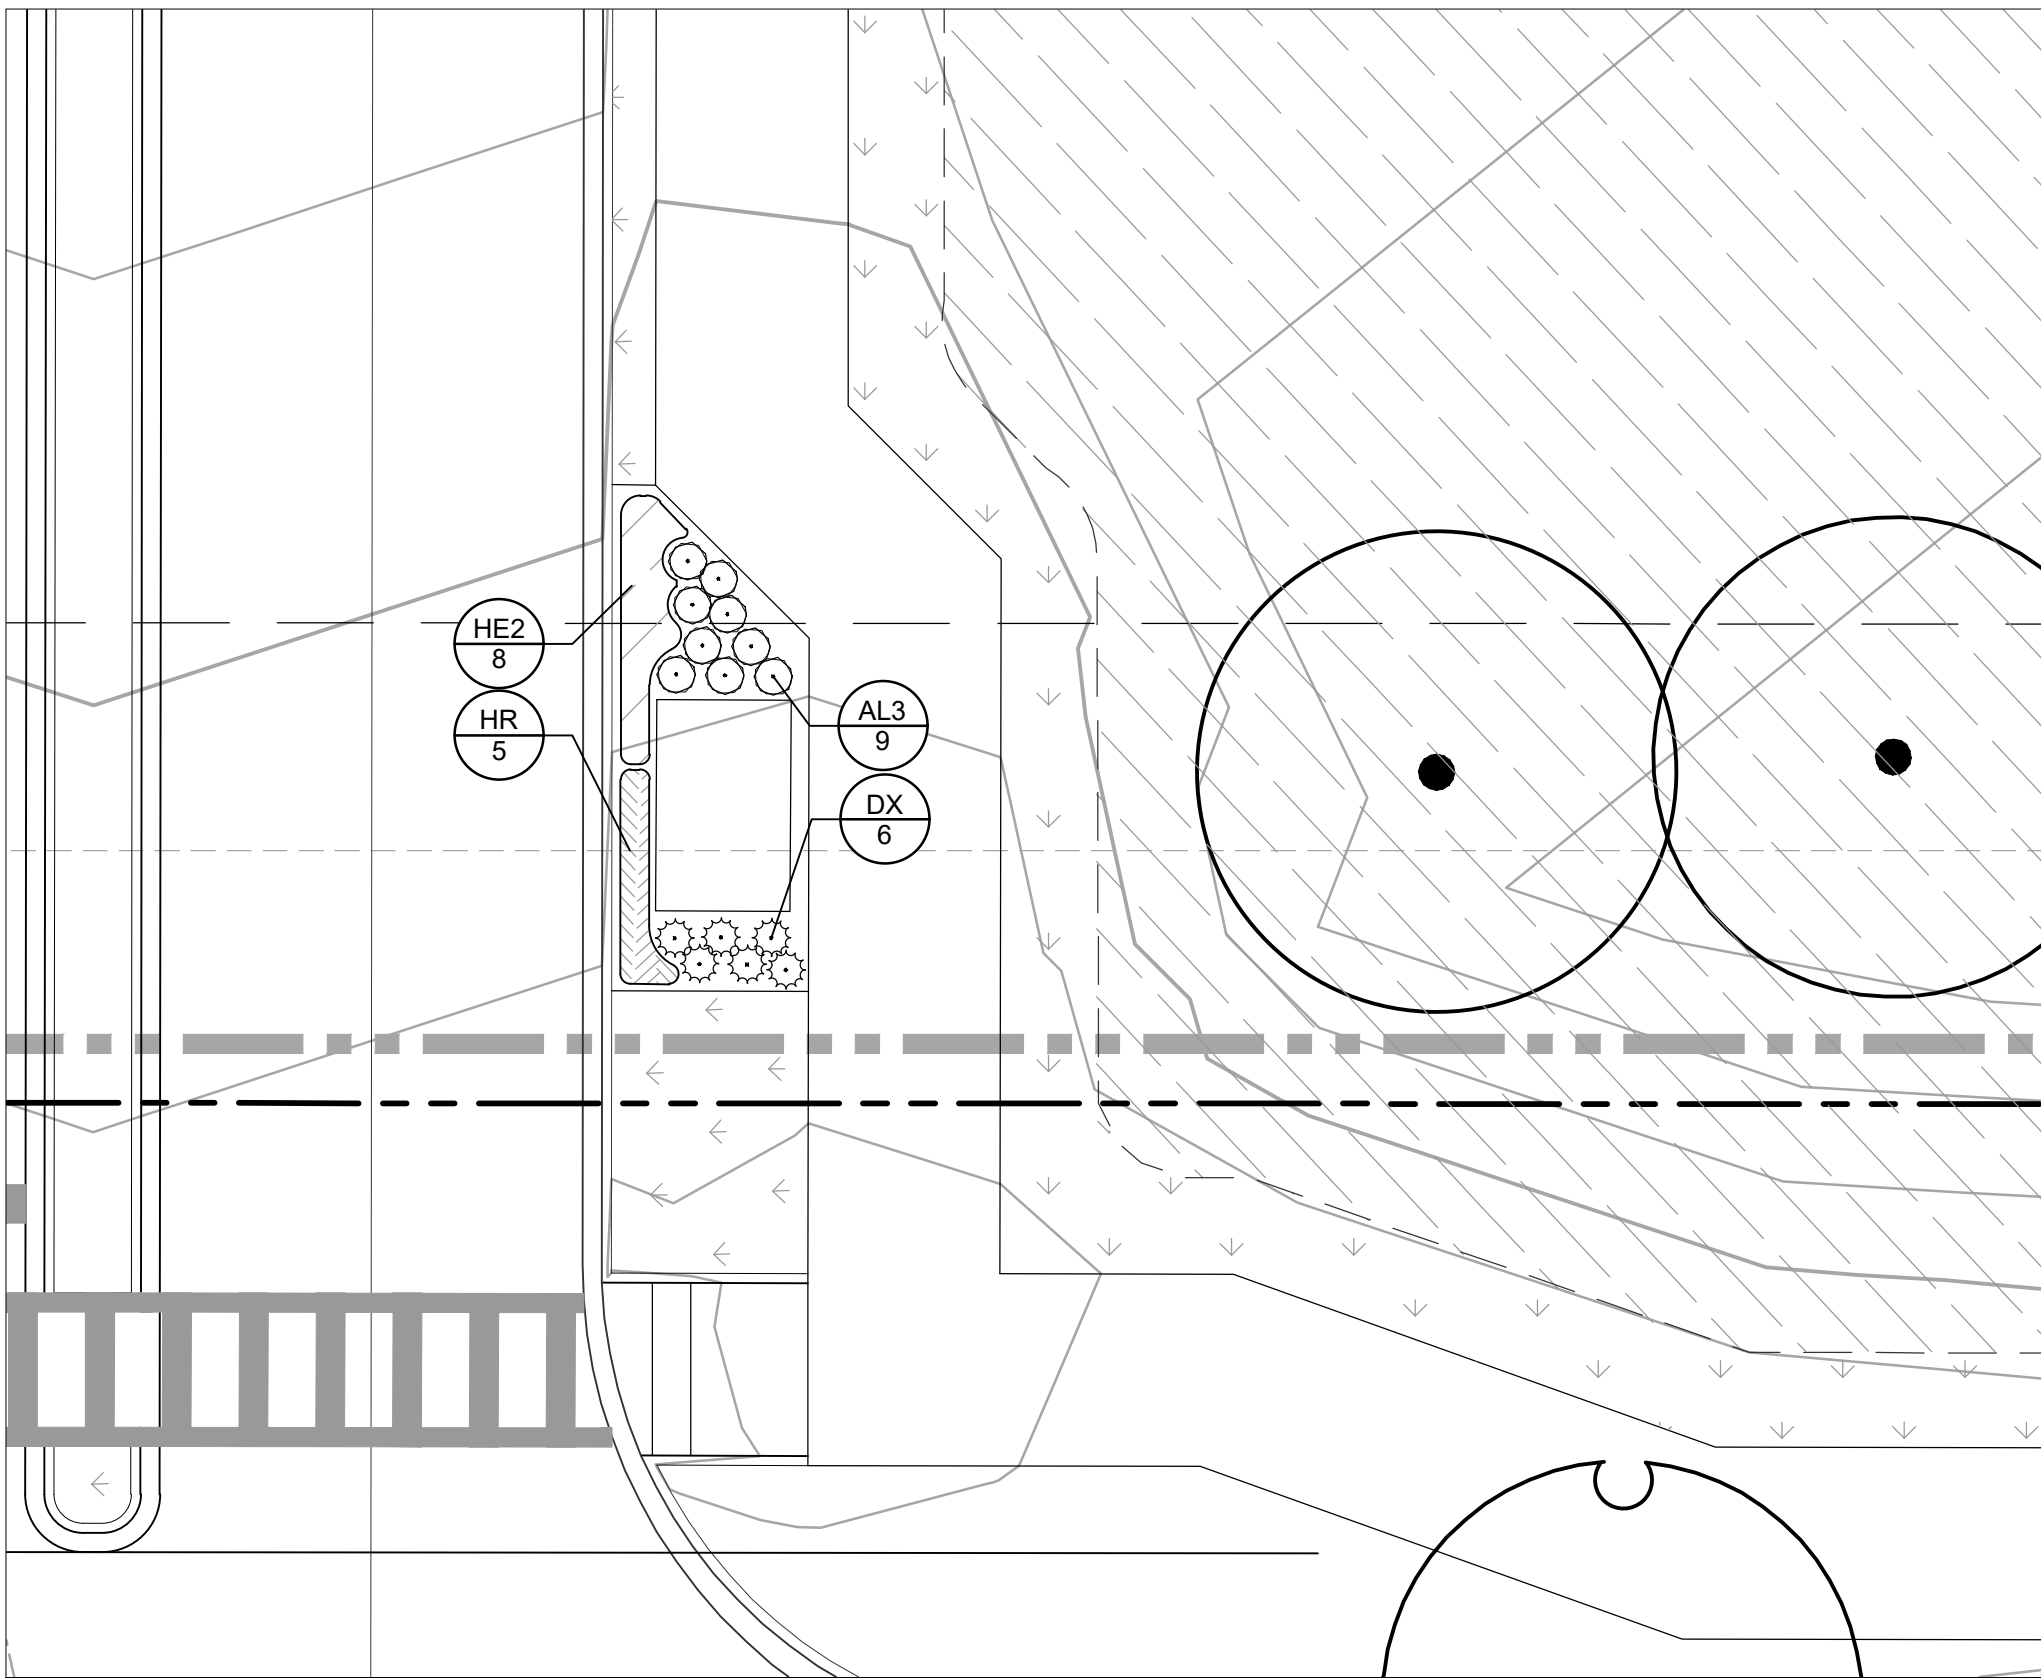
 $1^\circ = 10$ 


MONUMENT SIGN LANDSCAPE ENLARGEMENT "C"

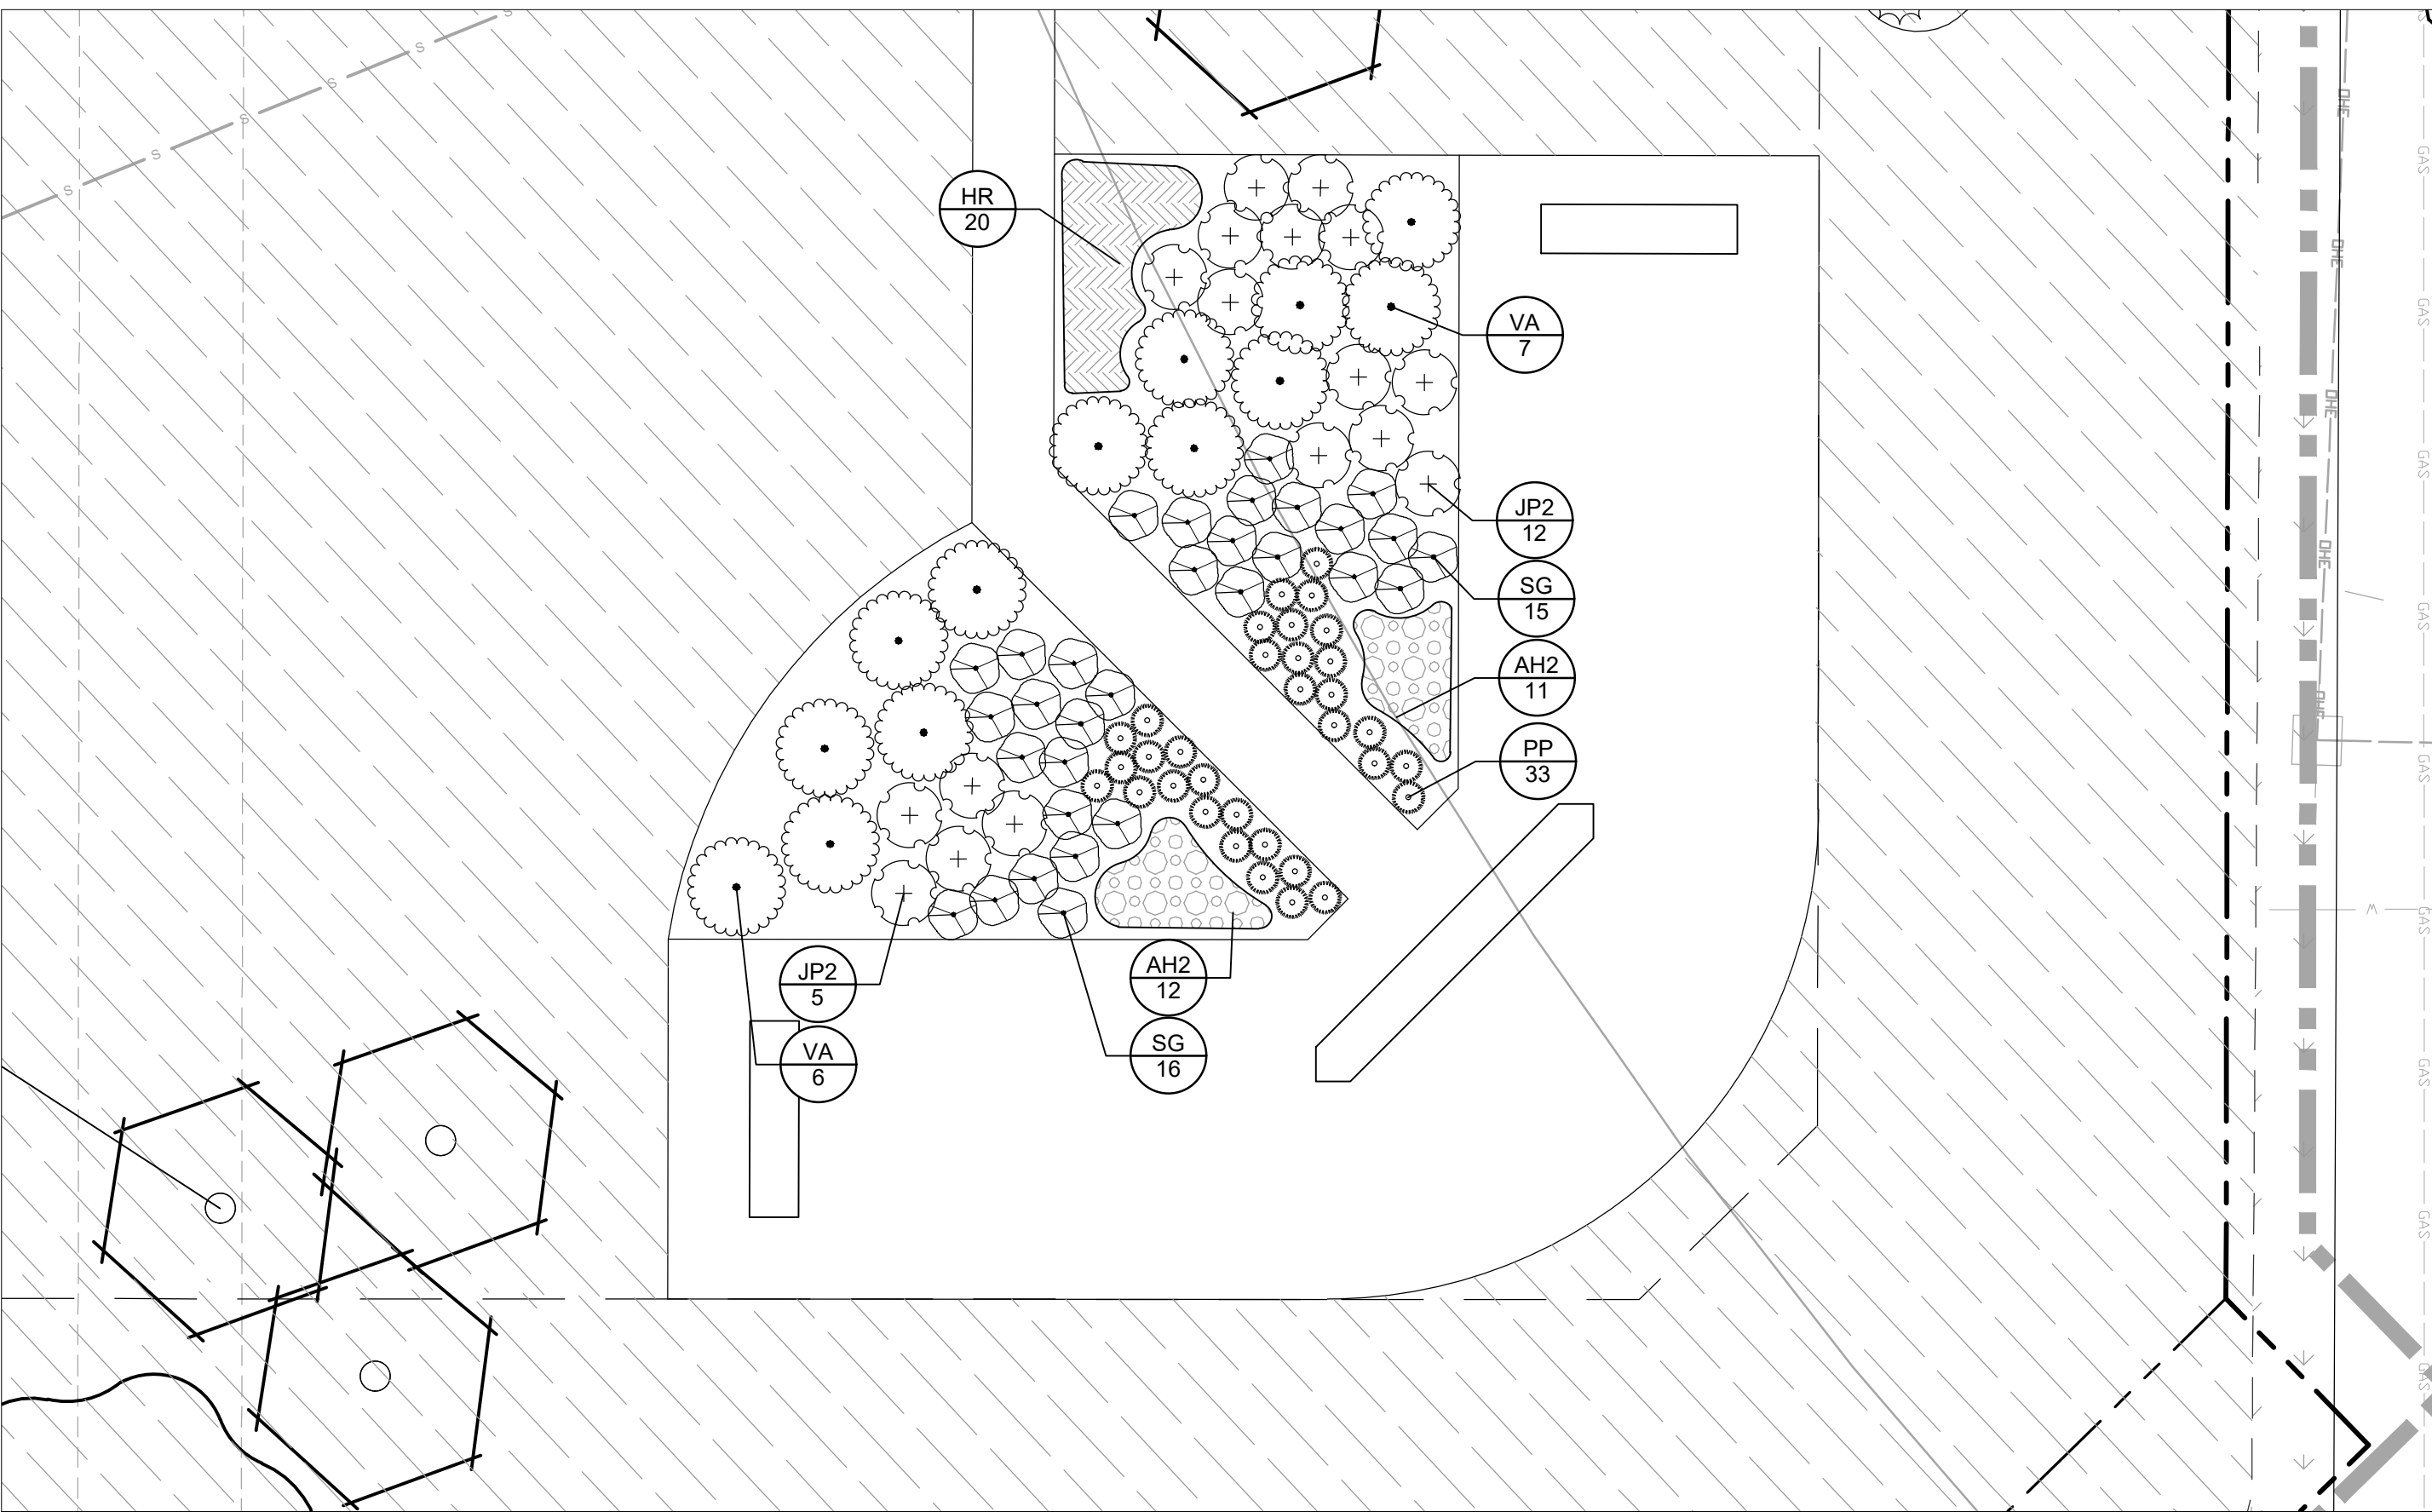 $1^\circ = 10$ 

MONUMENT SIGN LANDSCAPE ENLARGEMENT "D"

1" = 10

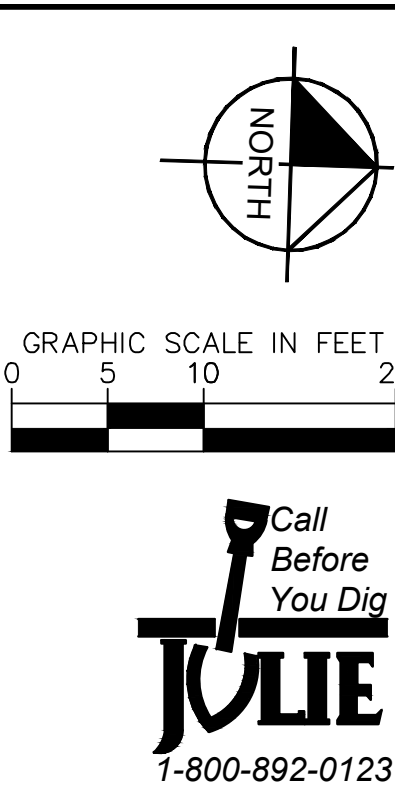
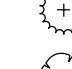















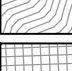
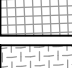
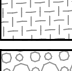
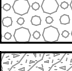





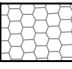








SHEET NUMBER L2.0	159TH & LAGRANGE RETAIL	ILLINOIS CITY OF ORLAND PARK	MONUMENT SIGN ENLARGEMENTS	KHA PROJECT 149621089	LICENSED PROFESSIONAL	 Kimley»»Horn © 2025 KIMLEY-HORN AND ASSOCIATES, INC. 420 WARRENVILLE, IL 60555 630-487-5550 WWW.KIMLEY-HORN.COM						
				DATE 11/14/2025	XXXX							
				SCALE AS SHOWN	ILLINOIS LICENSE NUMBER XXXX							
				DESIGNED BY ##	DATE: 11/14/2025							
				DRAWN BY ##								
				CHECKED BY ##		No.	REVISIONS	DATE	BY			

This document, together with the concepts and designs presented herein, as an instrument of service, is intended only for the specific purpose and client for which it was prepared. Reuse of and improper reliance on this document without written authorization and adaptation by Kimley-Horn and Associates, Inc. shall be without liability to Kimley-Horn and Associates, Inc.

PLANT SCHEDULE

SYMBOL	CODE	QTY	BOTANICAL / COMMON NAME	CONT	CAL	SIZE
TREES						
	AA	21	ACER X FREEMANI 'ARMSTRONG' / ARMSTRONG FREEMAN MAPLE CULTIVAR OF A NATIVE SPECIES ACCORDING TO SWINK AND WILHELM'S PLANTS OF THE CHICAGO REGION.	B & B	2.5" CAL. MIN.	
	OO	40	CELTIS OCCIDENTALIS / COMMON HACKBERRY NATIVE SPECIES ACCORDING TO SWINK AND WILHELM'S PLANTS OF THE CHICAGO REGION.	B & B	2.5" CAL. MIN.	
	GB	36	GINKGO BILOBA 'AUTUMN GOLD' / AUTUMN GOLD GINKGO - MALE ONLY	B & B	2.5" CAL. MIN.	
	GG	35	GLEDITSIA TRIACANTHOS INERMIS 'GREEN GLORY' / GREEN GLORY HONEY LOCUST CULTIVAR OF A NATIVE SPECIES ACCORDING TO SWINK AND WILHELM'S PLANTS OF THE CHICAGO REGION.	B & B	2.5" CAL. MIN.	
	GO	45	GYMNOCLADUS DIOICUS / KENTUCKY COFFEETREE NATIVE SPECIES ACCORDING TO SWINK AND WILHELM'S PLANTS OF THE CHICAGO REGION.	B & B	2.5" CAL. MIN.	
	ZS	59	NYSSA SYLVATICA / BLACK TUPELO NATIVE SPECIES ACCORDING TO SWINK AND WILHELM'S PLANTS OF THE CHICAGO REGION.	B & B	2.5" CAL. MIN.	
	QB	43	QUERCUS BICOLOR / SWAMP WHITE OAK NATIVE SPECIES ACCORDING TO SWINK AND WILHELM'S PLANTS OF THE CHICAGO REGION.	B & B	2.5" CAL. MIN.	
	QM	28	QUERCUS MACROCARPA / BURR OAK NATIVE SPECIES ACCORDING TO SWINK AND WILHELM'S PLANTS OF THE CHICAGO REGION.	B & B	2.5" CAL. MIN.	
	QR	30	QUERCUS RUBRA / RED OAK NATIVE SPECIES ACCORDING TO SWINK AND WILHELM'S PLANTS OF THE CHICAGO REGION.	B & B	2.5" CAL. MIN.	
	TD	29	TAXODIUM DISTICHUM / BALD CYPRESS NATIVE SPECIES ACCORDING TO SWINK AND WILHELM'S PLANTS OF THE CHICAGO REGION.	B & B	2.5" CAL. MIN.	
	TC	36	TILLIA AMERICANA 'MCKSENTRY' / MCKSENTRY LINDEN CULTIVAR OF A NATIVE SPECIES ACCORDING TO SWINK AND WILHELM'S PLANTS OF THE CHICAGO REGION.	B & B	2.5" CAL. MIN.	
	UP	43	ULMUS AMERICANA 'PRINCETON' / PRINCETON AMERICAN ELM CULTIVAR OF A NATIVE SPECIES ACCORDING TO SWINK AND WILHELM'S PLANTS OF THE CHICAGO REGION.	B & B	2.5" CAL. MIN.	
EVERGREEN TREES						
	JE	13	JUNIPERUS VIRGINIANA / EASTERN REDCEDAR NATIVE SPECIES ACCORDING TO SWINK AND WILHELM'S PLANTS OF THE CHICAGO REGION.	B & B	6" HT. MIN.	
	PA	18	PICEA ABIES / NORWAY SPRUCE	B & B	6" HT. MIN.	
	PS	7	PINUS STROBUS / WHITE PINE NATIVE SPECIES ACCORDING TO SWINK AND WILHELM'S PLANTS OF THE CHICAGO REGION.	B & B	6" HT. MIN.	
	PM	15	PSUEDOTSUGA MENZIESII / DOUGLAS FIR	B & B	6" HT. MIN.	
	EH	6	TSUGA CANADENSIS / EASTERN HEMLOCK NATIVE SPECIES ACCORDING TO SWINK AND WILHELM'S PLANTS OF THE CHICAGO REGION.	B & B	6" HT. MIN.	
ORNAMENTAL TREES						
	AL	16	AMELANCHIER LAEVIS / ALLEGHENY SERVICEBERRY - MULTI STEM NATIVE SPECIES ACCORDING TO SWINK AND WILHELM'S PLANTS OF THE CHICAGO REGION.	B & B	6" HT. MIN.	
	BR	28	BETULA NIGRA / RIVER BIRCH - MULTISTEM NATIVE SPECIES ACCORDING TO SWINK AND WILHELM'S PLANTS OF THE CHICAGO REGION.	B & B	6" HT. MIN.	
	CA2	9	CARPINUS CAROLINIANA / AMERICAN HORNBEAM - SINGLE STEM NATIVE SPECIES ACCORDING TO SWINK AND WILHELM'S PLANTS OF THE CHICAGO REGION.	B & B	2" CAL. MIN.	
	CC	16	CERCIS CANADENSIS / EASTERN REDBUD - SINGLE STEM NATIVE SPECIES ACCORDING TO SWINK AND WILHELM'S PLANTS OF THE CHICAGO REGION.	B & B	2" CAL. MIN.	
	CR	17	CRATAEGUS CRUS-GALLI VAR. INERMIS / COCKSPUR HAWTHORN - SINGLE STEM NATIVE SPECIES ACCORDING TO SWINK AND WILHELM'S PLANTS OF THE CHICAGO REGION.	B & B	2" CAL. MIN.	
	MJ	16	MALUS X 'JEWELCOLE' / RED 'JEWEL'™ CRABAPPLE - SINGLE STEM CULTIVAR OF A NATIVE SPECIES ACCORDING TO SWINK AND WILHELM'S PLANTS OF THE CHICAGO REGION.	B & B	2" CAL. MIN.	
	MP	10	MALUS X 'PRAIRIFIRE' / PRAIRIFIRE CRABAPPLE - SINGLE STEM CULTIVAR OF A NATIVE SPECIES ACCORDING TO SWINK AND WILHELM'S PLANTS OF THE CHICAGO REGION.	B & B	2" CAL. MIN.	
	OV	8	OSTRYA VIRGINIANA / AMERICAN HOPHORNBEAM - SINGLE STEM NATIVE SPECIES ACCORDING TO SWINK AND WILHELM'S PLANTS OF THE CHICAGO REGION.	B & B	2" CAL. MIN.	
	SI2	13	SYRINGA RETICULATA 'IVORY SILK' / IVORY SILK JAPANESE LILAC - SINGLE STEM	B & B	2" CAL. MIN.	
SHRUBS						
	AM	120	ARONIA MELANOCARPA 'MORTON' TM / IRROQUOIS BEAUTY BLACK CHOKEBERRY CULTIVAR OF A NATIVE SPECIES ACCORDING TO SWINK AND WILHELM'S PLANTS OF THE CHICAGO REGION.	-	SEE PLAN	18" HT. MIN.
	AL3	60	ARONIA MELANOCARPA 'UCONAM165' TM / LOW SHAPE MOUND BLACK CHOKEBERRY CULTIVAR OF A NATIVE SPECIES ACCORDING TO SWINK AND WILHELM'S PLANTS OF THE CHICAGO REGION.	-	SEE PLAN	6" HT. MIN.
	CA	152	CEANOTHUS AMERICANUS / NEW JERSEY TEA NATIVE SPECIES ACCORDING TO SWINK AND WILHELM'S PLANTS OF THE CHICAGO REGION.	-	SEE PLAN	18" HT. MIN.
	CH	99	CORNUS ALBA 'BAILHALO' TM / IVORY HALO DOGWOOD	-	SEE PLAN	24" HT. MIN.
	CG	128	CORNUS SANGUINEA 'CATO' / ARCTIC SUN BLOODWIT DOGWOOD	-	SEE PLAN	24" HT. MIN.
	DX	100	DEUTZIA X 'NCDX1' / YUKI SNOWFLAKE® DEUTZIA	-	SEE PLAN	6" HT. MIN.
	DL	114	DIERVILLA LONICERA / DWARF BUSH HONEYSUCKLE NATIVE SPECIES ACCORDING TO SWINK AND WILHELM'S PLANTS OF THE CHICAGO REGION.	-	SEE PLAN	18" HT. MIN.
	FM	65	FORSYTHIA X INTERMEDIA 'MINDOR' / SHOW OFF® FORSYTHIA	-	SEE PLAN	18" HT. MIN.
	FN	104	FORSYTHIA X INTERMEDIA 'NIMBUS' / SHOW OFF® SUGAR BABY® DWARF FORSYTHIA	-	SEE PLAN	6" HT. MIN.
	DM	119	PHYSCARPUS OPHIOPOLIS 'DONNA MAY' TM / LITTLE DEVIL DWARF NINEBARK CULTIVAR OF A NATIVE SPECIES ACCORDING TO SWINK AND WILHELM'S PLANTS OF THE CHICAGO REGION.	-	SEE PLAN	18" HT. MIN.
	PW	113	PHYSCARPUS OPHIOPOLIS 'SEWARD' / SUMMER WINE NINEBARK CULTIVAR OF A NATIVE SPECIES ACCORDING TO SWINK AND WILHELM'S PLANTS OF THE CHICAGO REGION.	-	SEE PLAN	24" HT. MIN.
	PN	51	POTENTILLA FRUTICOSA 'GOLD DROP' / GOLD DROP BUSH CINQUEFOIL CULTIVAR OF A NATIVE SPECIES ACCORDING TO SWINK AND WILHELM'S PLANTS OF THE CHICAGO REGION.	-	SEE PLAN	18" HT. MIN.
	RG	85	PHILIS AROMATICA 'GRO-LOW' / GRO-LOW FRAGRANT SUMAC CULTIVAR OF A NATIVE SPECIES ACCORDING TO SWINK AND WILHELM'S PLANTS OF THE CHICAGO REGION.	-	SEE PLAN	18" HT. MIN.
	ST	100	SPIRAEA BETULIFOLIA 'TOR GOLD' TM / GLOW GIRL BIRCHLEAF SPIREA	-	SEE PLAN	18" HT. MIN.
	SG	95	SPIRAEA JAPONICA 'YAN' / DOUBLE PLAY® GOLD SPIREA	-	SEE PLAN	6" HT. MIN.
	SF	150	SPIRAEA JAPONICA 'NEON FLASH' / NEON FLASH JAPANESE SPIREA	-	SEE PLAN	18" HT. MIN.
	SI	54	SYRINGA MEYERI 'PALUBIN' / DWARF KOREAN LILAC	-	SEE PLAN	24" HT. MIN.
	VA	92	VIBURNUM DENTATUM 'CHRISTOM' TM / BLUE MUFFIN ARROWWOOD VIBURNUM CULTIVAR OF A NATIVE SPECIES ACCORDING TO SWINK AND WILHELM'S PLANTS OF THE CHICAGO REGION.	-	SEE PLAN	24" HT. MIN.
EVERGREEN SHRUBS						
	BG	94	BUXUS X 'GREEN VELVET' / GREEN VELVET BOXWOOD	-	SEE PLAN	18" HT. MIN.

	IC	88	ILEX X MESERVEAE 'CHINA BOY' / CHINA BOY® HOLLY	-	SEE PLAN	18" HT. MIN.
	JC	188	JUNIPERUS CHINENSIS 'SEA GREEN' / SEA GREEN JUNIPER	-	SEE PLAN	24" HT. MIN.
	JL	74	JUNIPERUS CHINENSIS 'GOLD LACE' / GOLD LACE JUNIPER	-	SEE PLAN	18" HT. MIN.
	JP	86	JUNIPERUS CHINENSIS 'KALLAYS COMPACT' / KALLAY COMPACT PFITZER JUNIPER	-	SEE PLAN	24" HT. MIN.
	JP2	164	JUNIPERUS COMMUNIS 'HORIZONTALIS' / HORIZONTAL JUNIPER CULTIVAR OF A NATIVE SPECIES ACCORDING TO SWINK AND WILHELM'S PLANTS OF THE CHICAGO REGION.	-	SEE PLAN	10" HT. MIN.
	TTS	77	PINUS MUGO VAR. PUMILO / DWARF MUGO PINE	-	SEE PLAN	18" HT. MIN.
	TE	53	TAXUS X MEDIA 'EVERLOW' / EVERLOW ANGLO-JAPANESE YEW	-	SEE PLAN	18" HT. MIN.
	TT	59	TAXUS X MEDIA 'TAUNTONII' / TAUNTON'S ANGLO-JAPANESE YEW	-	SEE PLAN	18" HT. MIN.
GRASSES						
	CK4	15	ANDROPOGON GERARDII 'BLACKHAWKS' / BLACKHAWK BIG BLUESTEM CULTIVAR OF A NATIVE SPECIES ACCORDING TO SWINK AND WILHELM'S PLANTS OF THE CHICAGO REGION.	2 GAL	SEE PLAN	
	AR	16	ANDROPOGON GERARDII 'RED OCTOBER' / RED OCTOBER BIG BLUESTEM CULTIVAR OF A NATIVE SPECIES ACCORDING TO SWINK AND WILHELM'S PLANTS OF THE CHICAGO REGION.	2 GAL	SEE PLAN	
	CK2	13	CALAMAGROSTIS X ACUTIFLORA 'KARL FOERSTER' / KARL FOERSTER FEATHER REED GRASS	2 GAL	SEE PLAN	
	DC	20	DESCHAMPSIA CESPOSITA / TUFTED HAIRGRASS	2 GAL	SEE PLAN	
	PH	14	PANICUM VIRGATUM 'HEAVY METAL' / HEAVY METAL SWITCH GRASS CULTIVAR OF A NATIVE SPECIES ACCORDING TO SWINK AND WILHELM'S PLANTS OF THE CHICAGO REGION.	2 GAL	SEE PLAN	
	PG2	20	PANICUM VIRGATUM 'NORTHWIND' / NORTHWIND SWITCH GRASS CULTIVAR OF A NATIVE SPECIES ACCORDING TO SWINK AND WILHELM'S PLANTS OF THE CHICAGO REGION.	2 GAL	SEE PLAN	
	PP	33	PENNISETUM ALOPECUROIDES 'PIGLET' / PIGLET DWARF FOUNTAIN GRASS	2 GAL	SEE PLAN	
	SC	47	SCHIZACHYRIUM SCOPARIUM 'CAROUSEL' / CAROUSEL LITTLE BLUESTEM CULTIVAR OF A NATIVE SPECIES ACCORDING TO SWINK AND WILHELM'S PLANTS OF THE CHICAGO REGION.	2 GAL	SEE PLAN	
	SH	32	SPOROBOLUS HETEROLEPIS / PRAIRIE DROPSIED NATIVE SPECIES ACCORDING TO SWINK AND WILHELM'S PLANTS OF THE CHICAGO REGION.	2 GAL	SEE PLAN	
PERENNIALS						
	AH	98	ACHILLEA MILLEFOLIUM 'STRAWBERRY SEDUCTION' / STRAWBERRY SEDUCTION COMMON YARROW	1 GAL	36" O.C.	
	AS	232	ALLIUM X 'SUMMER BEAUTY' / SUMMER BEAUTY ORNAMENTAL ONION CULTIVAR OF A NATIVE SPECIES ACCORDING TO SWINK AND WILHELM'S PLANTS OF THE CHICAGO REGION.	1 GAL	24" O.C.	
	AB	136	AMSONIA TABERNAMONTANA 'BLUE ICE' / BLUE ICE EASTERN BLUESTAR	1 GAL	24" O.C.	
	AH2	71	ASCLEPIAS TUBEROSA 'HELLO YELLOW' / HELLO YELLOW BUTTERFLY MILKWEED	1 GAL	24" O.C.	
	EP	147	ECHINACEA X 'PICA BELLA' / PICA BELLA CONEFLOWER CULTIVAR OF A NATIVE SPECIES ACCORDING TO SWINK AND WILHELM'S PLANTS OF THE CHICAGO REGION.	1 GAL	24" O.C.	
	HR	76	HEMEROCALLIS X 'HAPPY RETURNS' / HAPPY RETURNS DAYLILY	1 GAL	24" O.C.	
	HE2	182	NEPETA FAASSENII 'WALKER'S LOW' / WALKER'S LOW CATMINT	1 GAL	24" O.C.	
	PD	80	PENSTEMON DIGITALIS / BEARDTONGUE NATIVE SPECIES ACCORDING TO SWINK AND WILHELM'S PLANTS OF THE CHICAGO REGION.	1 GAL	24" O.C.	
	RS	114	RUDEBECKIA FULGIDA 'LITTLE GOLDSTAR' / LITTLE GOLDSTAR BLACK-EYED SUSAN CULTIVAR OF A NATIVE SPECIES ACCORDING TO SWINK AND WILHELM'S PLANTS OF THE CHICAGO REGION.	1 GAL	24" O.C.	
	SA	92	SEDUM X 'AUTUMN JOY' / AUTUMN JOY SEDUM	1 GAL	24" O.C.	
SYMBOL						
			BOTANICAL / COMMON NAME	CONT	SIZE	SPACING
			EMERGENT WETLAND PLUG MIX	PLUGS		
			NO-MOW TURF SEED MIX	SEED		
			PIZZO NATIVE PLANT NURSERY / WET-MESIC PRAIRIE SEED MIX	SEED		
			TURF SEED	-		
			WET-MESIC PLUG MIX	PLUGS		

EMERGENT WETLAND PLUG MIX

BOTANICAL NAME	COMMON NAME	QTY / ACRE	% OF TOTAL
Acorus calamus	Sweet Flag	300	5%
Asclepias incarnata	Swamp Milkweed	300	5%
Iris virginica	Iris	300	5%
Lobelia siphilitica	Great Blue Lobelia	300	5%
Lythrum alatum	Winged Loosestrife	200	3%
Polygonum amphibium	Knottweed	500	8%
Pontederia cordata	Pickeral Plant	500	8%
Rudbeckia laciniata	Cut Leaf Coneflower	300	5%
Sagittaria latifolia	Arrowhead	300	5%
Scirpus acutus	Hard Stemmed Bulrush	500	8%
Scirpus atrovirens	Dark Green Bulrush	500	8%
Scirpus fluviatilis	River Bulrush	500	8%
Solidago riddellii	Riddell's Goldenrod	200	3%
Sparganium americanum	Bur Reed	500	8%
Spartina pectinata	Prairiecord Grass	500	8%
Symphytotrichum puniceum	Stemmed Aster	300	5%
TOTAL PLUGS PER ACRE:		6,000	

CONTRACTOR TO INSTALL PLUGS 2 FEET ON CENTER IN A TRIANGLE PATTERN (NOT GRID PATTERN).
FINAL PLUG MIX TO BE DETERMINED BASED ON PLANT AVAILABILITY.

WET-MESIC PRAIRIE PLUG MIX


BOTANICAL NAME	COMMON NAME	QTY / ACRE	% OF TOTAL
Bouteloua curtipendula	Side Oats Grama	600	10%
Carex vulpinoidea	Fox Sedge	600	10%
Echinacea purpurea	Purple Coneflower	1,000	17%
Elymus canadensis	Canada Wild Rye	600	10%
Juncus effusus	Common Rush	700	12%
Monarda fistulosa	Wild Bergamot	1,500	25%
Panicum virgatum	Switch Grass	600	10%
Rudbeckia hirta	Black-Eyed Susan	400	7%
Verbena hastata	Blue Vervain	1,500	25%
TOTAL PLUGS PER ACRE:		6,000	

CONTRACTOR TO INSTALL PLUGS 2-3 FEET ON CENTER IN A TRIANGLE PATTERN (NOT GRID PATTERN).
FINAL PLUG MIX TO BE DETERMINED BASED ON PLANT AVAILABILITY.

	TOTAL NUMBER OF PLANTS PER TYPE	MAXIMUM % OF ANY SPECIES	MINIMUM % OF ANY SPECIES	% OF NATIVE SPECIES PER PLANT TYPE	MINIMUM NUMBER OF SPECIES
SHADE TREES					
REQUIRED	N/A	30% = 133.8 TREES	5% = 22.3 TREES	30% = 133.8 TREES	8 SPECIES
PROPOSED	446 TREES TOTAL	COMPLIES *	COMPLIES *	409 NATIVE TREES	12 SPECIES
EVERGREEN TREES					
REQUIRED	N/A	40% = 23.6 TREES	10% = 5.9 TREES	30% = 17.7 TREES	5 SPECIES
PROPOSED	59 TREES TOTAL	COMPLIES *	COMPLIES *	26 NATIVE TREES	5 SPECIES
ORNAMENTAL TREES					
REQUIRED	N/A	30% = 38.4 TREES	5% = 6.4 TREES	30% = 38.4 TREES	8 SPECIES
PROPOSED	128 TREES TOTAL	COMPLIES *	COMPLIES *	97 NATIVE TREES	9 SPECIES
DECIDUOUS SHRUBS					
REQUIRED	N/A	15% = 224.9 SHRUBS	5% = 77.5 SHRUBS	30% = 449.7 SHRUBS	15 SPECIES
PROPOSED	1,499 SHRUBS TOTAL	COMPLIES *	COMPLIES *	142 NATIVE SHRUBS	15 SPECIES
ORNAMENTAL GRASSES					
REQUIRED	N/A	30% = 64.2 GRASSES	5% = 10.7 GRASSES	30% = 64.2 GRASSES	8 SPECIES
PROPOSED	214 GRASSES TOTAL	COMPLIES *	COMPLIES *	14 NATIVE GRASSES	9 SPECIES
PERENNIALS					
REQUIRED	N/A	25% = 238.8 PERENNIALS	5% = 47.7 PERENNIALS	30% = 286.5 PERENNIALS	10 SPECIES
PROPOSED	955 PERENNIALS TOTAL	COMPLIES *	COMPLIES *	488 NATIVE PERENNIALS	10 SPECIES


NO-MOW TURF SEED MIX

BOTANICAL NAME	COMMON NAME	LBS / ACRE	% OF TOTAL
GRASSES, SEDGES, & RUSHES			
Lolium perenne	Perennial Rye	25.0	13%
Agrostis gigantea	Red Top	15.0	8%
Festuca rubra	Creeping Red Fescue	80.0	40%
Festuca arundinacea	Tall Fescue	20.0	10%
Festuca ovina	Sheep's Fescue	20.0	1

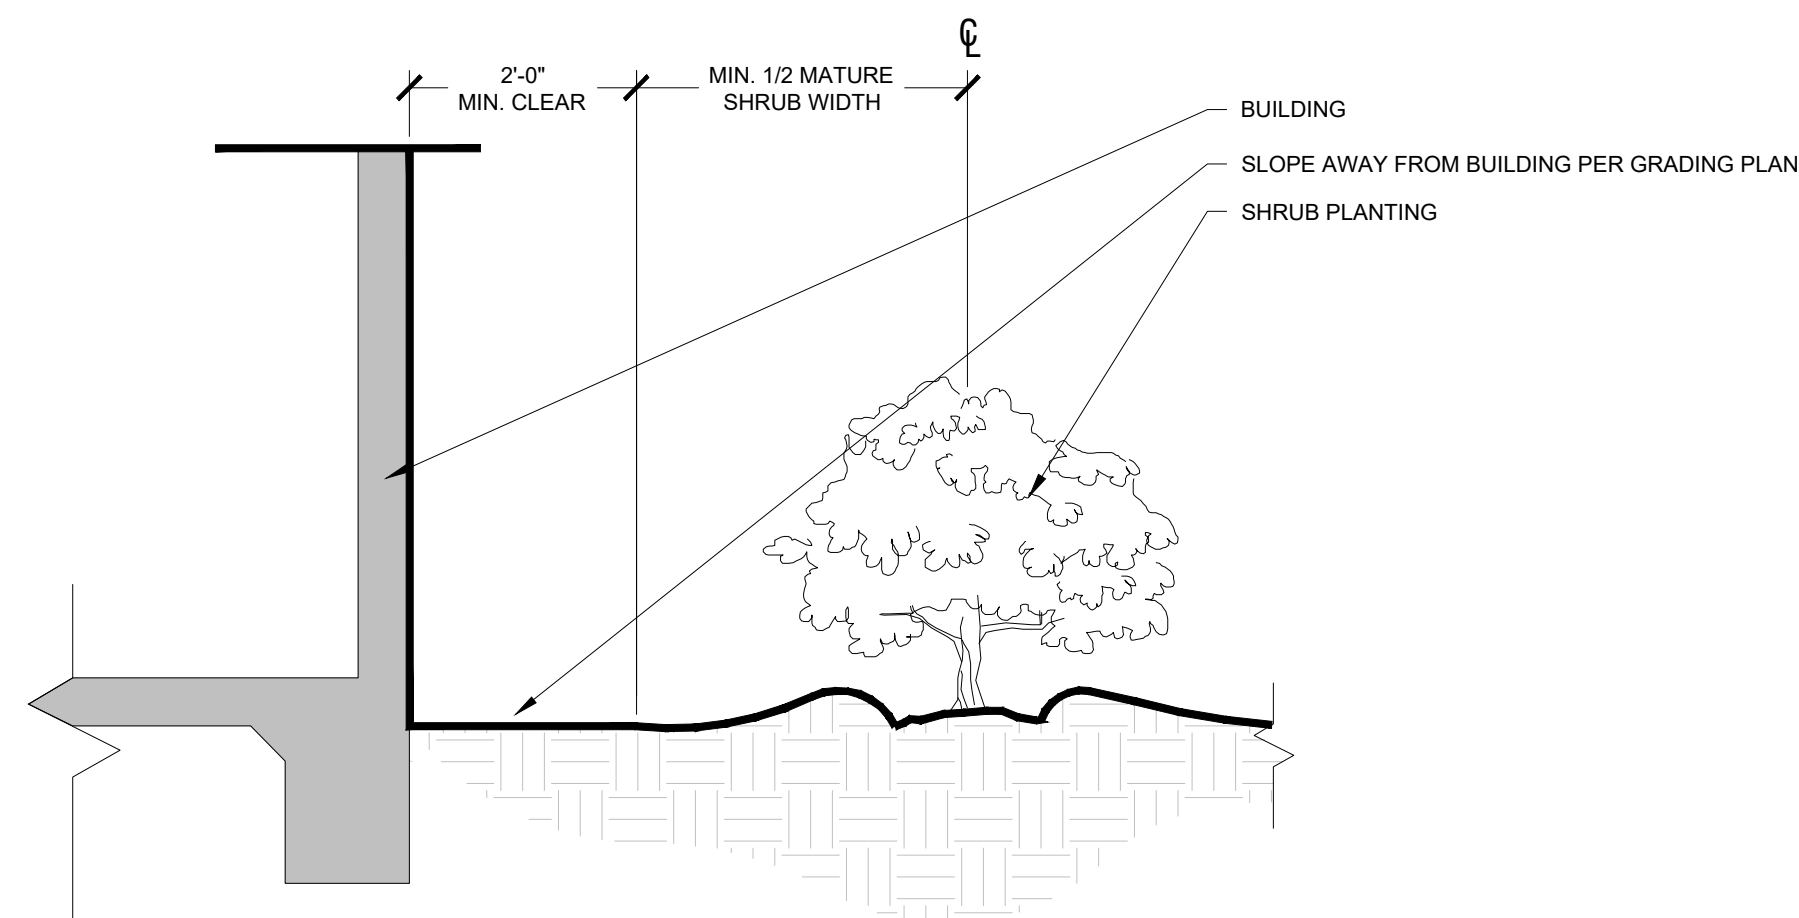


1 SHRUB PLANTING AT BUILDING FACE

N.T.S.

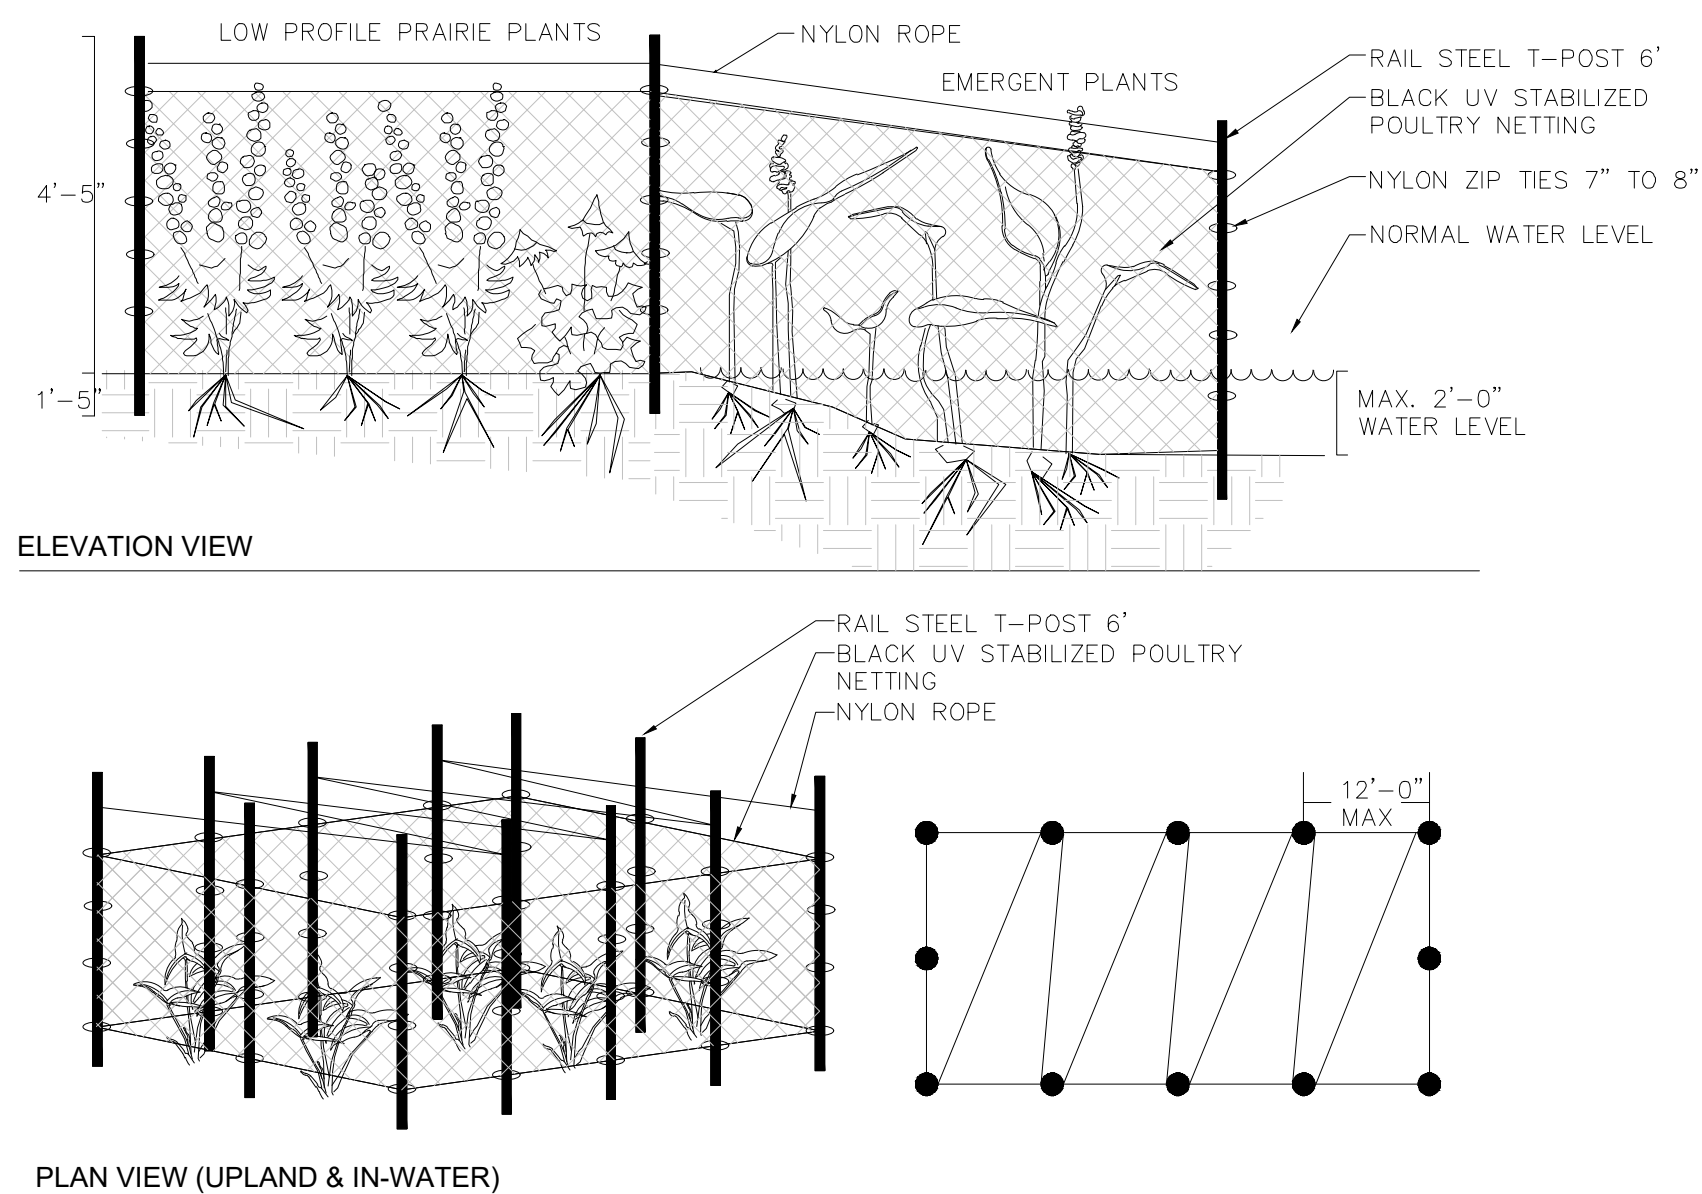

NOTE: GOOSE EXCLOSURE TO SURROUND THE ENTIRE PERIMETER OF EACH PLUGGED AREA WITH POSTS AND NYLON ROPE PROTECTING ALL PLUGS. NOT PROVIDING GOOSE EXCLOSURE WILL RESULT IN LOSS OF PLUGS BY WATER FOWL AND MUSKRAT WILDLIFE.

4 GOOSE EXCLOSURE FENCING

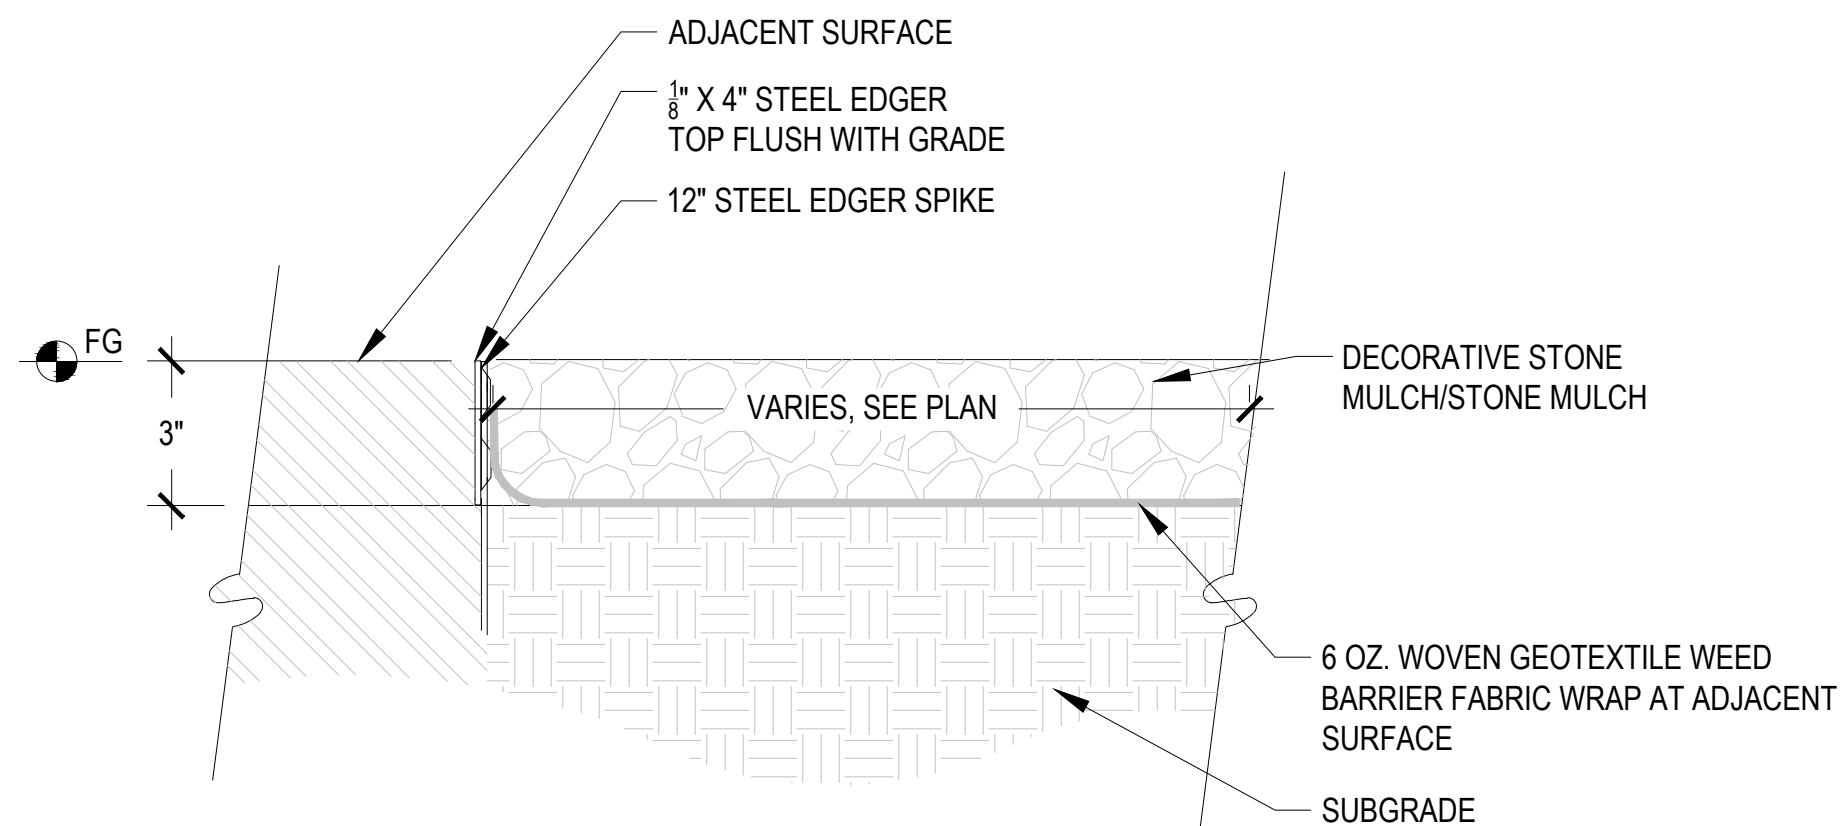
$$1'' = 1'-0''$$


2 STONE MULCH

3" = 1'-0"

- NOTES:

1. INSPECT TREE FOR DAMAGED BRANCHES, APPLY CORRECTIVE PRUNING.
2. SET ROOT BALL ON UNEXCAVATED OR TAMPED SOIL. TOP OF ROOTBALL SHALL BE TWO INCHES ABOVE SURROUNDING GRADE WITH BURLAP AND TWINE BASKET INTACT.
3. REMOVE WIRE BASKET AND BURLAP DUND 1/2 OF ROOT BALL. REMOVE ANY TWINE, SYNTHETIC MATERIAL, WIRES, STRAPS, BURLAP, ETC. THAT COULD GIRDLE OR DAMAGE THE TREE. RESTRICT TREE GROWTH. REMOVE OR CORRECT GIRDLING ROOTS.
4. TAMP EXCAVATED SOIL AROUND BASE OF ROOTBALL.
5. BACKFILL REMAINDER EXCAVATED SOIL. TAMPED LIGHTLY.
6. WATER THOROUGHLY WITHIN TWO HOURS USING 10 TO 15 GALLONS OF WATER.
7. APPLY MULCH IN EVEN LAYER, KEEPING 6" AWAY FROM ROOT BALL. PLANT TAG SHALL BE VISIBLE.
8. FINAL LOCATION OF TREE TO BE APPROVED BY OWNER.
9. PERFORM PERCOLATION TEST AND PLANTING SPECIFICATIONS: IF SUBSURFACE DRAINAGE INFORMATION IS REQUIRED, NOTIFY PROJECT LANDSCAPE ARCHITECT.

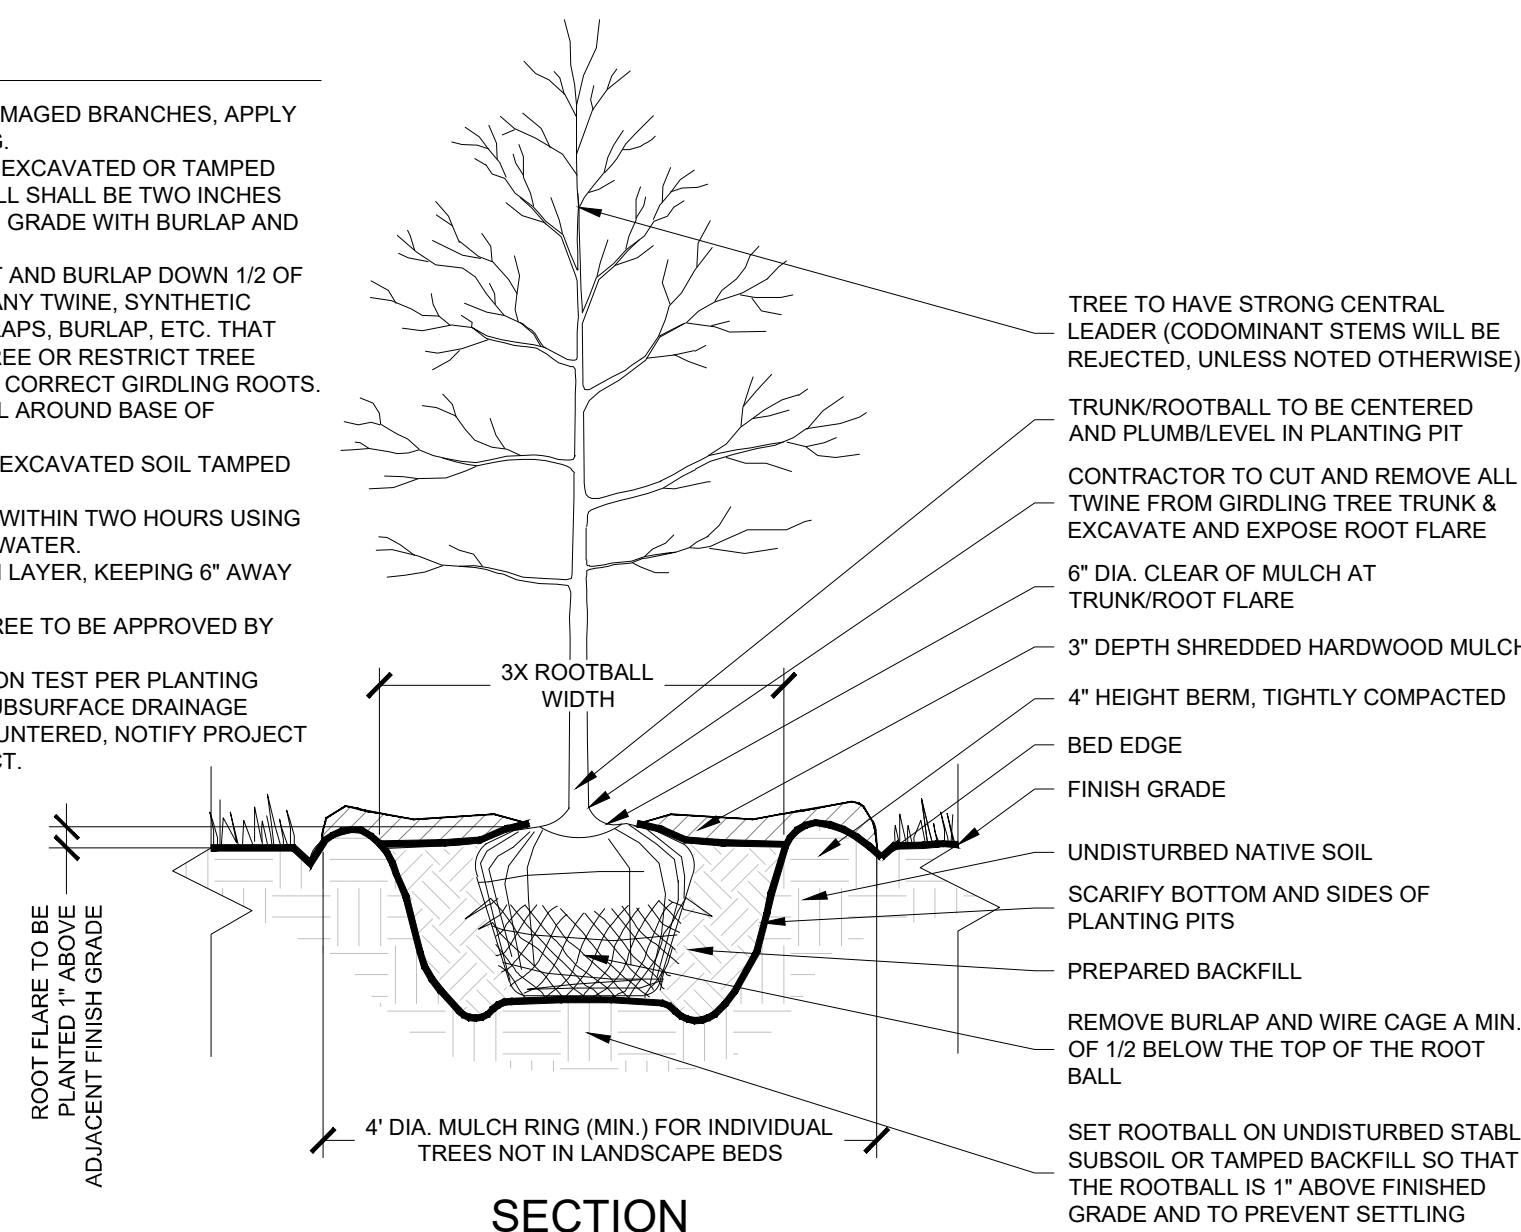


5 TYPICAL TREE PLANTING

N.T.S.


- NOTES:

1. REF. PLANTING SOIL SPECIFICATIONS FOR ADDITIONAL INFORMATION.
2. SEE TREE PRUNING DETAILS FOR ADDITIONAL INFORMATION.
3. COMPLETELY REMOVE THE TOP 1/2 OF ALL B&B WIRE BASKETS.
4. REF. TREE STAKING DETAIL THIS SHEET, IF REQUIRED.
5. PERFORM PERCOLATION TEST PER PLANTING SPECIFICATIONS. IF SUBSURFACE DRAINAGE PROBLEMS ARE ENCOUNTERED, NOTIFY PROJECT LANDSCAPE ARCHITECT.

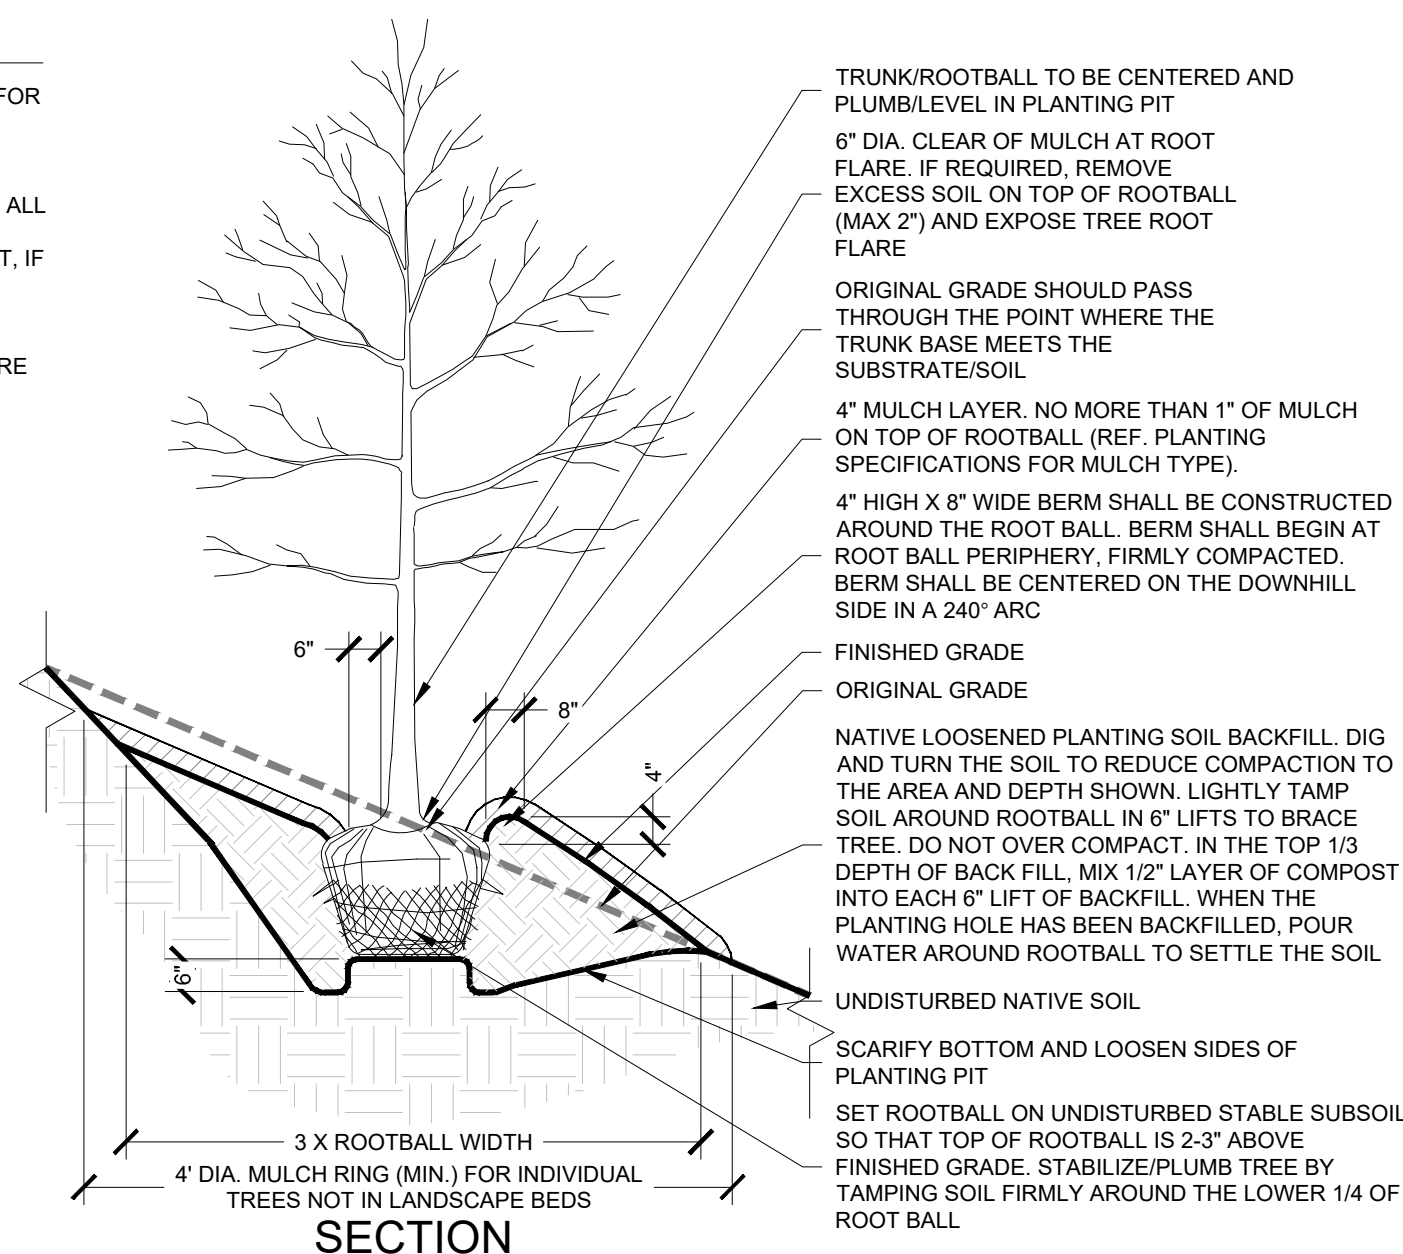

7 TREE PLANTING ON SLOPE

N.T.S.

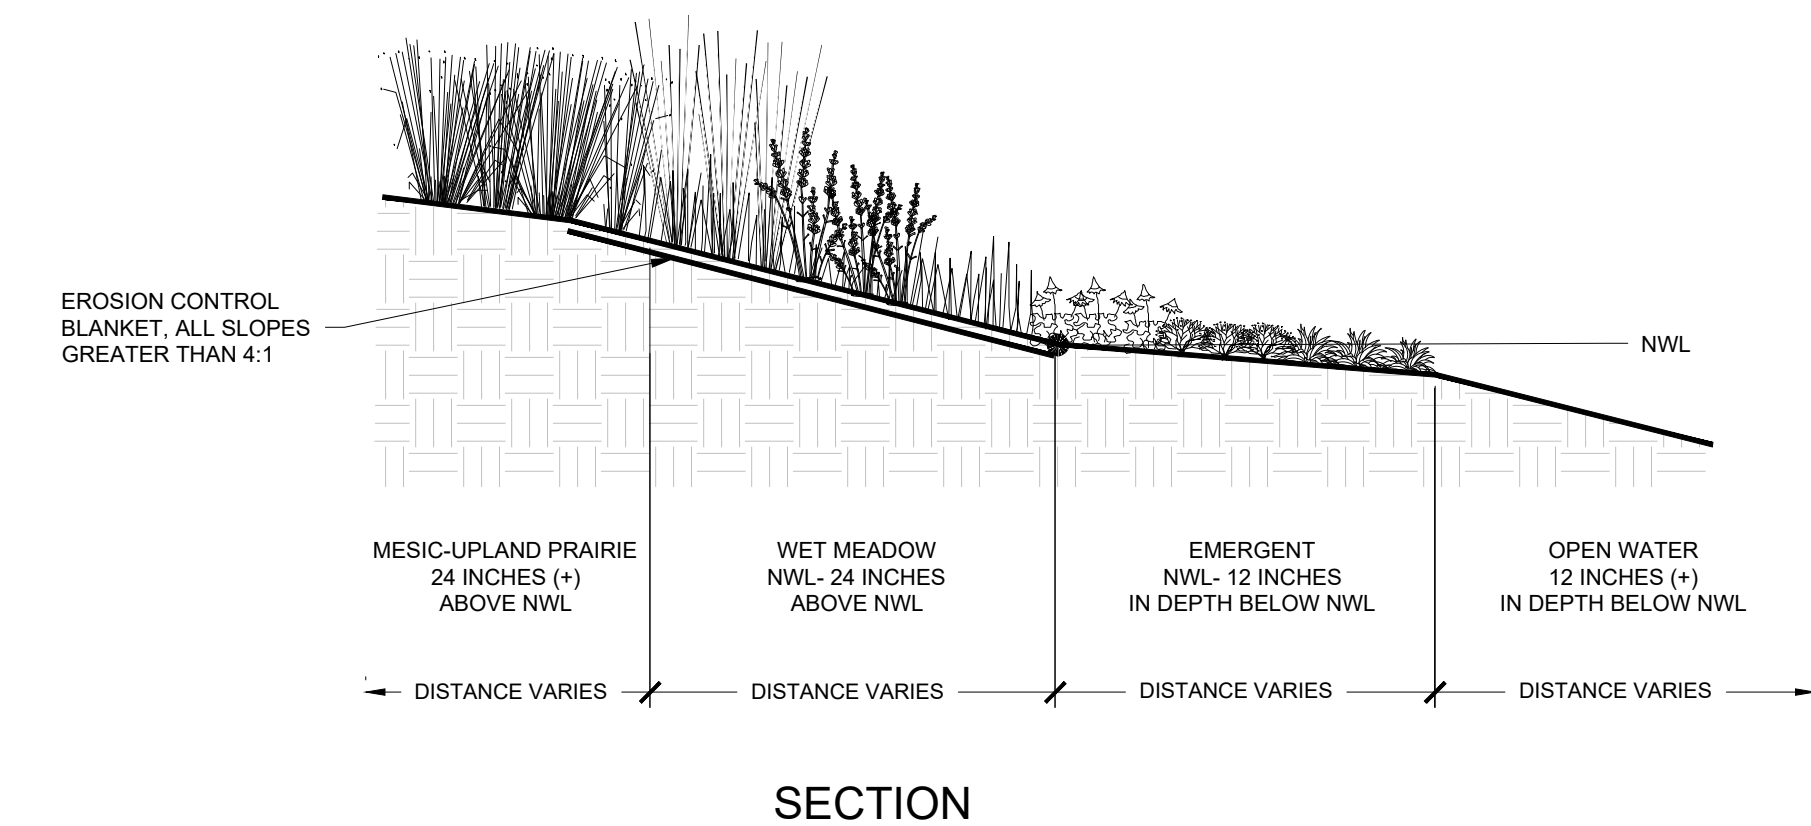


3 DETENTION BASIN PLANTING

N.T.S.

- NOTES:

1. INSPECT TREE FOR DAMAGED BRANCHES, APPLY CORRECTIVE PRUNING.
2. SET ROOT BALL ON UNEXCAVATED OR TAMPED SOIL. TOP OF ROOTBALL SHALL BE TWO INCHES ABOVE SURROUNDING GRADE WITH BURLAP AND WIRE BASKET INTACT.
3. REMOVE WIRE BASKET AND BURLAP DRAIN 1/2 OF ROOTBALL. REMOVE ALL TWINE AND (IF USED), EXCESSIVE MULCH MATERIAL. REMOVE OR CORRECT GIRDLING ROOTS.
4. TAMP EXCAVATED SOIL AROUND BASE OF ROOTBALL.
5. DISCHARGE REMAINDER EXCAVATED SOIL TAMPED LIGHTLY. HIGH CLAY OR POOR SOIL SHALL RECEIVE SOIL AMENDMENT PER LANDSCAPE NOTES.
6. WATER THOROUGHLY WITHIN TWO HOURS USING 10 TO 15 GALLONS OF WATER.
7. APPLY MULCH IN EVEN LAYER. KEEPING AWAY FROM ROOT FLARE.
8. FINAL LOCATION OF TREE TO BE APPROVED BY OWNER.
9. PERFORM POCALATION TEST PER PLANTING SPECIFICATIONS. IF SUBSURFACE DRAINAGE PROBLEMS ARE ENCOUNTERED, NOTIFY PROJECT LANDSCAPE ARCHITECT

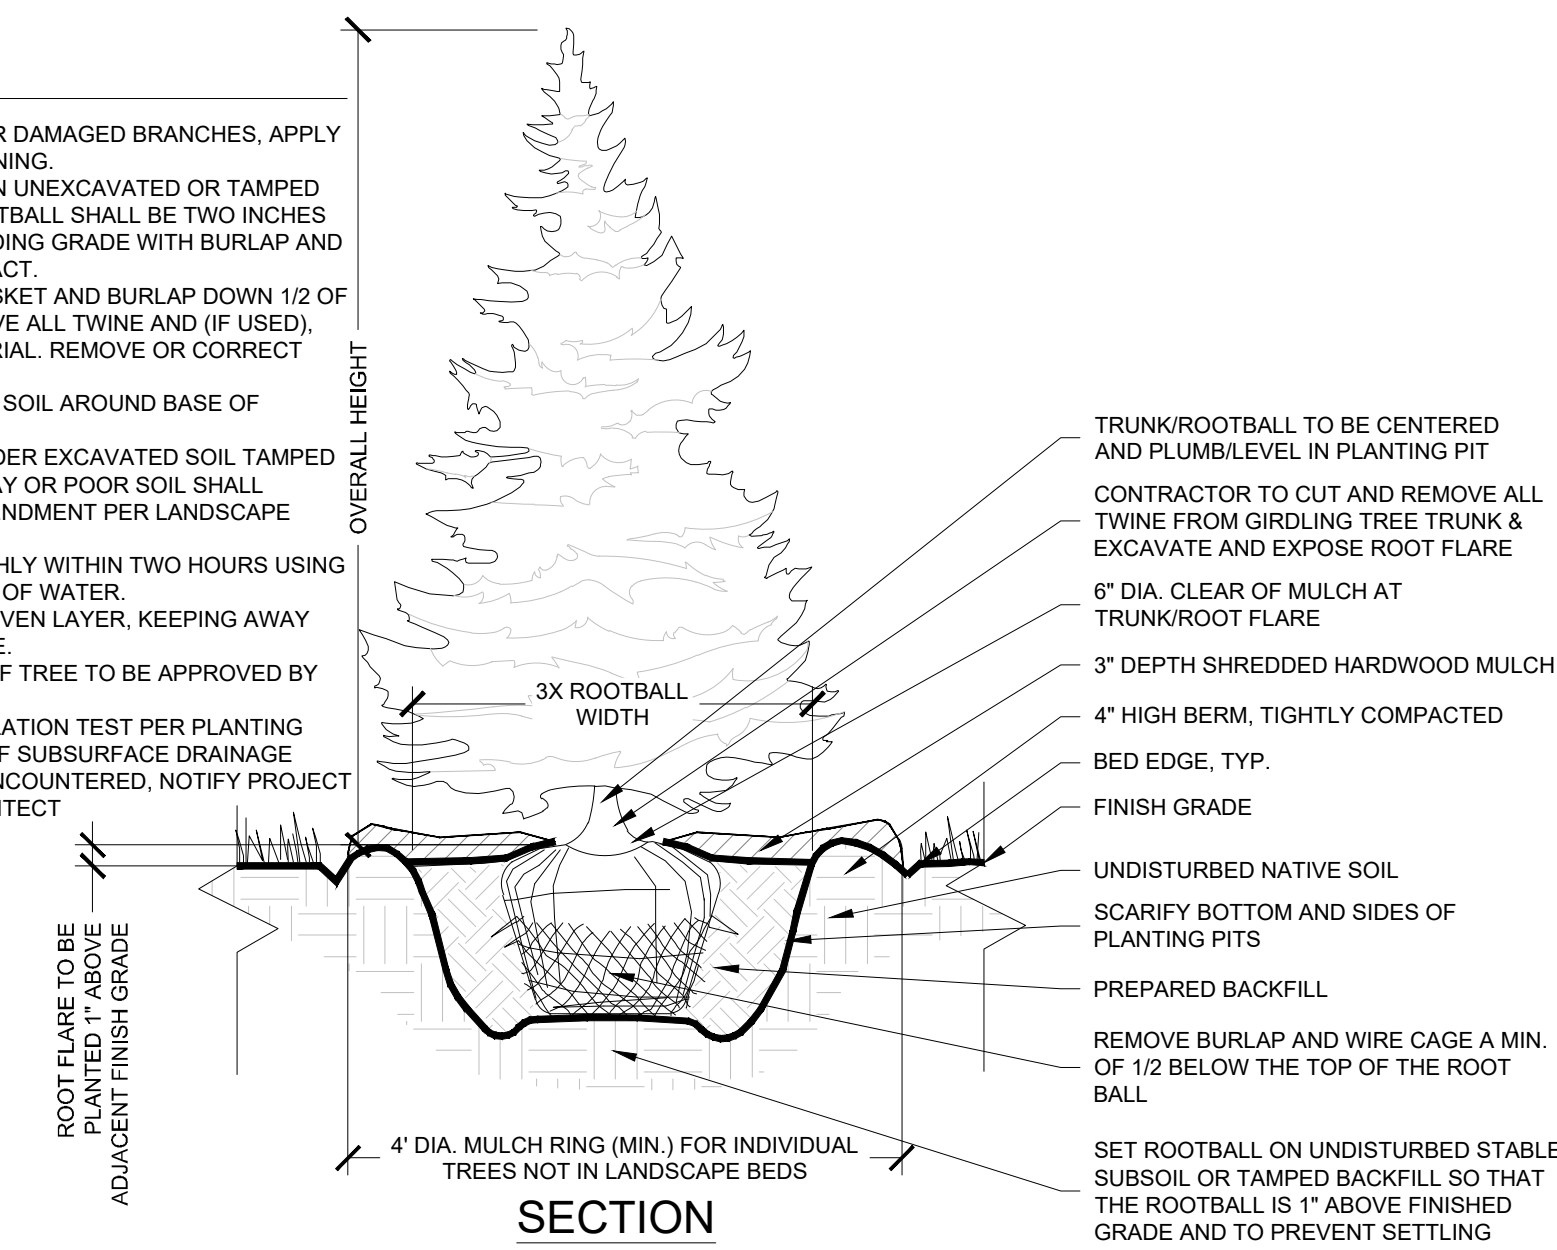


6 EVERGREEN TREE PLANTING

N.T.S.

- NOTES:

1. INSPECT TREE FOR DAMAGED BRANCHES, APPLY CORRECTIVE PRUNING.
2. SET ROOT BALL ON UNEXCAVATED OR TAMPED SOIL. TOP OF ROOTBALL SHALL BE TWO INCHES ABOVE SURROUNDING GRADE WITH BURLAP AND WIRE BASKET INTACT.
3. REMOVE WIRE BASKET AND BURLAP DUNN 1/2 OF ROOT BALL. REMOVE ALL TWINE AND (IF USED), SYNTHETIC MATERIAL. REMOVE OR CORRECT GIRDLING ROOTS.
4. TAMP EXCAVATED SOIL AROUND BASE OF ROOTBALL.
5. BACKFILL REMAINDER EXCAVATED SOIL TAMPED LIGHTLY. HIGH CLAY OR POOR SOIL SHALL RECEIVE SOIL AMENDMENT PER LANDSCAPE NOTES.
6. WATER THOROUGHLY WITHIN TWO HOURS USING 10 TO 15 GALLONS OF WATER.
7. APPLY MULCH IN EVEN LAYER, KEEPING AWAY FROM ROOT FLARE.
8. FINAL LOCATION OF TREE TO BE APPROVED BY OWNER.
9. PERFORM PERCOLATION TEST PER PLANTING SPECIFICATIONS. IF SUBSURFACE DRAINAGE PROBLEMS ARE ENCOUNTERED, NOTIFY PROJECT LANDSCAPE ARCHITECT

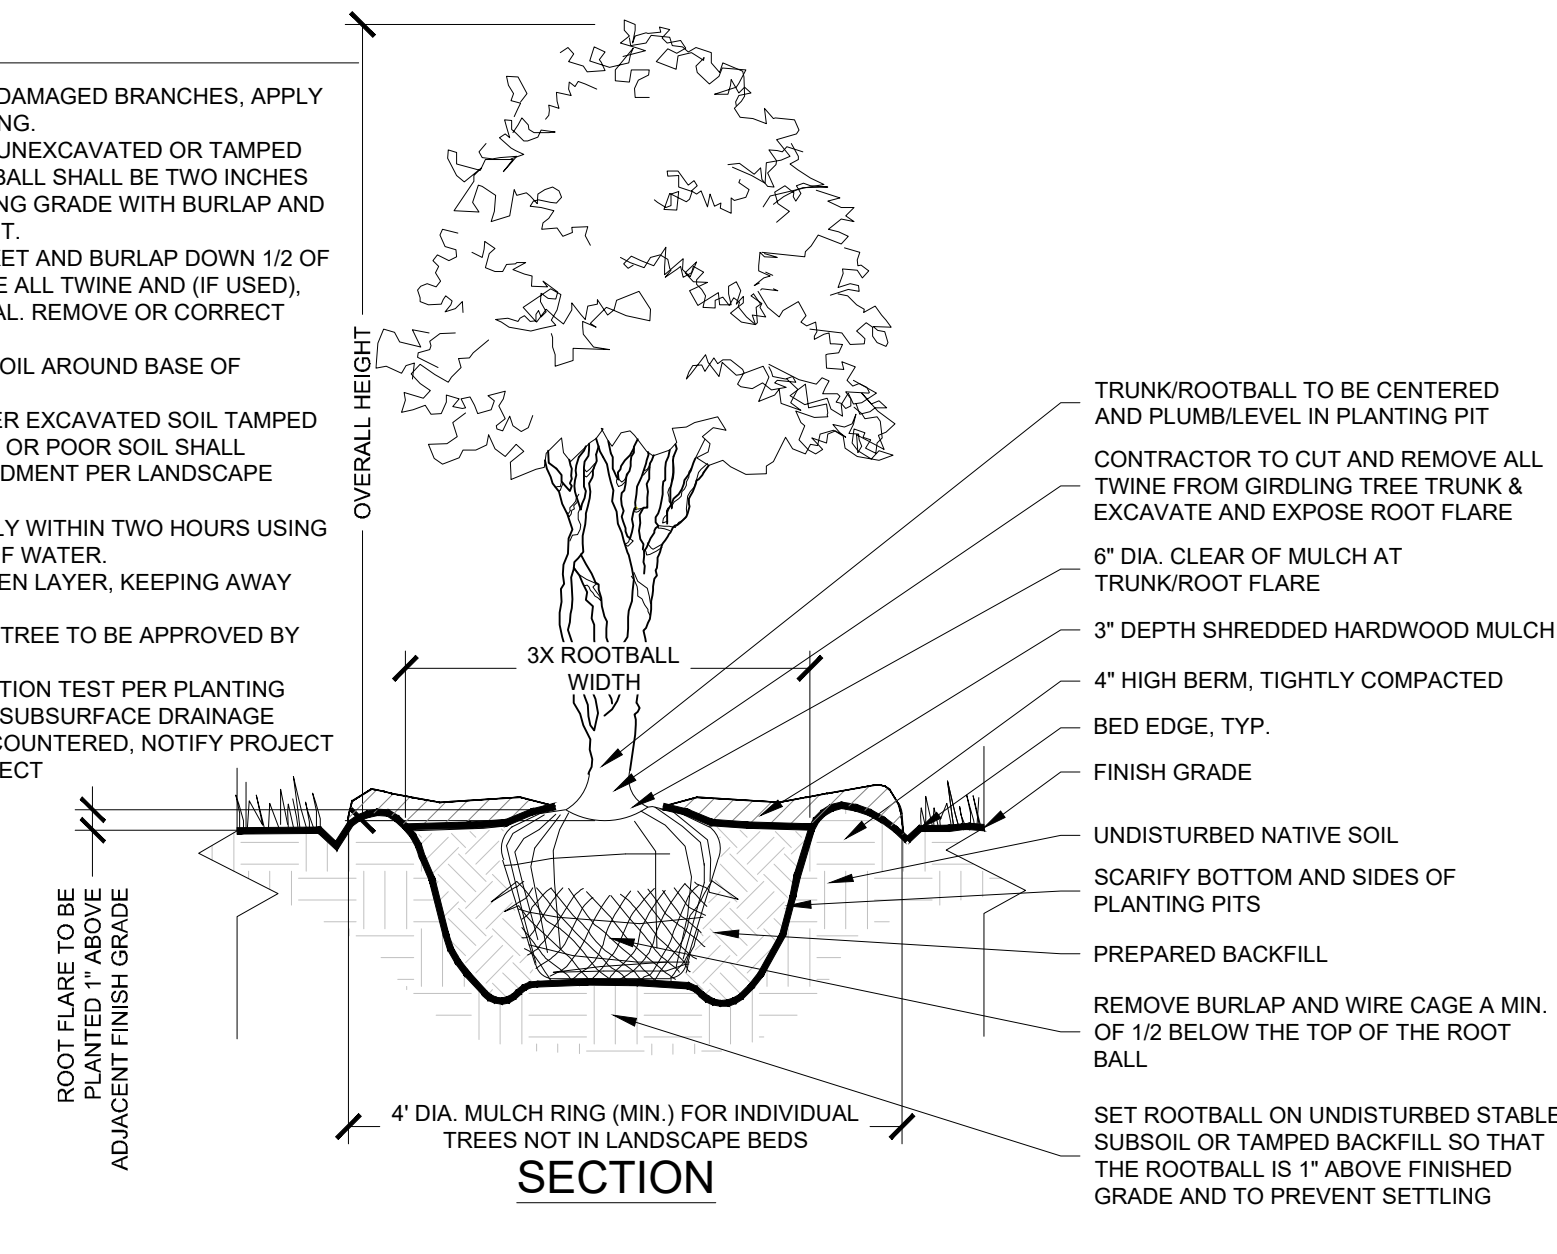

8 MULTI-STEM TREE PLANTING


N.T.S.

159TH & LAGRANGE RETAIL	ILLINOIS	CITY OF ORLAND PARK	LANDSCAPE NOTES AND DETAILS				KHA PROJECT 149621089		LICENSED PROFESSIONAL	<div><h1>Kimley»Horn</h1><p>© 2025 KIMLEY-HORN AND ASSOCIATES, INC. 420 WARRENVILLE, IL 60555 630-487-5500 WWW.KIMLEY-HORN.COM</p></div>				
							DATE	11/14/2025	XXXX					
							SCALE	AS SHOWN	ILLINOIS LICENSE NUMBER					
							DESIGNED BY	###	XXXX					
							DRAWN BY	###	DATE					11/14/2025
SHEET NUMBER L3.1								No.	REVISIONS	DATE	BY			

This document, together with the concepts and designs presented herein, as an instrument of service, is intended only for the specific purpose and client for which it was prepared. Reuse of and improper reliance on this document without written authorization and adaptation by Kinney-Horn and Associates, Inc. shall be without liability to Kinney-Horn and Associates, Inc.

NOTES:


1. APPLY CORRECTIVE PRUNING.
2. SET ROOT BALL OR CONTAINER ON UNEXCAVATED OR TAMPED SOIL. TOP OF ROOTBALL (CONTAINER) SHALL BE ONE INCH ABOVE FINISHED SURFACE.
3. FURNISH AND INSTALL 12" OR DEEPER SHRUBS WITHIN PLANTING BED DIG A DEEPER PIT ONLY FOR THOSE SHRUBS.
4. REMOVE BURLAP FROM TOP HALF THE LENGTH OF ROOTBALL. TWINE AND (IF USED) SYNTHETIC MATERIAL SHALL BE REMOVED FROM CONTAINER AND TOP OF ROOTBALL.
5. REMOVE EXCESSIVE SOIL FROM GROUND SURROUNDING SHRUBS. REMOVE CONTAINER AND LOOSEN ROOTS PRIOR TO INSTALLATION.
6. REMOVE OR CORRECT GIRDLING ROOTS.
7. PLUMB AND BACKFILL WITH AMENDED SOIL PER LANDSCAPE NOTES. WATER THOROUGHLY WITH TWO HOURS.
8. ADVISOR SHALL BE PRESENT TO REMOVE SHRUBS FROM ROOT FLARE. MULCH LIMITS FOR SHRUBS EXTEND TO ALL LIMITS OF PLANTING BED, SEE PLANS FOR BUD LAYOUTS.

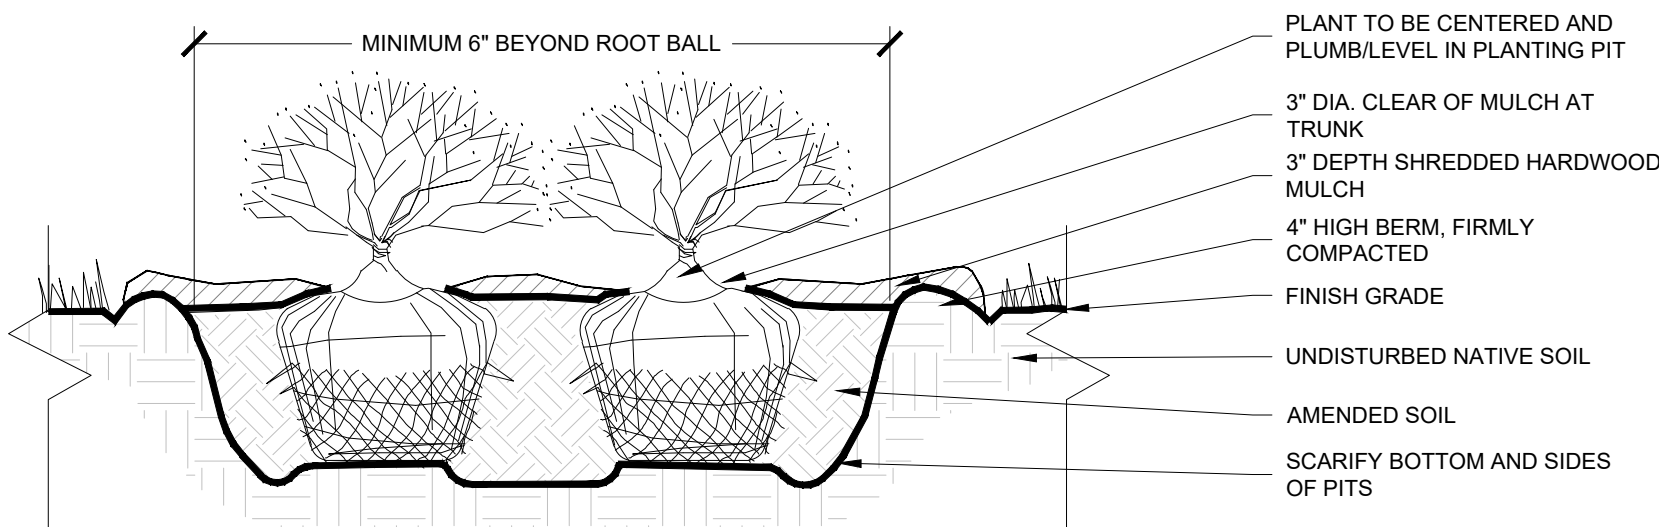

SECTION

SHRUB PLANTING


N.T.S.

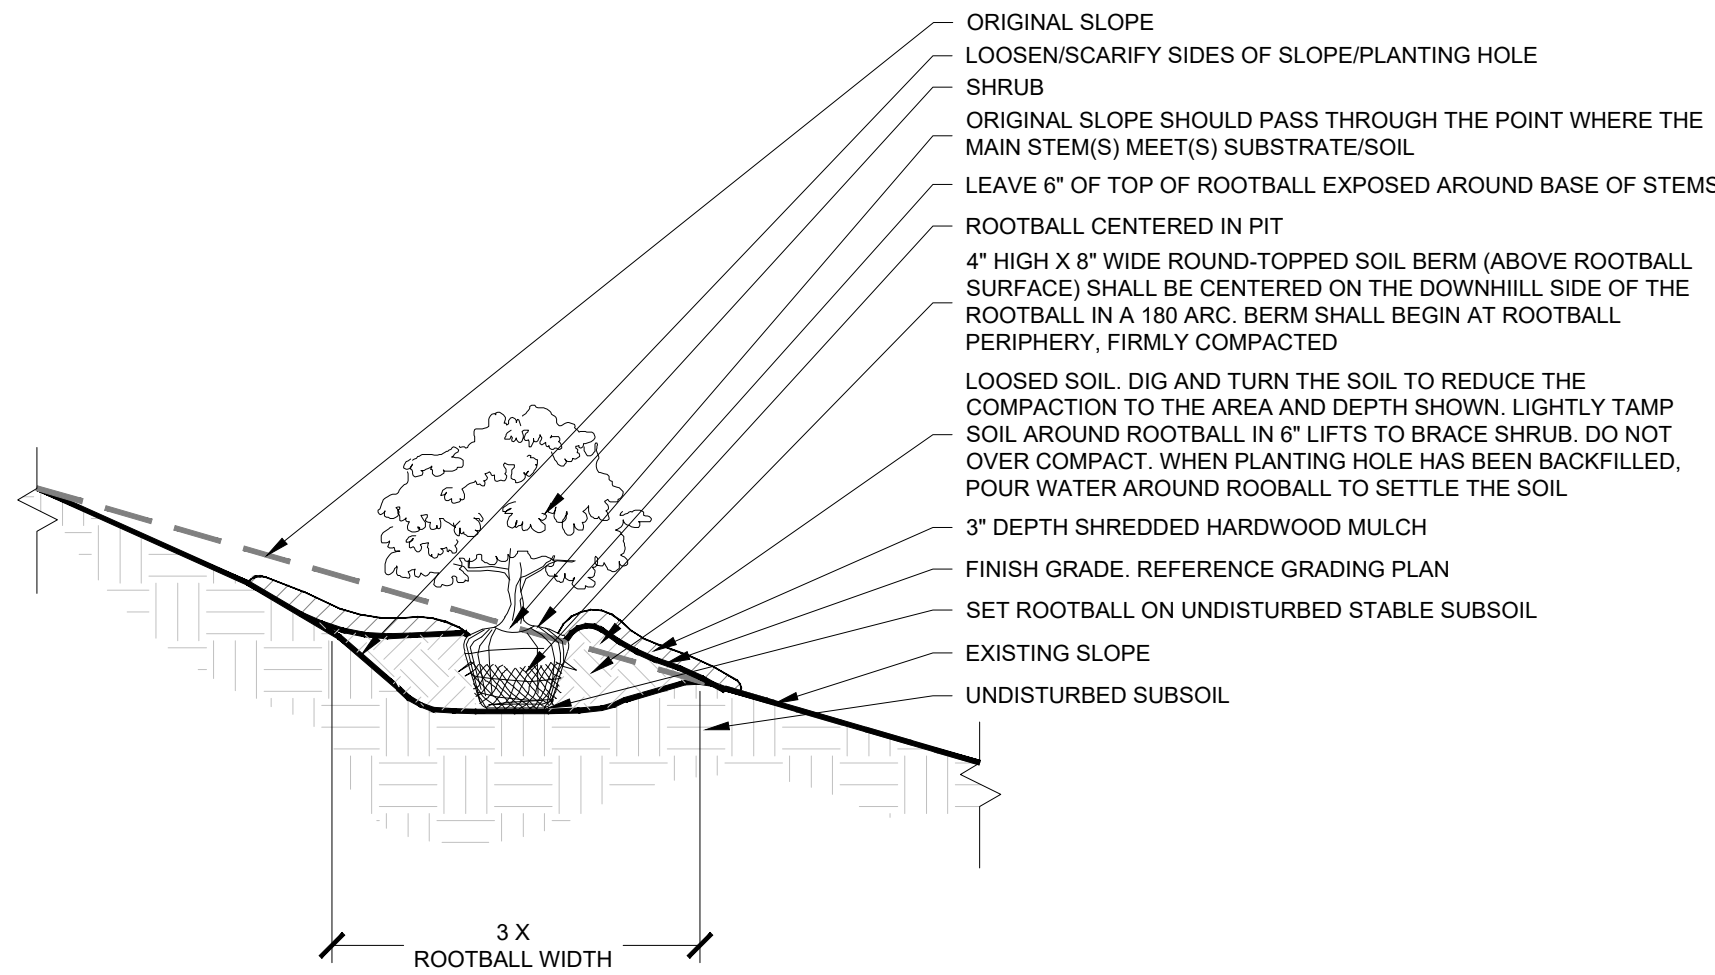

SECTION

11 SHRUB PLANTING ON SLOPE

N.T.S.

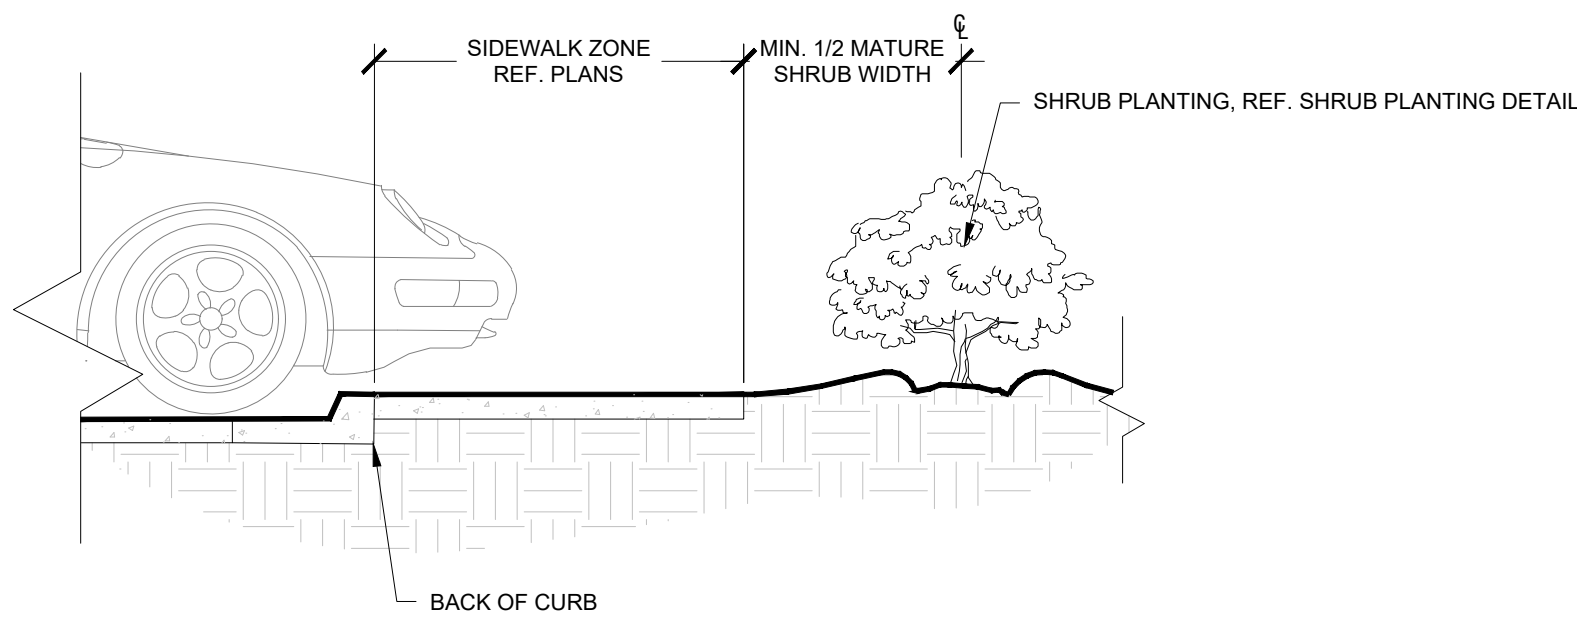


SECTION

12 SHRUB PLANTING AT SIDEWALK

N.T.S.

NOTES:


1. EXCAVATE PLANTING BED.
2. EXCAVATE TO 12" ABOVE FINISH GRADE AND WELL DRAINED
3. REMOVE CONTAINER, SCORE SOIL MASS TO REDIRECT AND PREVENT CIRCLING ROOTS. CORRECT GIRDLING ROOTS.
4. PLANT MATERIAL SHALL BE LAID OUT BY FOLLOWING THE BED EDGE, WORKING TOWARDS THE CENTER OF THE BED USING TRIANGULAR (5-7' MAX) SPACING AS PLAUSIBLE
5. PLUMB AND BACKFILL WITH PLANTING MIX AS SPECIFIED IN LANDSCAPE NOTES.
6. APPLY MULCH IN EVEN LAYER, KEEPING AWAY FROM ROOT FLARE
7. MULCH LIMITS FOR PERENNIALS/GROUNDCOVER EXTEND TO ALL EDGES OF PLANTING BEDS AND AREAS OF PLANT LAYOUTS.
8. SPACING TO BE AS SPECIFIED IN THE PLANT LIST OR AS SHOWN ON DRAWINGS. PERENNIALS SHALL BE PLACED WITH THEIR CENTER 24" FROM EDGE OF BED.

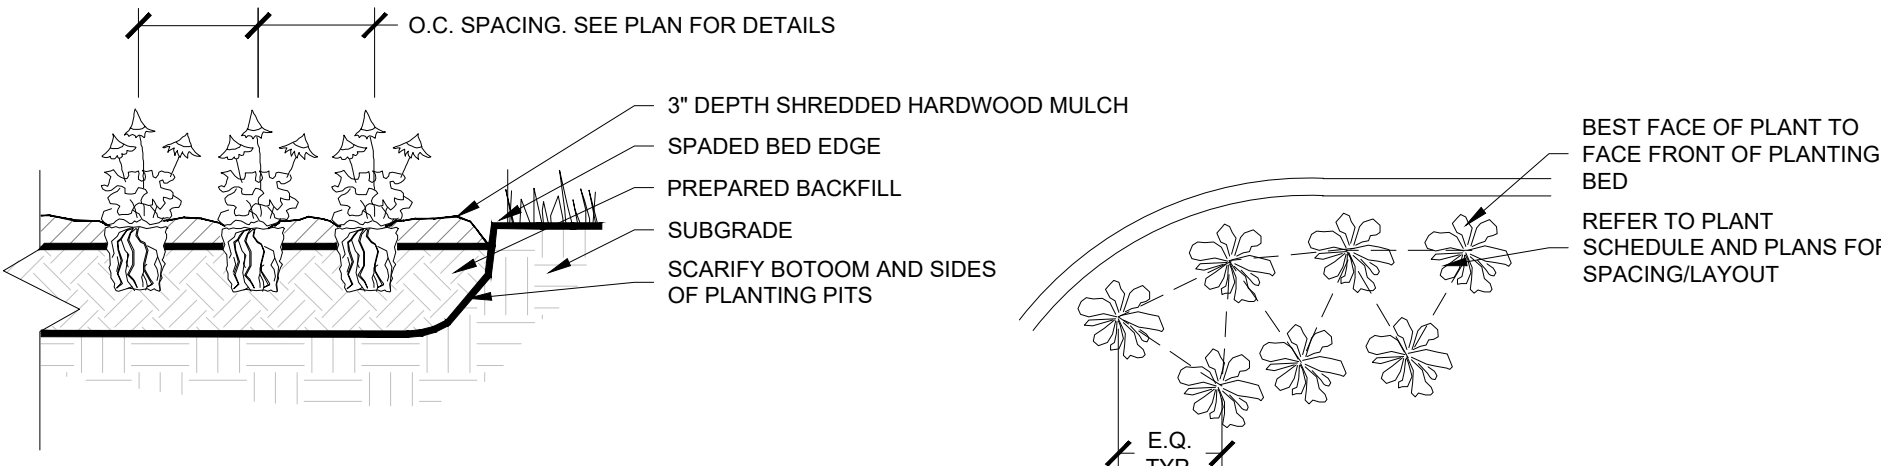

SECTION

10 PERENNIAL PLANTING


N.T.S.

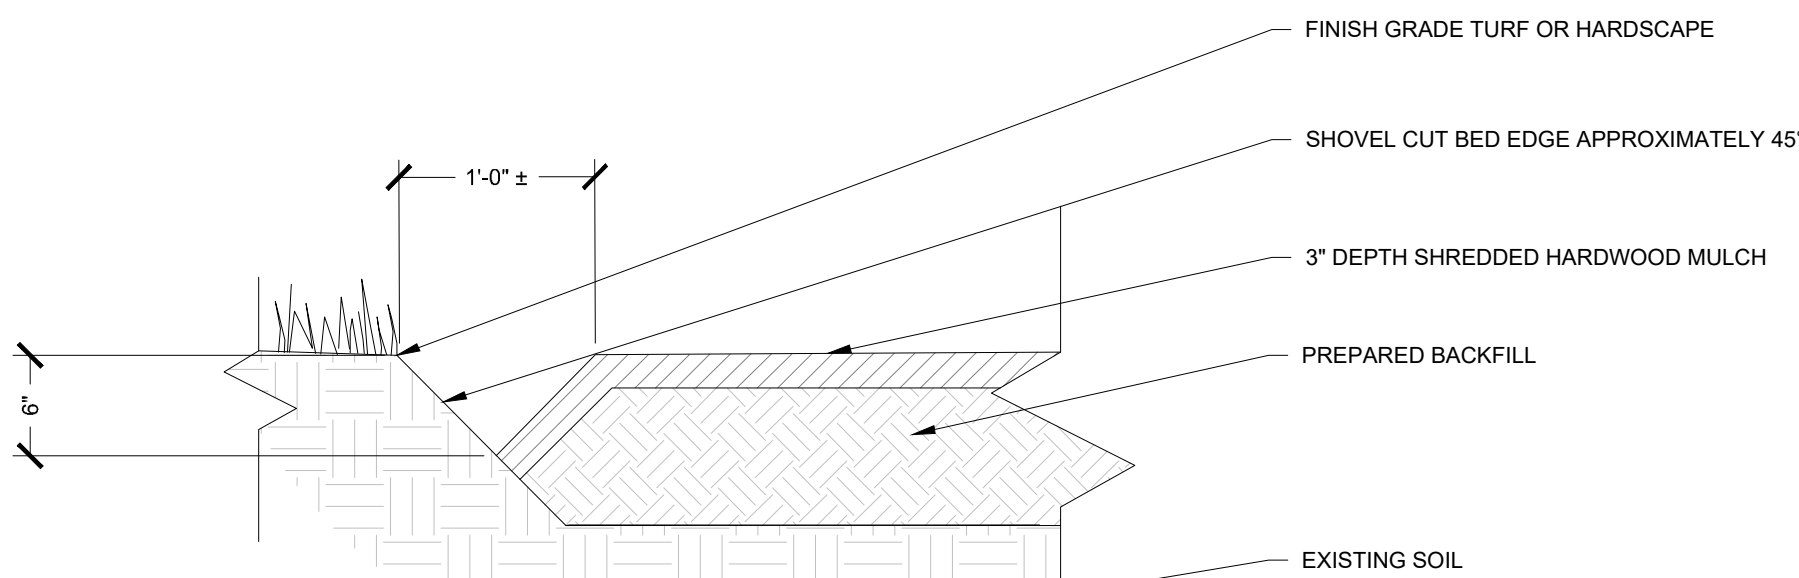

SECTION

12 BED EDGE


N.T.S.

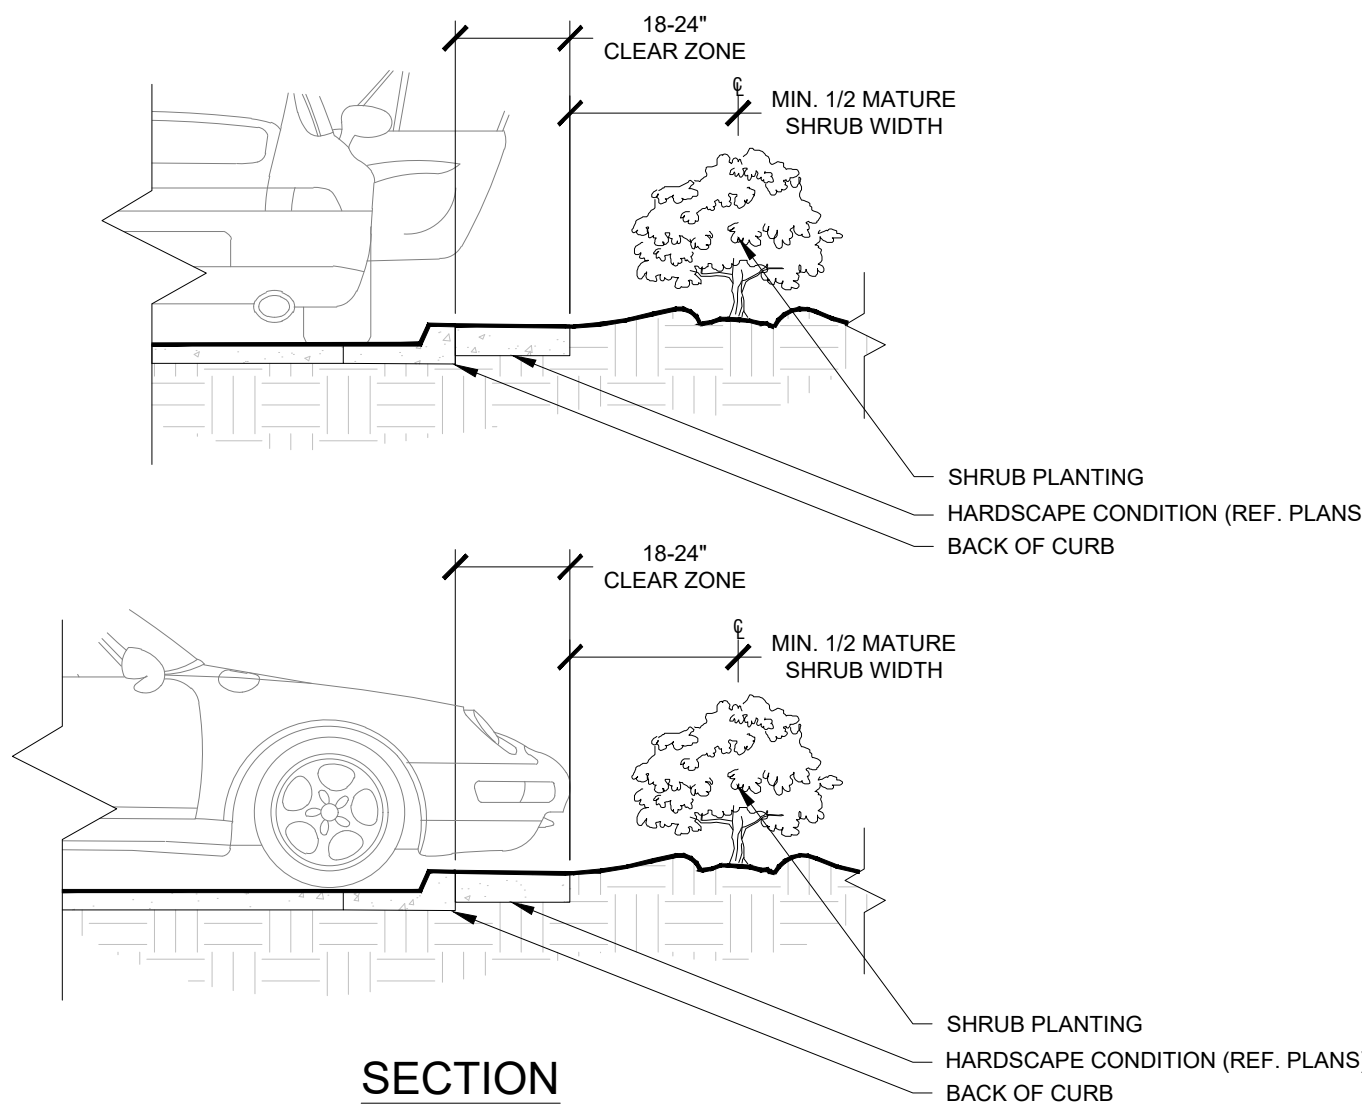

SECTION

1.4 SHRUB PLANTING AT CURB

N.T.S.

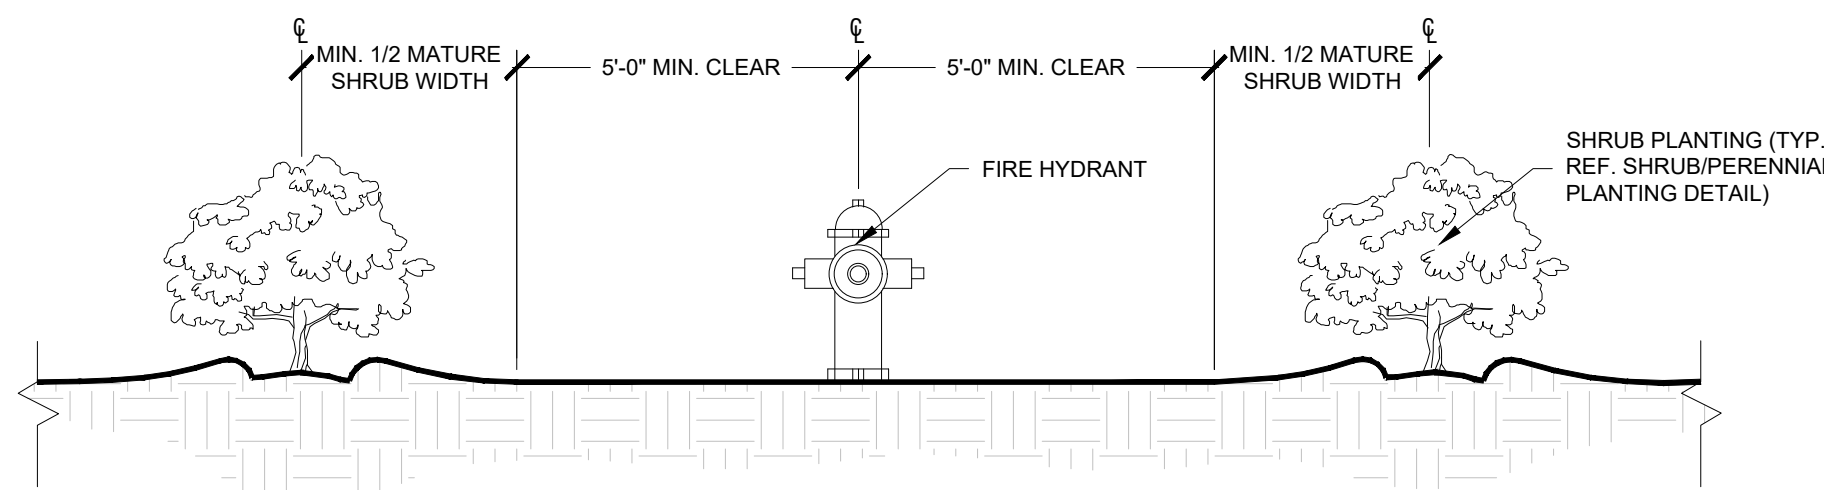

SECTION

15 SHRUB PLANTING AT FIRE HYDRANT

N.T.S.

159TH & LAGRANGE RETAIL		LANDSCAPE DETAILS		KHA PROJECT 149621089		LISCENSED PROFESSIONAL		Kimley»Horn	
CITY OF ORLAND PARK		ILLINOIS		DATE 11/14/2025		XXXX		© 2025 KIMLEY-HORN AND ASSOCIATES, INC. 422 N. WILSON ST. SUITE 600 WARRENVILLE, IL 60555 630-487-5550 WWW.KIMLEY-HORN.COM	
SHEET NUMBER L3.2		SCALE AS SHOWN		DESIGNED BY ###		ILLINOIS LICENSE NUMBER XXXX		No.	
		DRAWN BY ###		CHECKED BY ###		DATE: 11/14/2025		DATE	
								BY	

[illegible]